
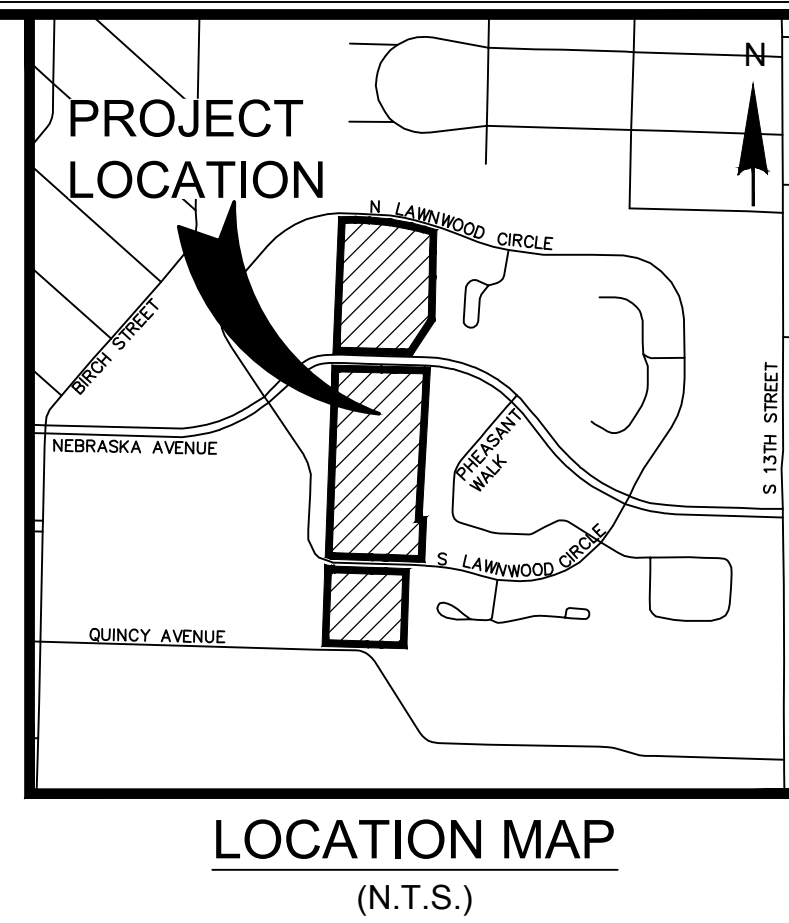
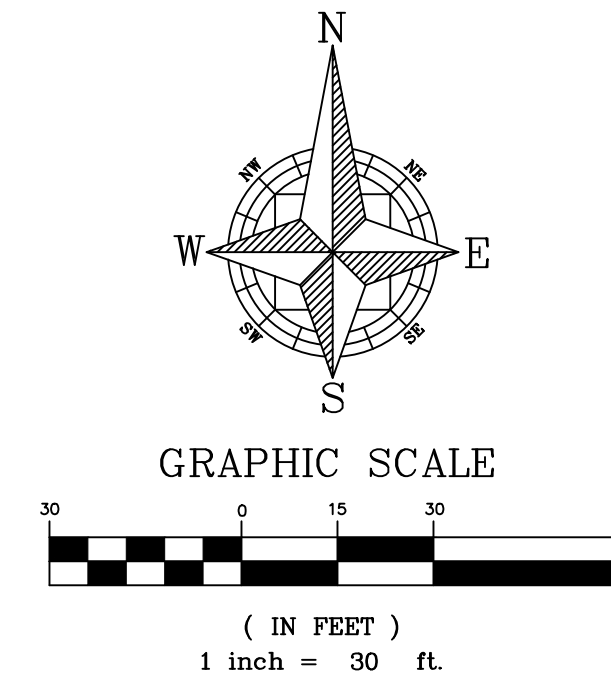


J:\38890\5.9 Drawings\59civil\layouts\38890-PGD ALT.dwg Modified: 3/15/2016 By:becky.williams Plotted By:becky.williams

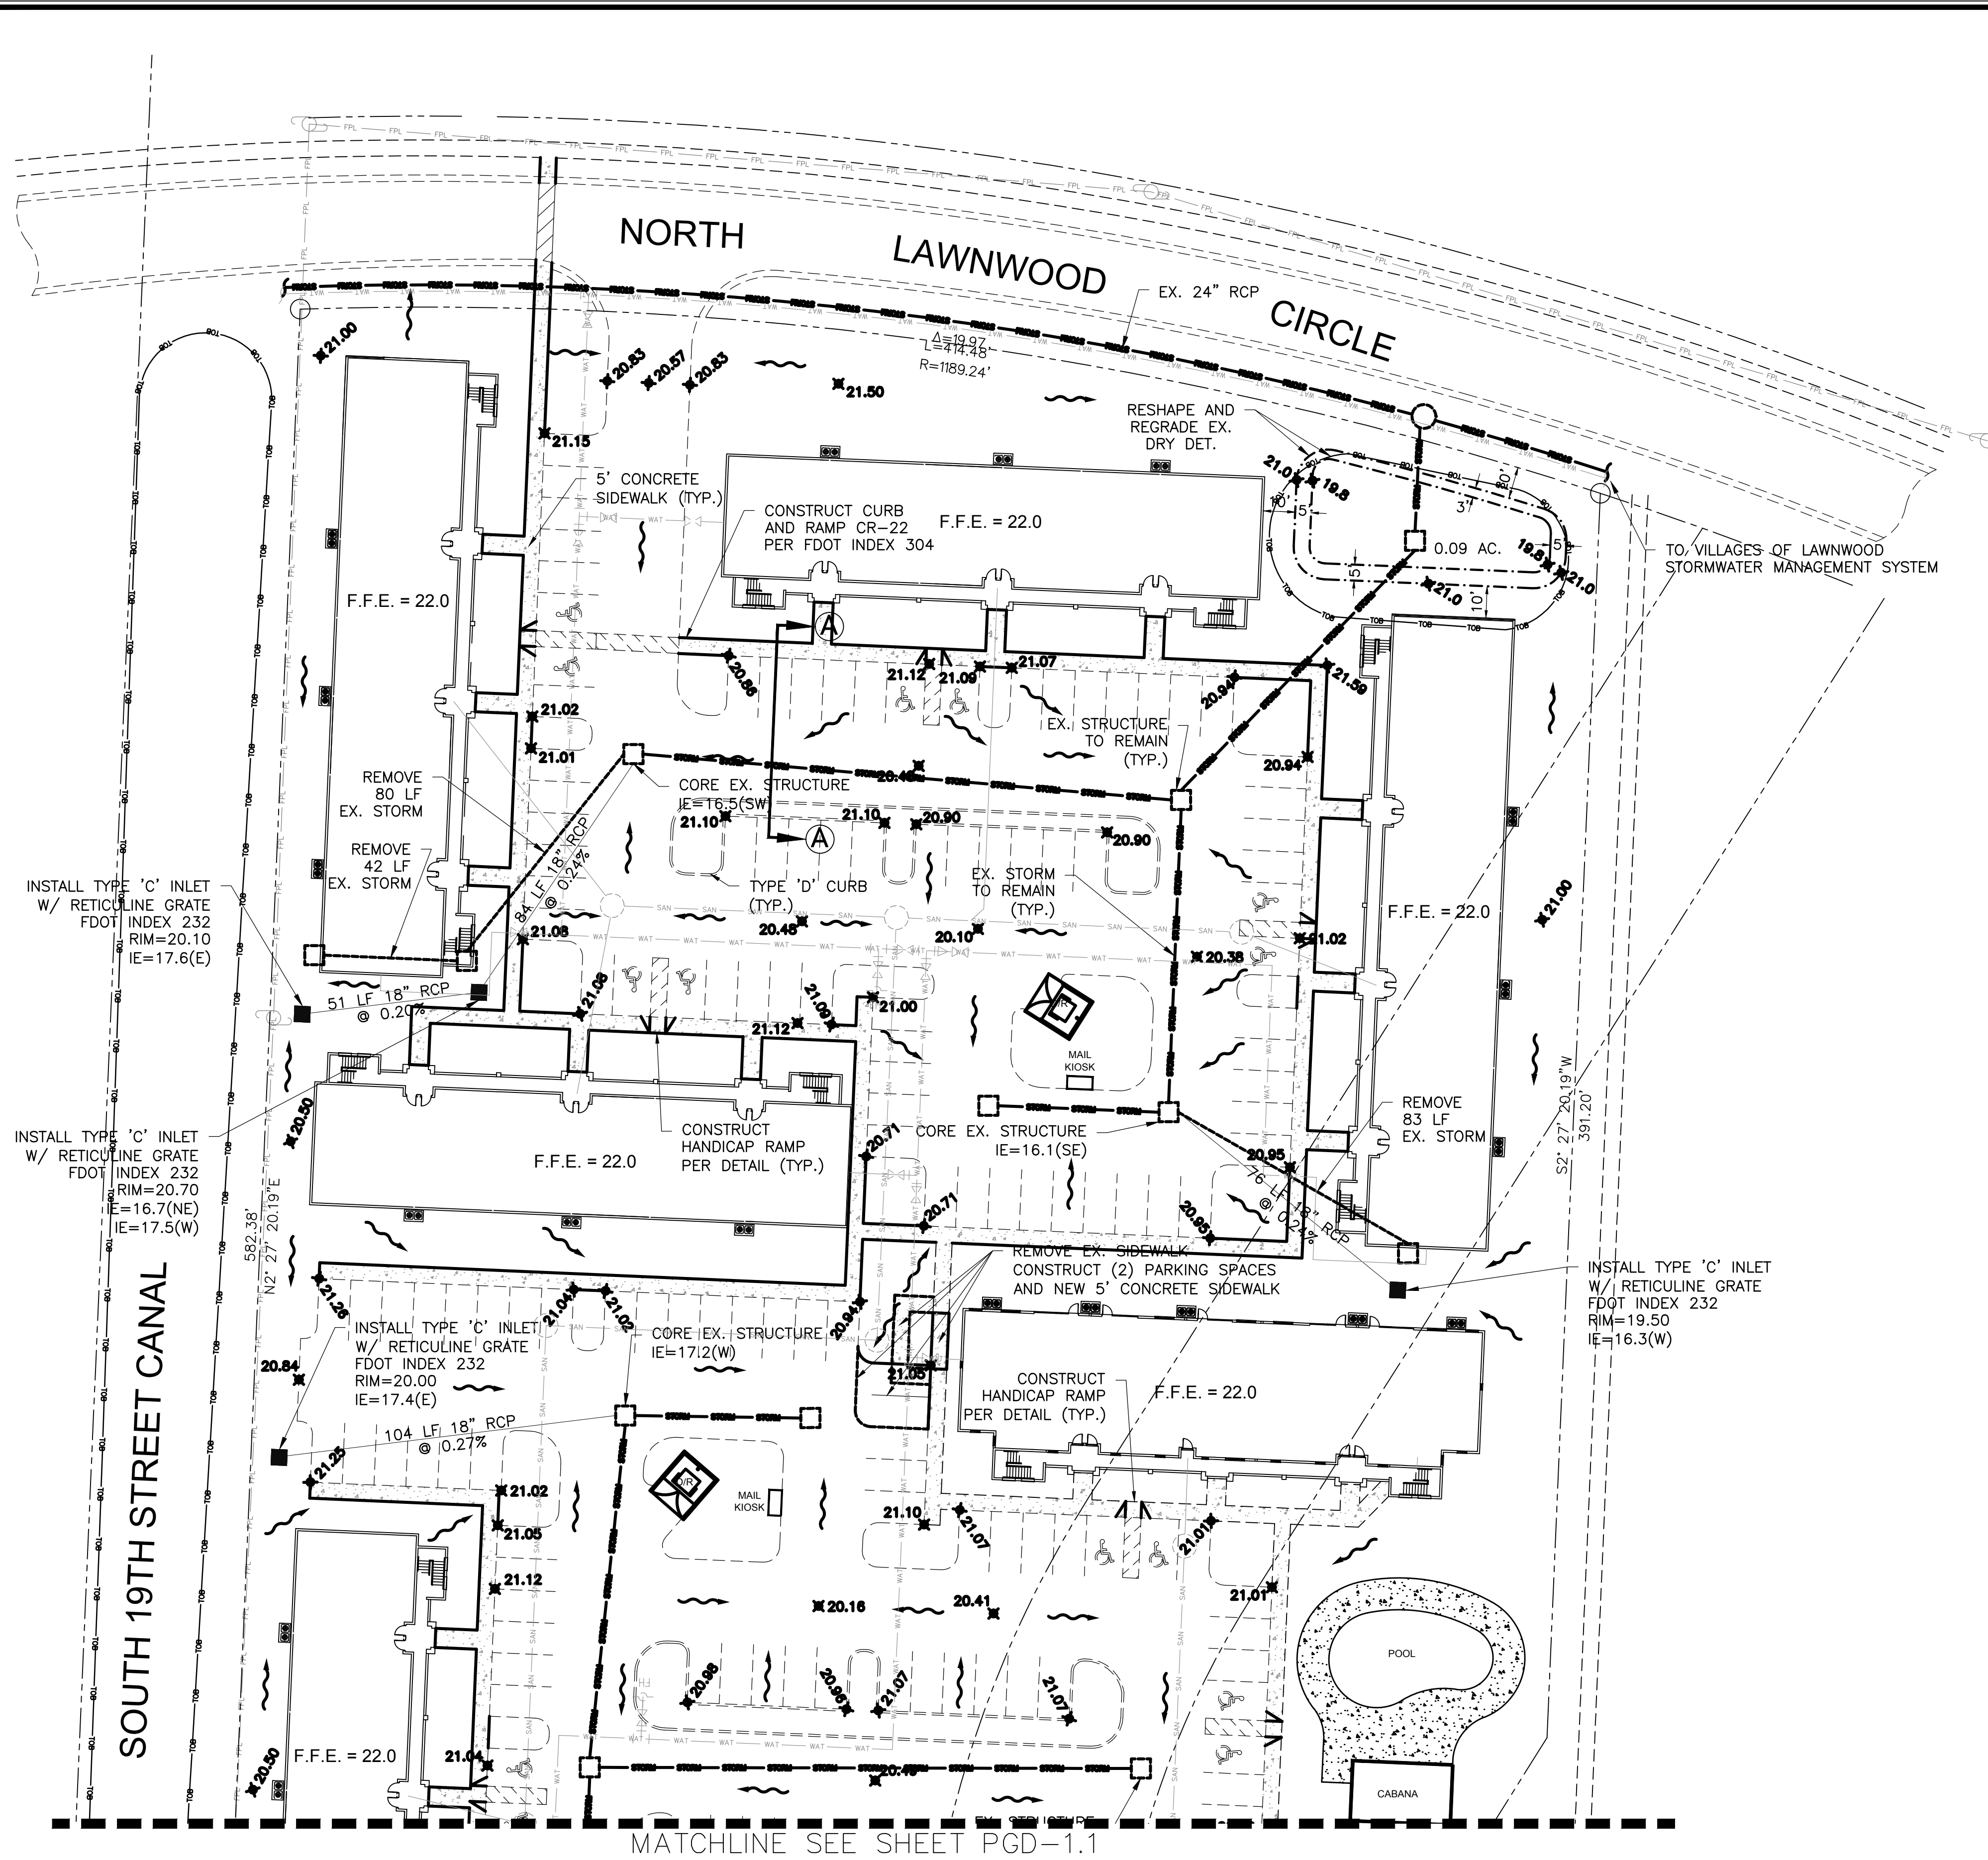

LEGEND

	PROPOSED WATER MAIN
	PROPOSED GATE VALVE
	PROPOSED FIRE HYDRANT ASSEMBLY WITH VALVE
	PROPOSED WATER MAIN FITTINGS (REDUCER, TEE, BENDS)
	EXISTING WATER MAIN
	EXISTING WATER MAIN FITTINGS (TEE, GATE VALVE, REDUCER)
	EXISTING FIRE HYDRANT ASSEMBLY WITH VALVE
	PROPOSED SANITARY SEWER MAIN
	PROPOSED SANITARY SEWER MANHOLE
	EXISTING SANITARY SEWER MAIN
	EXISTING SANITARY SEWER MANHOLE
	PROPOSED STORM SEWER
	PROPOSED STORM CATCH BASIN
	EXISTING STORM SEWER
	EXISTING STORM CATCH BASIN
	PROPOSED GRADE ELEVATION

IBI GROUP (FLORIDA) INC.	
ENGINEERS SURVEYORS LANDSCAPE ARCHITECTS PLANNERS ENVIRONMENTAL CONSULTANTS	2200 PARK CENTRAL BLVD. N. SUITE 101 MAITLAND, FLORIDA 32751 (407) 869-2120 (954) 974-2200
MAYFAIR FORT PIERCE, FLORIDA	POMPAÑO BEACH
PAVING, GRADING AND DRAINAGE PLAN	
SCALE: 1" = 30'	DRAWN: BW
PROJECT: 38890	DESIGNED: RW
SHEET: PGD-1.0	CHECKED: RW
	DATE: 3/15/2016
 FLORIDA ENGINEERING BUSINESS NO. 2966	
NOT FOR CONSTRUCTION	
3/16/16	

