TOWN OF LITTLE ELM

ORDINANCE NO. 1754

AN ORDINANCE OF THE TOWN OF LITTLE ELM, TEXAS, AMENDING THE COMPREHENSIVE ZONING ORDINANCE TO GRANT A NEW SPECIFIC USE PERMIT FOR AN EXISTING AUTOMATIC CAR WASH WITH VACUUMS, ON 1.78 ACRES OF LAND GENERALLY LOCATED ON THE SOUTH SIDE OF WEST UNIVERSITY DRIVE, APPROXIMATELY 500 FEET WEST OF MAGNOLIA BOULEVARD; PROVIDING A PENALTY; PROVIDING A SEVERABILITY CLAUSE; PROVIDING A REPEALER CLAUSE; AND PROVIDING AN EFFECTIVE DATE.

WHEREAS, the Town of Little Elm ("Town") is a home rule municipal corporation organized and existing by virtue of the Constitution and laws of the State of Texas and by its Charter adopted on May 1, 2001; and

WHEREAS, the Town possesses all the rights, powers, and authorities possessed by all home rule municipalities, including the authority to regulate land uses under Chapter 211 of the Texas Local Government Code; and

WHEREAS, Chapter 106 (Zoning) of the Little Elm Code of Ordinances, requires a Specific Use Permit be granted by Town Council in order to legally operate and occupy the subject property with an automatic carwash while it is zoned Light Commercial (LC); and

WHEREAS, a request for a Specific Use Permit for an automatic carwash with vacuums has been submitted by Washguys 13 LLC, on property located approximately 500 feet west of the intersection of Magnolia Blvd. and U.S. Highway 380; and

WHEREAS, Section 106.02.17 of the Little Elm Code of Ordinances provides that Town Council may impose such additional development standards and safeguards as the conditions and locations indicate important to the welfare and protection of adjacent property from noise, vibration, dust, dirt, smoke, fumes, odor, gas, explosion, glare, offensive view, or other undesirable or hazardous conditions: and

WHEREAS, Town Council and the Planning & Zoning Commission of the Town of Little Elm, in compliance with the laws of the State of Texas and the ordinances of the Town of Little Elm, have given the required notices and held the required public hearings and afforded a full and fair hearing to all property owners generally and to all persons interested in and situated in the affected area and in the vicinity thereof regarding the requested planned development amendment described herein; and

WHEREAS, at its regular meeting held on March 7, 2024 the Planning & Zoning Commission considered and made recommendations on a request grant a Specific Use Permit for an automatic carwash with vacuums (Case No. SUP-22-04008); and

WHEREAS, after due deliberations and consideration of the recommendation of the Planning & Zoning Commission and any other information and materials received at the public hearing, the Town Council of the Town of Little Elm, Texas, has determined that the request would be in the interest of public health, safety and welfare of the citizens of the Town of Little Elm.

NOW, THEREFORE, BE IT ORDAINED BY THE TOWN COUNCIL OF THE TOWN OF LITTLE ELM, TEXAS:

SECTION 1. INCORPORATION OF PREMISES. The above and foregoing premises are true and correct and are incorporated herein and made a part hereof for all purposes.

SECTION 2. <u>AMENDMENT</u>. That Ordinance No. 226 of the Town of Little Elm, Texas, the same being the Comprehensive Zoning Ordinance of the Town, as amended, is hereby amended by the following:

- A. Granting a Specific Use Permit authorizing an automatic carwash with vacuums on approximately 1.78 acres of land, generally located on the south side of West University Drive, approximately 500 feet west of Magnolia Boulevard, subject to the following conditions:
 - Prior to the issuance of a Certificate of Occupancy, said Property shall be improved in accordance with the site plan, landscape plan, and façade plans, which are attached hereto as Exhibit A and made a part hereof for all purposes.
 - 2. The Specific Use Permit granted herein specifically for an automated carwash with vacuums as designated on the approved site plan, limited to a 5,980 square foot automated carwash facility with a three-lane approach, eight drive-thru vacuum stands, and 15 drive-up vacuum stations.
 - Prior to obtaining permits for site improvements and new vacuum station installation, property owner must provide executed agreements from all impacted easement owners on the subject property for the allowance to plant and properly maintain the landscaping improvements as shown in the attached exhibits.

SECTION 3. SAVINGS. This Ordinance (which includes the New Zoning Ordinance) shall be cumulative of all other ordinances of the Town, and shall not repeal any of the provisions of those ordinances except in those instances where the provisions of those ordinances are in direct conflict with the provisions of this Ordinance; provided, however, that any complaint, notice, action, cause of action, or claim which prior to the effective date of this Ordinance has been initiated or has arisen under or pursuant to such other ordinance(s) shall continue to be governed by the provisions of that ordinance or those ordinances, and for that purpose that ordinance or those ordinances shall be deemed to remain and shall continue in full force and effect.

SECTION 4. PENALTY. Any person, firm, or corporation violating any of the provision of

this Ordinance shall be punished by a penalty of a fine not to exceed the sum of Two Thousand Dollars (\$2,000) for each offense and each and every day such offense shall continue shall be deemed to constitute a separate offense.

SECTION 5. SEVERABILITY. The sections, paragraphs, sentences, phrases, and words of this Ordinance are severable, and if any section or provision of this ordinance or the application of that section or provision to any person, firm, corporation, situation or circumstance is for any reason judged invalid or unconstitutional, the adjudication shall not affect any other section or provision of this Ordinance or the application of any other section or provision to any person, firm, corporation, situation or circumstance, nor shall adjudication affect any other section or provision of the New Zoning Ordinance of the Town of Little Elm, Texas, and the Town Council hereby declares that it would have adopted the valid portions and applications of this Ordinance (which includes the New Zoning Ordinance) without the invalid parts and to this end the provisions of this Ordinance shall remain in full force and effect.

SECTION 6. <u>REPEALER.</u> That all ordinances of the Town of Little Elm in conflict with the provisions of this Ordinance are hereby repealed to the extent of that conflict.

SECTION 7. EFFECTIVE DATE. This Ordinance shall take effect immediately upon its adoption in accordance with and as provided by law and the Town Charter.

PASSED AND APPROVED by the Town Council of the Town of Little Elm, Texas on the 2nd day of April, 2024.

	The Town of Little Elm, Texas
ATTEST:	Curtis J. Cornelious, Mayor
Caitlan Biggs, Town Secretary	_

ATTACHMENT – EXHIBIT A

PARKING SPACES

P.S. = Parking Spaces

15 = Regular Parking Spaces ' = Handicap Parking Spaces

16 = Total Parking Spaces

AREA CALCULATIO	N TABLE
1 STORY BRICK & STONE BUILDING	5,980 SQ.FT.
1 STORY BRICK BUILDING	273 SQ.FT.
CONCRETE FLATWORK AREA	42,400 SQ. FT
TOTAL COVERED AREA	48,653 SQ.FT.
LANDSCAPE AREA	31,294 SQ.FT.
AWNING AREA	4,896 SQ. FT.
TOTAL LOT AREA	79,947 SQ.FT.
LOT COVERAGE PERCENTAGE	60%
TOTAL ACRES AREA	1.84

LEGEND

CM CONTROLLING MONUMENT 5/8" IRON ROD FOUND X" FOUND IN CONCRETE O POINT FOR CORNER FO FIBER OPTIC PEDESTAL

POWER POLE A/C AIR CONDITIONING

W WATER VALVE SIGN


(W) WATER METER (T) TELE. MANHOLE ⟨T⟩ TELE. VAULT | VACUUM

☆ LP LIGHT POLE ▲ UNDERGROUND ELECTRIC ♠ FH FIRE HYDRANT G GAS METER BOLLARD

CONCRETE WOOD COVERED CARPORT, PORCH, DECK, ETC OHT — OVERHEAD TELEPHONE OHP — OVERHEAD ELECTRIC - W- W- WETAL FENCE
- WOOD FENCE
S SANITARY SEWER MANHOLE

(D) STORM DRAIN MANHOLE HANDICAP PARKING ELECTRIC BOX C CLEANOUT TELEPHONE PEDESTAL TV CABLE PEDESTAL

// //_ ASPHALT PAVING GRAVEL/ROCK A A A ROAD OR DRIVE

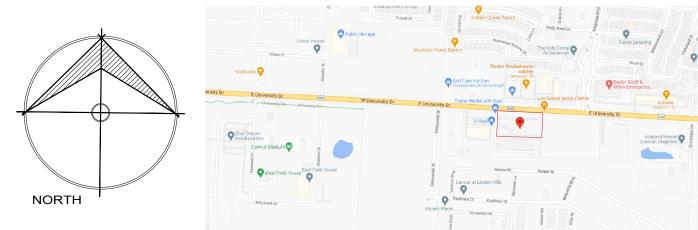

VICINITY MAP FOR REFERENCE ONLY

PROJECT: COMMERCIAL FLATWORK ADDITION

OWNER: JOHN PAPPAS

LOCATION:

26780 US-380 HWY. LITTLE ELM, TEXAS 75068



Gamma Group, Design & Construction LLC 3309 ELM ST. #250, Dallas Texas, 75226 www.gammagroup-usa.com

gamma_fredi@hotmail.com (469)583-7174,(469)463-276, (214)272-8186

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ENGINEERING GENERAL NOTES

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NOTE:

GENERAL CONTRACTOR SHALL HAVE THIS FOUNDATION PLAN DESIGN BY A TEXAS

REGISTERED ENGINEER TO MEET SOIL TESTS REQUIREMENTS. THE DESIGNER ASSUMES NO LIABILITY FOR ANY STRUCTURE CONSTRUCTED FROM THIS PLAN IT IS THE RESPONSABILITY OF THE PURCHASER, OF THIS PLAN, TO PERFORM THE FOLLOWING BEFORE ACTUAL CONSTRUCTION COMMENCES.

1.- BUILDER OR CONTRACTOR MUST VERIFY ALL DIMENSIONS PRIOR TO 1.- BUILDER OR CONTRACTOR MUST VERIFY ALL DIMENSIONS PRIOR TO PROCEEDING WITH CONSTRUCTION.
2.- BUILDER OR CONTRACTOR MUST VERIFY COMPLIANCE WITH ALL LOCAL BUILDING CODES OF THE AREA WHERE THE STRUCTURE IS TO BE CONSTRUCTED AND LOCATED.
3.- PLANS INDICATE LOCATIONS ONLY: ENGINEERING ASPECTS SHOULD BE INCORPORATED TO ACTUAL SITE CONDITIONS.

CONTRACTOR NOTES

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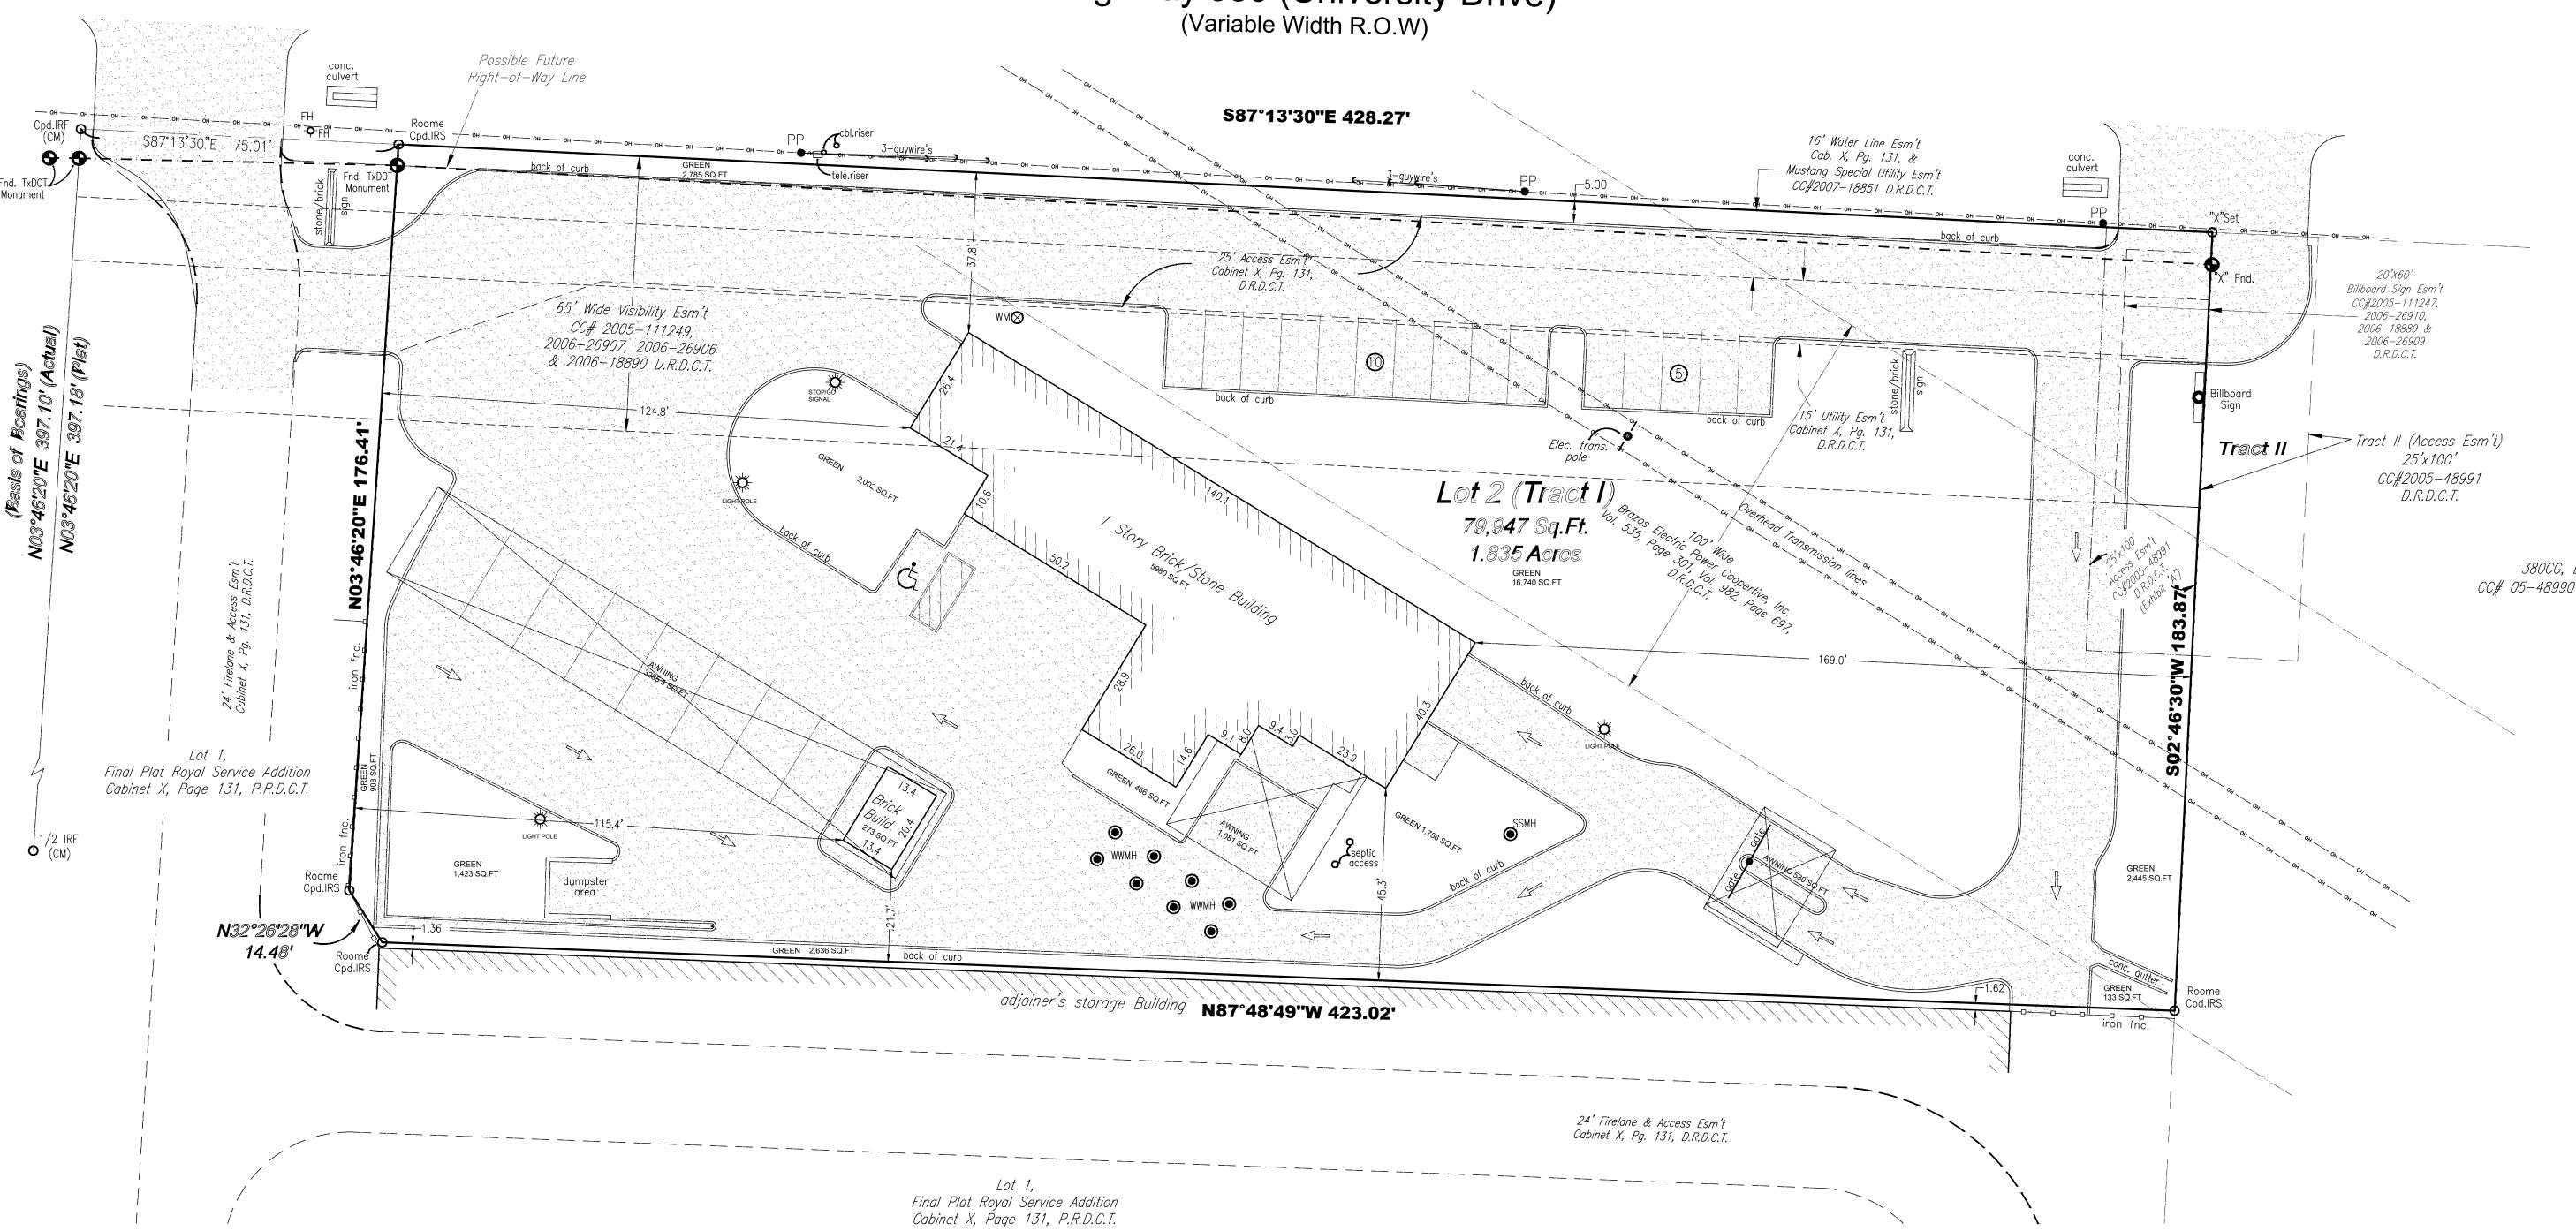
EXPIRATION DATE:

SITE PLAN EXISTING

05/24/2022 DRAWN BY: F.G.M.


SHEET 01 OF 08

U.S. Highway 380 (University Drive)
(Variable Width R.O.W)



SITE PLAN (E) SCALE: 1"= 20'

GRAPHIC SCALE: 1 INCH = 20 FEET

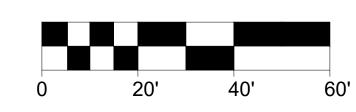

TITLE SITE PLAN **ROYAL SERVICE ADDITION** LOT 2 (TRACT I) JOSE GONZALES SURVEY, ABSTRACT No. 447 26780 U.S. HIGHWAY 380 TOWN OF LITTLE ELM, DENTON COUNTY, TEXAS **SEPTEMBER 29,2017**

PARKING SPACES

P.S. = Parking Spaces

15 = Regular Parking Spaces 1 = Handicap Parking Spaces


SITE PLAN (P)

SCALE: 1"= 20'

16 = Total Parking Spaces

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CONCRETE FLATWORK ADDITION	2,539 SQ. FT
TOTAL COVERED AREA	51,192 SQ.FT.
LANDSCAPE AREA	28,755 SQ.FT.
AWNING AREA	4,896 SQ. FT.
TOTAL LOT AREA	79,947 SQ.FT.
LOT COVERAGE PERCENTAGE	64%
TOTAL ACRES AREA	1.84

GRAPHIC SCALE: 1 INCH = 20 FEET

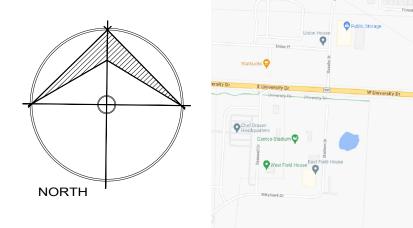

VICINITY MAP FOR REFERENCE ONLY

PROJECT: FLATWORK ADDITION OWNER: JOHN PAPPAS LOCATION:

26780 US-380 HWY. LITTLE ELM, TEXAS 75068

COMMERCIAL



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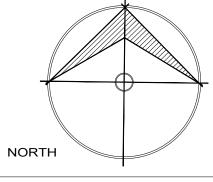
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LEGEND

CM C	ONTROLLING MONUMENT	4	CONCRETE
O 5	/8" IRON ROD FOUND		BUILDING
⊠ "×	" FOUND IN CONCRETE		CONCRETE SLAB ADDITION
0	POINT FOR CORNER	\geq	COVERED CARPORT
FO	FIBER OPTIC PEDESTAL	OHF	OVERHEAD ELECTRIC
0	POWER POLE	_#_	##PIPE FENCE
A/C	AIR CONDITIONING	_₽	ი—ი-METAL FENCE
W	WATER METER	_//-	//—//—WOOD FENCE
T	TELE. MANHOLE	S	SANITITARY SEWER MANHO
	TELE. VAULT	©	STORM DRAIN MANHOLE
V	VACUUM	Ġ	HANDICAP PARKING
₩LP	LIGHT POLE	E	ELECTRIC BOX
A UN	DERGROUND ELECTRIC	©	CLEANOUT
□ ○ FH	FIRE HYDRANT	Т	TELEPHONE PEDESTAL
©	GAS METER	TV	CABLE PEDESTAL
V	WATER VALVE	111	// ASP/HALT PAVING/ GRAVE

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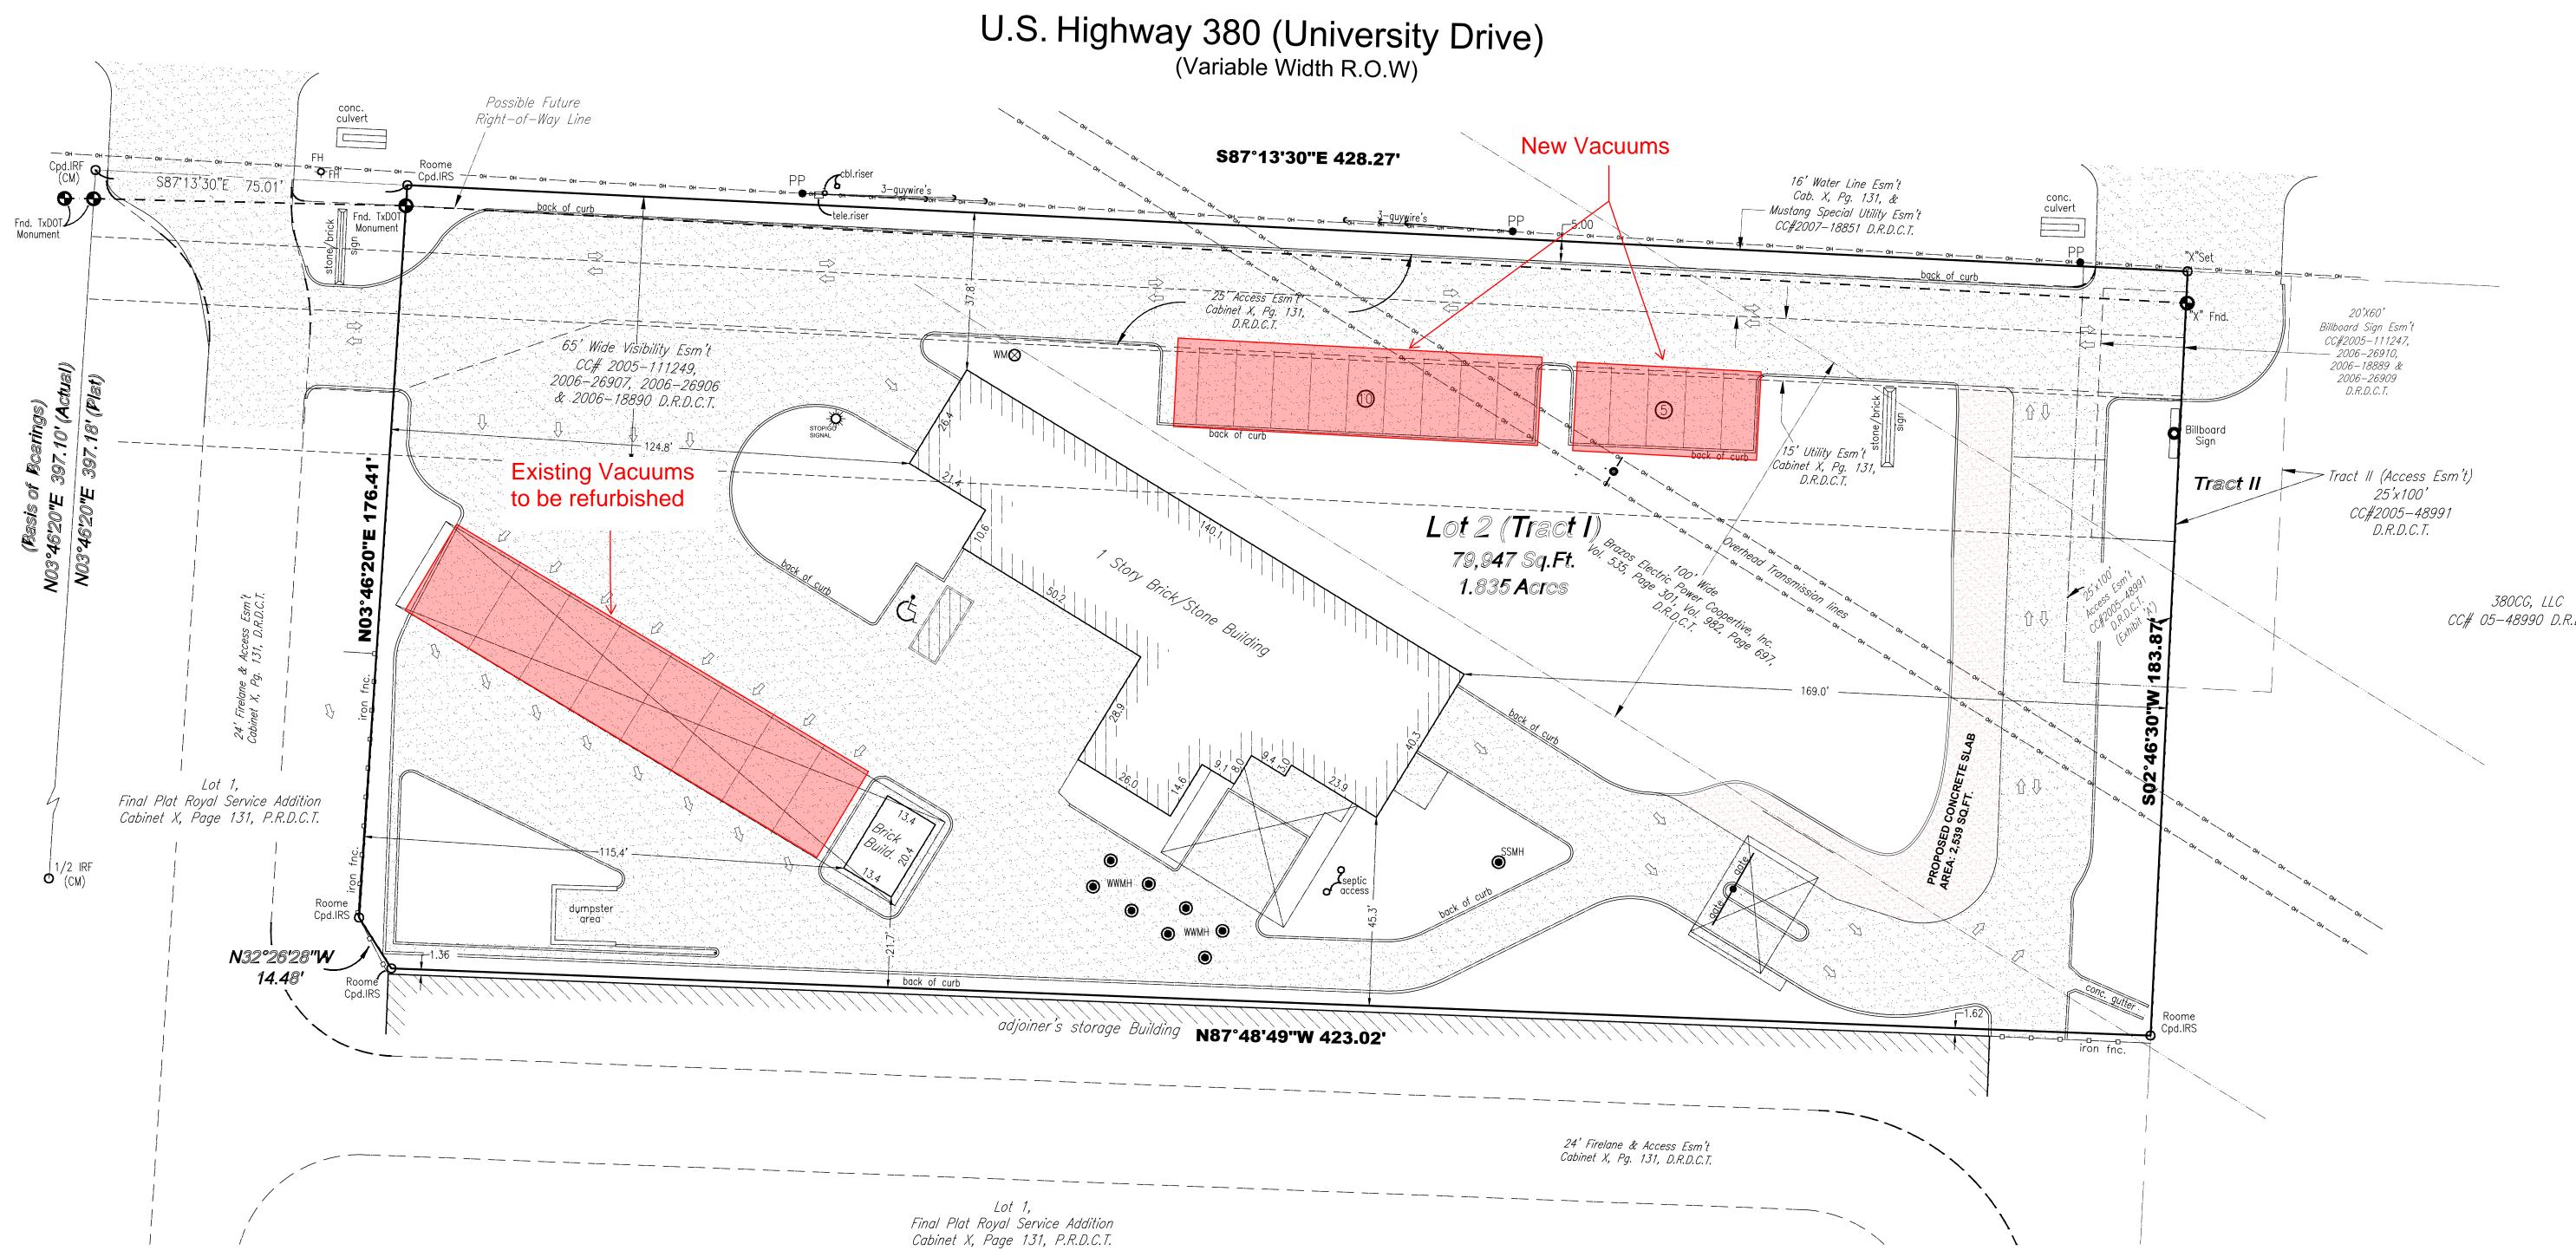


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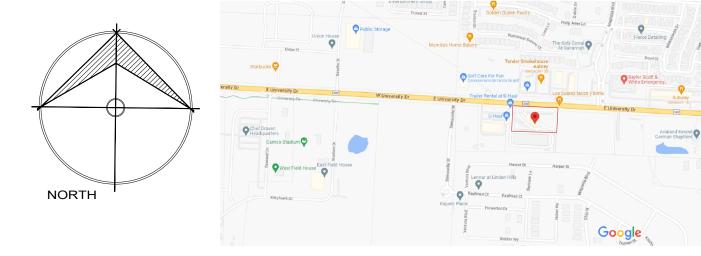
EXPIRATION DATE:

SITE PLAN PROPOSAL

F.G.M. SHEET 02 OF 08



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COMMERCIAL FLATWORK ADDITION

OWNER: JOHN PAPPAS

LOCATION:

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REGISTERED ENGINEER TO MEET SOIL TESTS REQUIREMENTS

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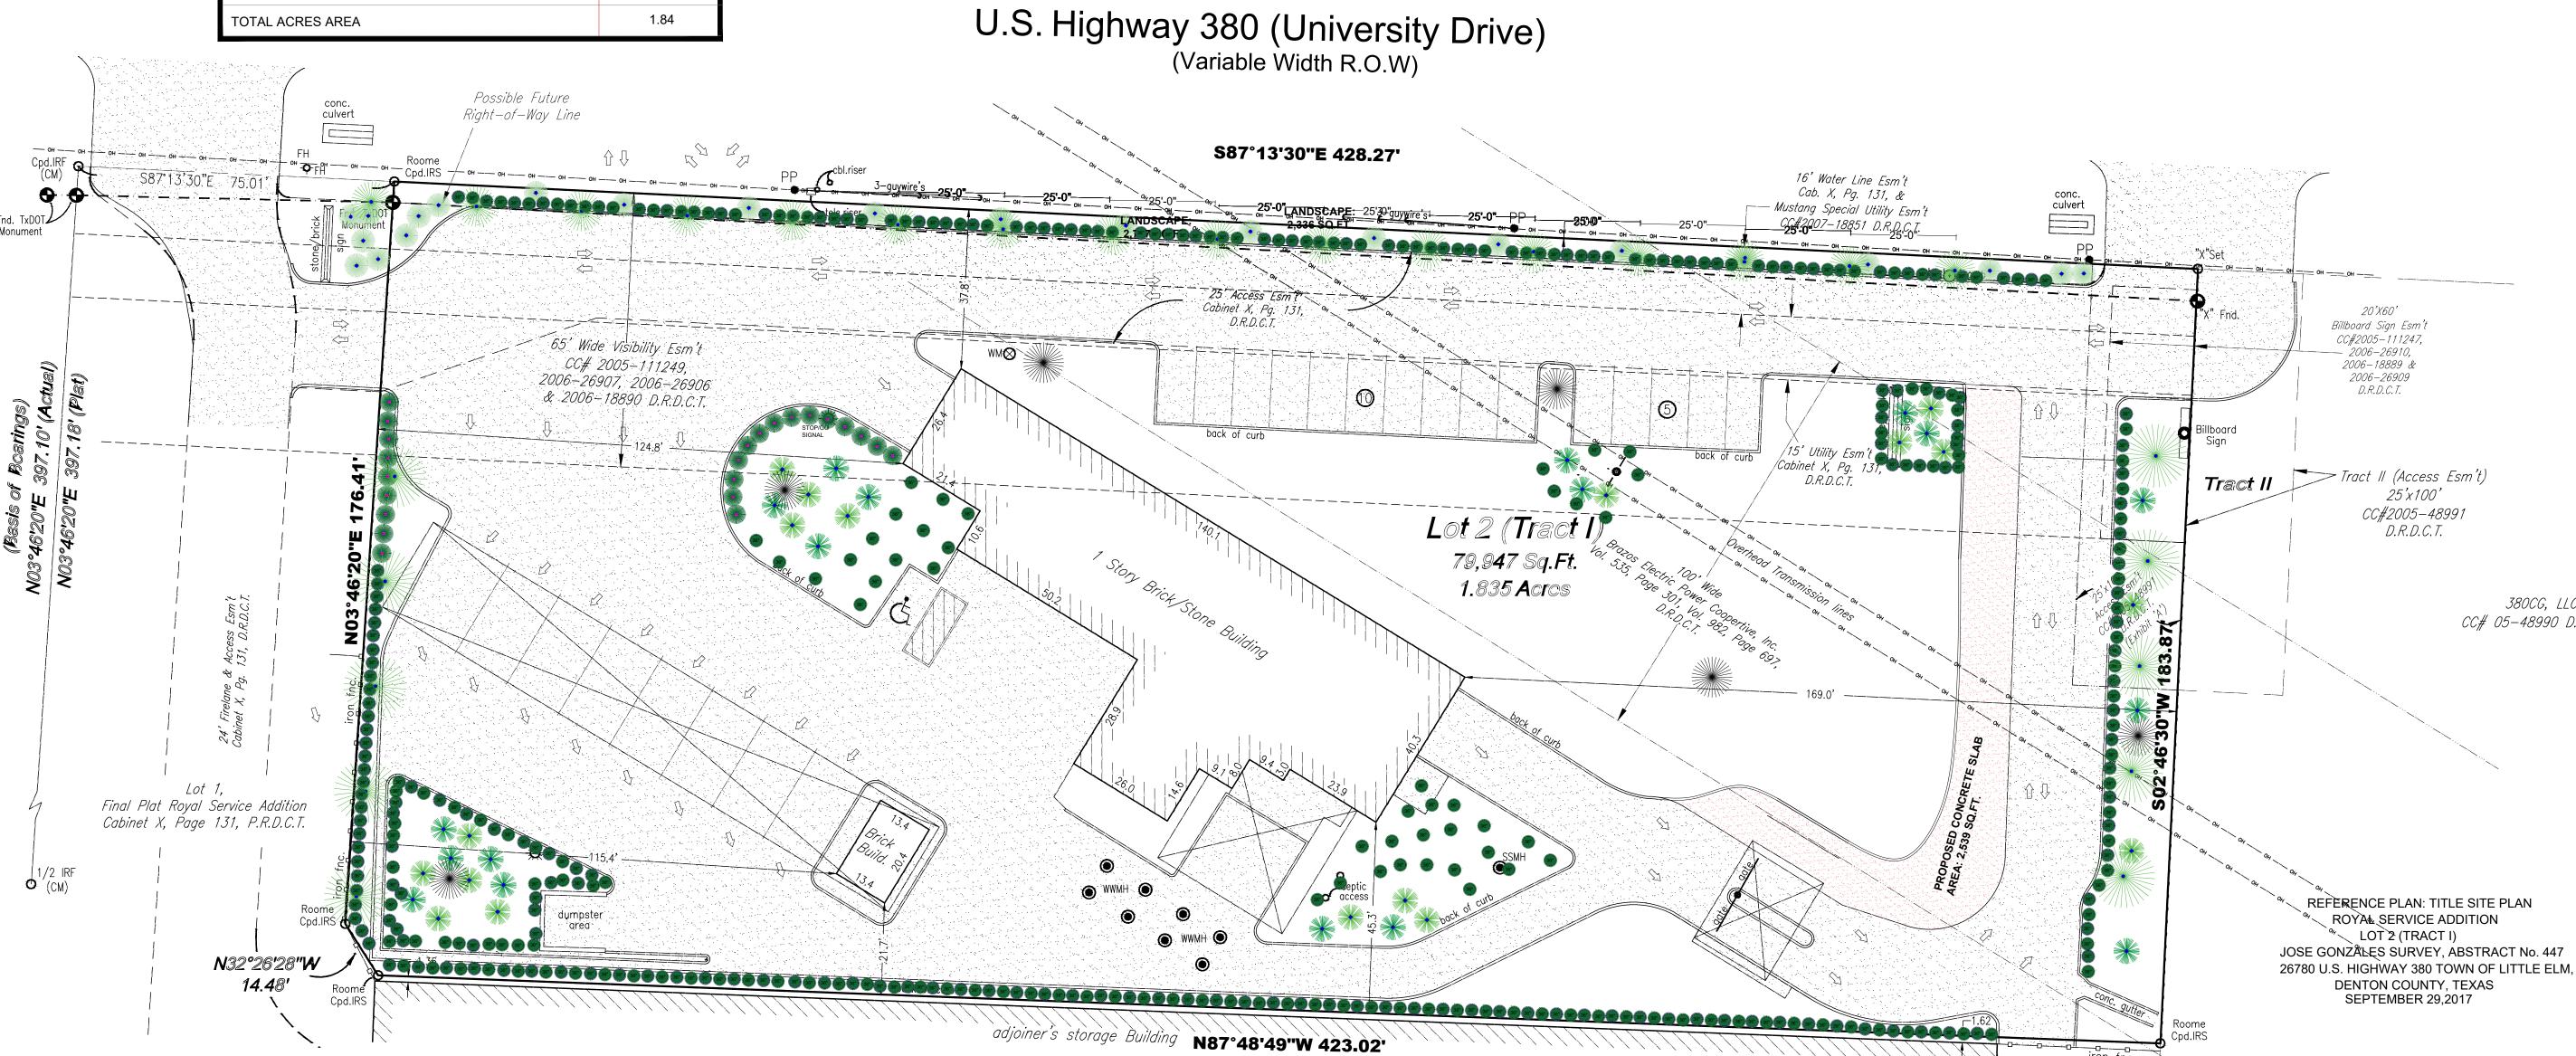
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2. BUILDING CODESOF THE AREA WHERE THE STRUCTURE IS TO BE CONSTRUCTED AND LOCATED.

3. PLANS INDICATE LOCATIONS ONLY:
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CONTRACTOR NOTES

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List of materials provided for the installation of landscaping in the lot

A.-Shrubs: Includes a variety of ornamental plants, shrubs that are suitable for Texas climate and conditions. This may include native plants adapted to

B.-Soil and compost: To prepare the soil and improve its quality, this will help enrich the soil and provide nutrients to the plants.

C.-Stones and gravel: Decorative stones and gravel are used to create paths, paths and accent areas in the garden.

D.-Mulch: Mulch is used to cover the soil around plants and trees. It helps retain moisture, control weeds and improve the appearance of the garden.

E.-Wood or edge stone: To delimit and define areas in the garden, use wood or stone edges. These materials provide structure and an aesthetic

appearance to the garden.

F.-Irrigation system: To keep plants properly hydrated, need to install an irrigation system. It can include sprinklers, drip or sprinklers according to the

G.-Outdoor lighting: To highlight garden features at night and provide

H.-Gardening tools: tools as shovels, rakes, mowers, pruning shears, garden hoses, among others, for garden maintenance and care.

ACCORDING TO THE LANDSCAPE ORDINANCE THE DESIGN WAS MADE BASED ON THE FOLLOWING:

A minimum of ten percent (10%) of the gross vehicular use area shall be devoted to living landscape which includes grass, ground cover, plants, shrubs and trees. This is to be measured from the edge of the parking and/or driveway paving and sidewalks.

There shall be a minimum of one (1) Large Canopy tree planted for each four hundred (400) square feet or fraction thereof of required interior landscape area. Three (3) Small Ornamental trees, minimum six feet (6') in height and three inches (3") in diameter, may be substituted for one (1) required Large Canopy tree not to exceed twenty-five percent (25%) of the required Large Canopy trees.

Interior areas of parking lots shall contain planting islands located so as to best relieve the expanse of paving. Such islands shall contain at least one (1) Large Canopy tree, and shall be located at the terminus of all parking rows. The remainder of the island space shall be landscaped with shrubs, lawn, and living ground cover not to exceed three feet in height. Any trees located within a planting island may be counted towards the required number of interior trees. The minimum total area of such islands shall be nine feet (9') by eighteen feet (18'), but may design their radii to facilitate traffic maneuverability.

Planting islands shall not be spaced greater than every twelve (12) spaces unless approved on the landscape plan in order to preserve existing trees and natural features or due to unique site features. In all cases, the total area requirements for landscaped islands for the respective parking areas shall be satisfied. Big Boxes may, in lieu of providing a tree every 12 spaces, choose to provide a minimum 10' wide continuous landscape island every 8 single rows of parking, with a Large Canopy tree each 30 linear feet,

subject to review and approval by the Director. This does not waive the requirement for terminus islands and trees on parking rows. In retail developments of 15,000 square feet or more, an Urban Tree shall be placed in a tree grate or tree well each thirty (30) feet on center within a minimum twelve (12) foot wide sidewalk along active storefronts and mixed use building fronts. Trees may be clustered so 13 not to block the main vestibule. Façade trees are not required in areas with an architectural arcade.

A Small Ornamental tree is required along Major Access Lanes each 25 linear feet within a development where reasonable, subject to review and approval by the Director.

An Urban Tree is required along internal pedestrian connections for each 30 linear feet.

All landscaped areas will be protected by a raised six inch (6") concrete curb or wheel stop. Wheel stops are required for all perimeter parking spaces. Pavement will not be placed closer than four feet (4') from the trunk of a tree unless approved by the Director.

The applicant is also encouraged to plant a variety of ornamental trees, shrubs, and flowers in addition to the required plantings. Any permeable surface not occupied by trees, shrubs, planting beds, signs or other permitted fixtures shall be planted with turf or other living ground cover.

Industrial uses shall be exempt from the Interior Landscape requirements, subject to review and approval by the Director.


		\ •			
PLANT SO	CHEDULE		,	-	
SYMBOL	SCIENTIFIC NAME	COMMON NAME	TYPE	HEIGHT	NOTES
	Ulmus crassifolia	Cedar Elm	LARGE CANOPY TREE	3'	NOTE : ALL THE LARGE CANOPY TREES WILL HAVE AT LEAST A 4" GAUGE AT THE TIME OF PLANTING.
	Taxodium distichum	Bald Cypress	LARGE CANOPY TREE	3'	NOTE : ALL THE LARGE CANOPY TREES WILL HAVE AT LEAST A 4" GAUGE AT THE TIME OF PLANTING.
	Myrica cerifera	Wax Myrtle	SMALL ORNAMENTAL TREE	3'	NOTE: ALL THE LARGE CANOPY TREES WILL HAVE AT LEAST A 3" GAUGE AT THE TIME OF PLANTING.
	Acer truncatum	Shantung Maple	URBAN TREE	3'	NOTE: ALL THE LARGE CANOPY TREES WILL HAVE AT LEAST A 4" GAUGE AT THE TIME OF PLANTING.
+	Leucophyllum frutescens	Texas Sage	EVERGREEN SCHRUB	8'	NOTE: ALL THE LARGE CANOPY TREES WILL HAVE AT LEAST 36" WHEN PLANTING.
+	Buxus sempervirens	Boxwood	EVERGREEN SCHRUB	5'	NOTE: ALL THE LARGE CANOPY TREES WILL HAVE AT LEAST 36" WHEN PLANTING.
	Ulmus crassifolia	Cedar elm	LARGE CANOPY TREE	50"	NOTE: ALL THE LARGE CANOPY TREES WILL HAVE AT LEAST A 4" GAUGE AT THE TIME OF PLANTING.
	EXISTING TREE	EXISITING TREE	EXISTING SMALL CANOPY TREE		

The percent of landscape area required is the 10% of gross vehicular use area:

LANDSCAPE PLAN

SCALE: 1"= 20'

GRAPHIC SCALE: 1 INCH = 20 FEET

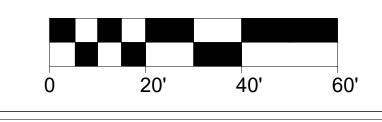


LANDSCAPE PLAN


REVISION:

EXPIRATION DATE:


DRAWN BY F.G.M.

SHEET 03 OF 08

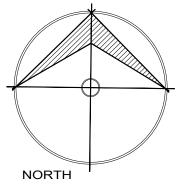

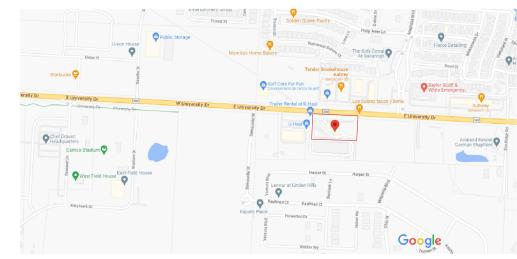


VICINITY MAP FOR REFERENCE ONLY

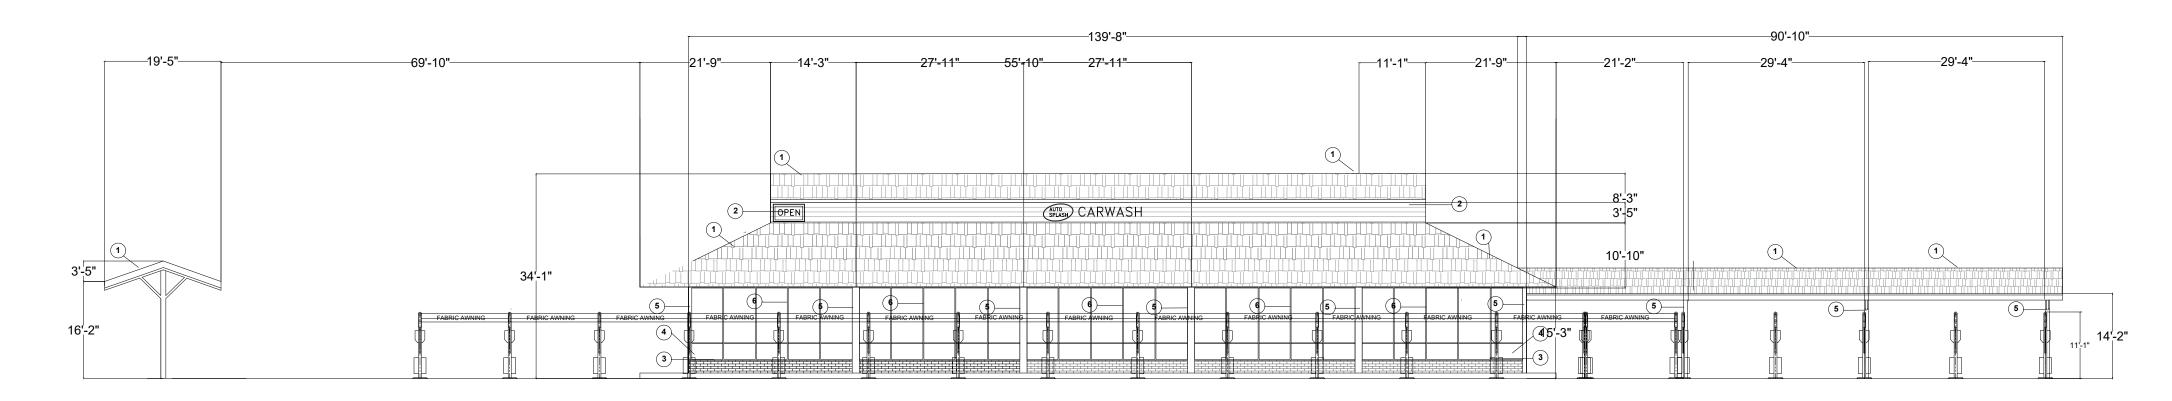

TYPE MARK	MATERIAL	MANUFACTURER	NORTH ELEVATION SQ.FT.	MATERIAL PERCENTAGE
1	10 ft. SM-Rib Galvalume Steel 29-Gauge Roof/Siding Panel in Red	GIBRALTAR	2,622 SQ.FT.	53.30%
2	10 ft. SM-Rib Galvalume Steel 29-Gauge Roof/Siding Panel in Blue	GIBRALTAR	436 SQ.FT.	8.86%
3	Rustic Concrete block Brich color	ROCKWOOD RETAINING WALLS	231.5 SQ.FT.	4.72%
4	Rustic Concrete block chocolate color	ROCKWOOD RETAINING WALLS	44 SQ.FT.	.89%
5	Steel C Channel 8x8 painted yellow	QH STEEL	146.73 SQ.FT.	2.98%
6	Aluminium frame, double glazed with 3mm clear glass/6mm air gap/3mm clear glass	WEBBS GLASS	1,439 SQ.FT.	29.25%
		TOTAL AREA:	4,919.23 SQ.FT.	100%

NORTH ELEVATION (FRONT)

SCALE:1/16"= 1'-0"

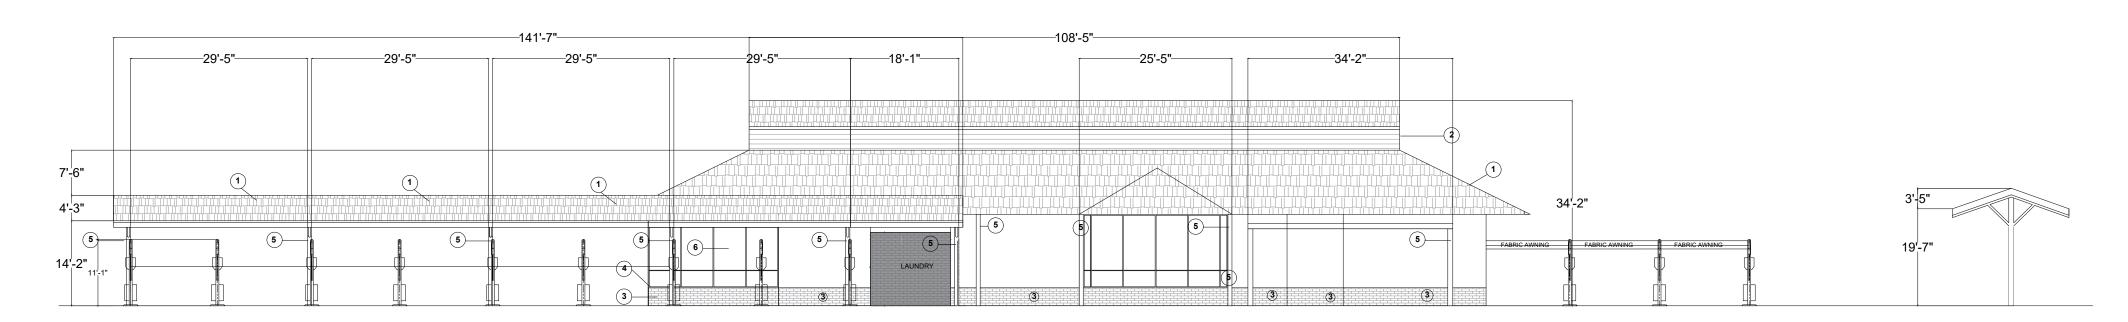

TYPE MARK	MATERIAL	MANUFACTURER	NORTH ELEVATION SQ.FT.	MATERIAL PERCENTAGE
1	10 ft. SM-Rib Galvalume Steel 29-Gauge Roof/Siding Panel in Red	GIBRALTAR	2,990 SQ.FT.	55.84%
2	10 ft. SM-Rib Galvalume Steel 29-Gauge Roof/Siding Panel in Blue	GIBRALTAR	436 SQ.FT.	8.14%
3	Rustic Concrete block Brich color	ROCKWOOD RETAINING WALLS	1,432.63 SQ.FT.	26.76%
4	Rustic Concrete block chocolate color	ROCKWOOD RETAINING WALLS	33.7 SQ.FT.	.63%
5	Steel C Channel 8x8 painted yellow	QH STEEL	109 SQ.FT.	2.04%
6	Aluminium frame, double glazed with 3mm clear glass/6mm air gap/3mm clear glass	WEBBS GLASS	353.2 SQ.FT.	6.5%
		TOTAL AREA:	5,354.53 SQ.FT.	100%

SOUTH ELEVATION

SCALE:1/16"= 1'-0"

<u>ELEVATIONS</u>

SCALE: 1/8"=1'-0"

Notes:

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JOB PROPOSAL: CONCRETE FLATWORK

TITLE SURVEY

1.835 ACRES/79,947 SQ.FT.

JOSE GONZALEZ SURVEY , ABSTRACT NO. 447
26780 US. HIGHWAY 380

TOWN LITTLE ELM, DENTON COUNTY, TEXAS SEPTEMBER 29, 2017

ROYAL SERVICE ADDITION LOT 2 TRACT I AN ADDITION TO THE TOWN OF LITTLE ELM, ACCORDING TO THE MAP OR PLAT THEREOF RECORDED IN CABINET X, PG. 131 OF THE MAP OR/ PLAT RECORDS OF DENTON COUNTY,

- -All mechanical units shall be screened from public view as required by the
- -All signage areas and locations are subject to approval of Development Services
 Director
- -When permitted, exposed utility boxes and conduits shall be painted to match the building
- -Roof access shall be provided internally, unless otherwise permitted by the Chief Building Official

PROJECT:

COMMERCIAL FLATWORK ADDITION

OWNER: JOHN PAPPAS

LOCATION:

26780 US-380 HWY. LITTLE ELM, TEXAS 75068



Gamma Group, Design & Construction LLC
3309 ELM ST. #250, Dallas Texas, 75226
www.gammagroup-usa.com

(469)583-7174,(469)463-276, (214)272-8186

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gamma_fredi@hotmail.com

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NOTE:
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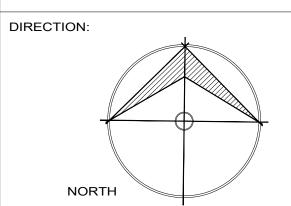
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	SYMBOLOGY
	MATERIALS
SYMBOL	SPECIFICATION
	SIDING PANEL IN RED
2	SIDING PANEL IN BLUE
3	RUSTIC CONCRETE BLOCK BIRCH COLOR
4	RUSTIC CONCRETE BLOCK CHOCOLATE COLOR
5	STEEL
6	GLASS



REVISION:


EXPIRATION DATE:


PLAN:

ELEVATIONS PLAN

DATE: 07/27/2023 DRAWN BY: F.G.M.

SHEET 04 OF 08

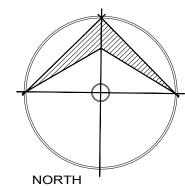

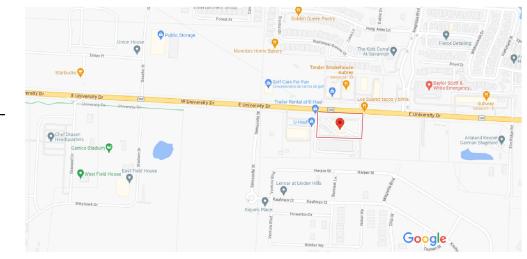


VICINITY MAP FOR REFERENCE ONLY


		33'-9" 29'-10" 	
		8'-3"	
	6'-7"	10'-10"	
LAUNDRY 12'-3"	11"	3 3 3 3 3 3 3	12'-2" FABRIC AWNING 11'-0"

TYPE MARK	MATERIAL	MANUFACTURER	NORTH ELEVATION SQ.FT.	MATERIAL PERCENTAGE
1	10 ft. SM-Rib Galvalume Steel 29-Gauge Roof/Siding Panel in Red	GIBRALTAR	577.6 SQ.FT.	33.21%
2	10 ft. SM-Rib Galvalume Steel 29-Gauge Roof/Siding Panel in Blue	GIBRALTAR	134.2 SQ.FT.	8.2%
3	Rustic Concrete block Brich color	ROCKWOOD RETAINING WALLS	825.1 SQ.FT.	50.4%
4	Rustic Concrete block chocolate color	ROCKWOOD RETAINING WALLS	14.3 SQ.FT.	.87%
5	Steel C Channel 8x8 painted yellow	QH STEEL	46.7 SQ.FT.	2.85%
6	Aluminium frame, double glazed with 3mm clear glass/6mm air gap/3mm clear glass	WEBBS GLASS	73.2 SQ.FT.	4.47%
		TOTAL	1,637.2 SQ.FT.	100%

EAST ELEVATION

SCALE:3/32"= 1'-0"

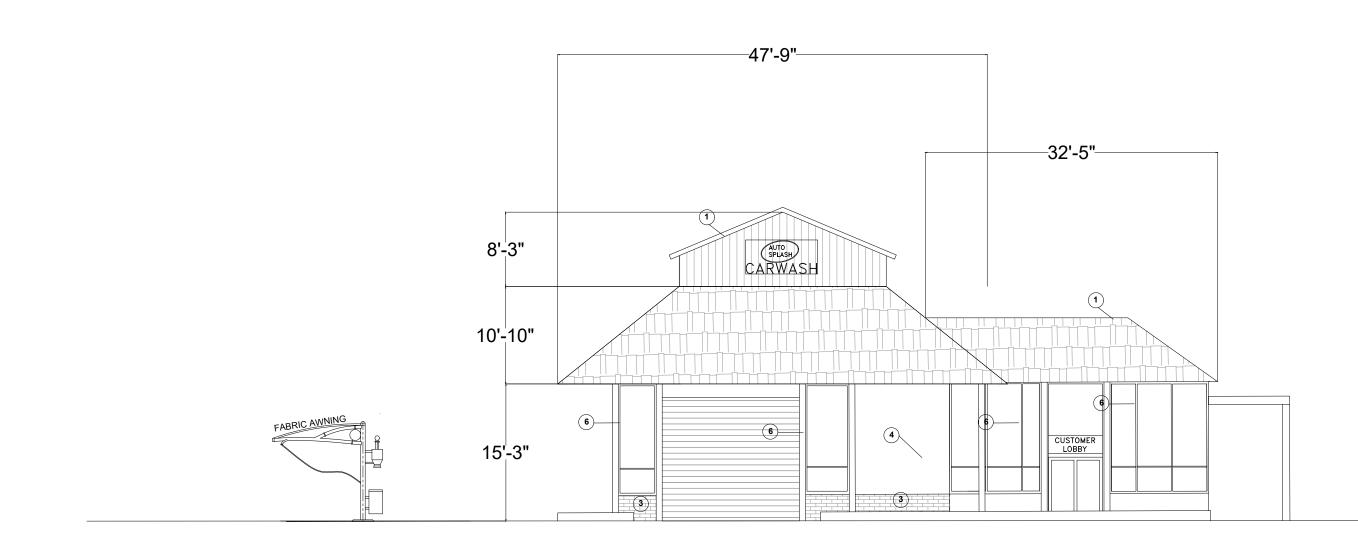

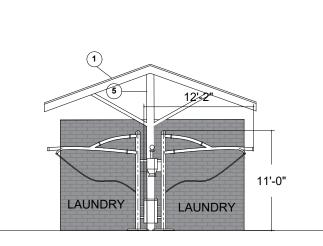

TYPE Mark	MATERIAL	MANUFACTURER	NORTH ELEVATION SQ.FT.	MATERIAL PERCENTAGE
1	10 ft. SM-Rib Galvalume Steel 29-Gauge Roof/Siding Panel in Red	GIBRALTAR	577.6SQ.FT.	17.37%
2	10 ft. SM-Rib Galvalume Steel 29-Gauge Roof/Siding Panel in Blue	GIBRALTAR	134.2 SQ.FT.	4.04%
3	Rustic Concrete block Brich color	ROCKWOOD RETAINING WALLS	455.7 SQ.FT.	13.71%
4	Rustic Concrete block chocolate color	ROCKWOOD RETAINING WALLS	13.4 SQ.FT.	.4%
5	Steel C Channel 8x8 painted yellow	QH STEEL	120.6 SQ.FT.	3.63%
6	Aluminium frame, double glazed with 3mm clear glass/6mm air gap/3mm clear glass	WEBBS GLASS	2,022.9 SQ.FT.	60.85%
		TOTAL	3,324.4 SQ.FT.	100%

WEST ELEVATION

SCALE:3/32"= 1'-0"

ELEVATIONS

SCALE: 1/8"=1'-0"

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PROJECT:

COMMERCIAL FLATWORK ADDITION

OWNER: JOHN PAPPAS

LOCATION:

26780 US-380 HWY. LITTLE ELM, TEXAS 75068



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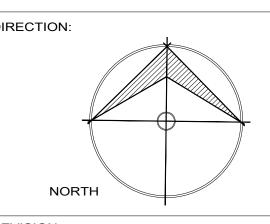
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	5	STEEL
	6	GLASS



REVISION:


EXPIRATION DATE:

PLAN:

ELEVATIONS PLAN

7/27/2023
DRAWN BY:
F.G.M.

SHEET 05 OF 08

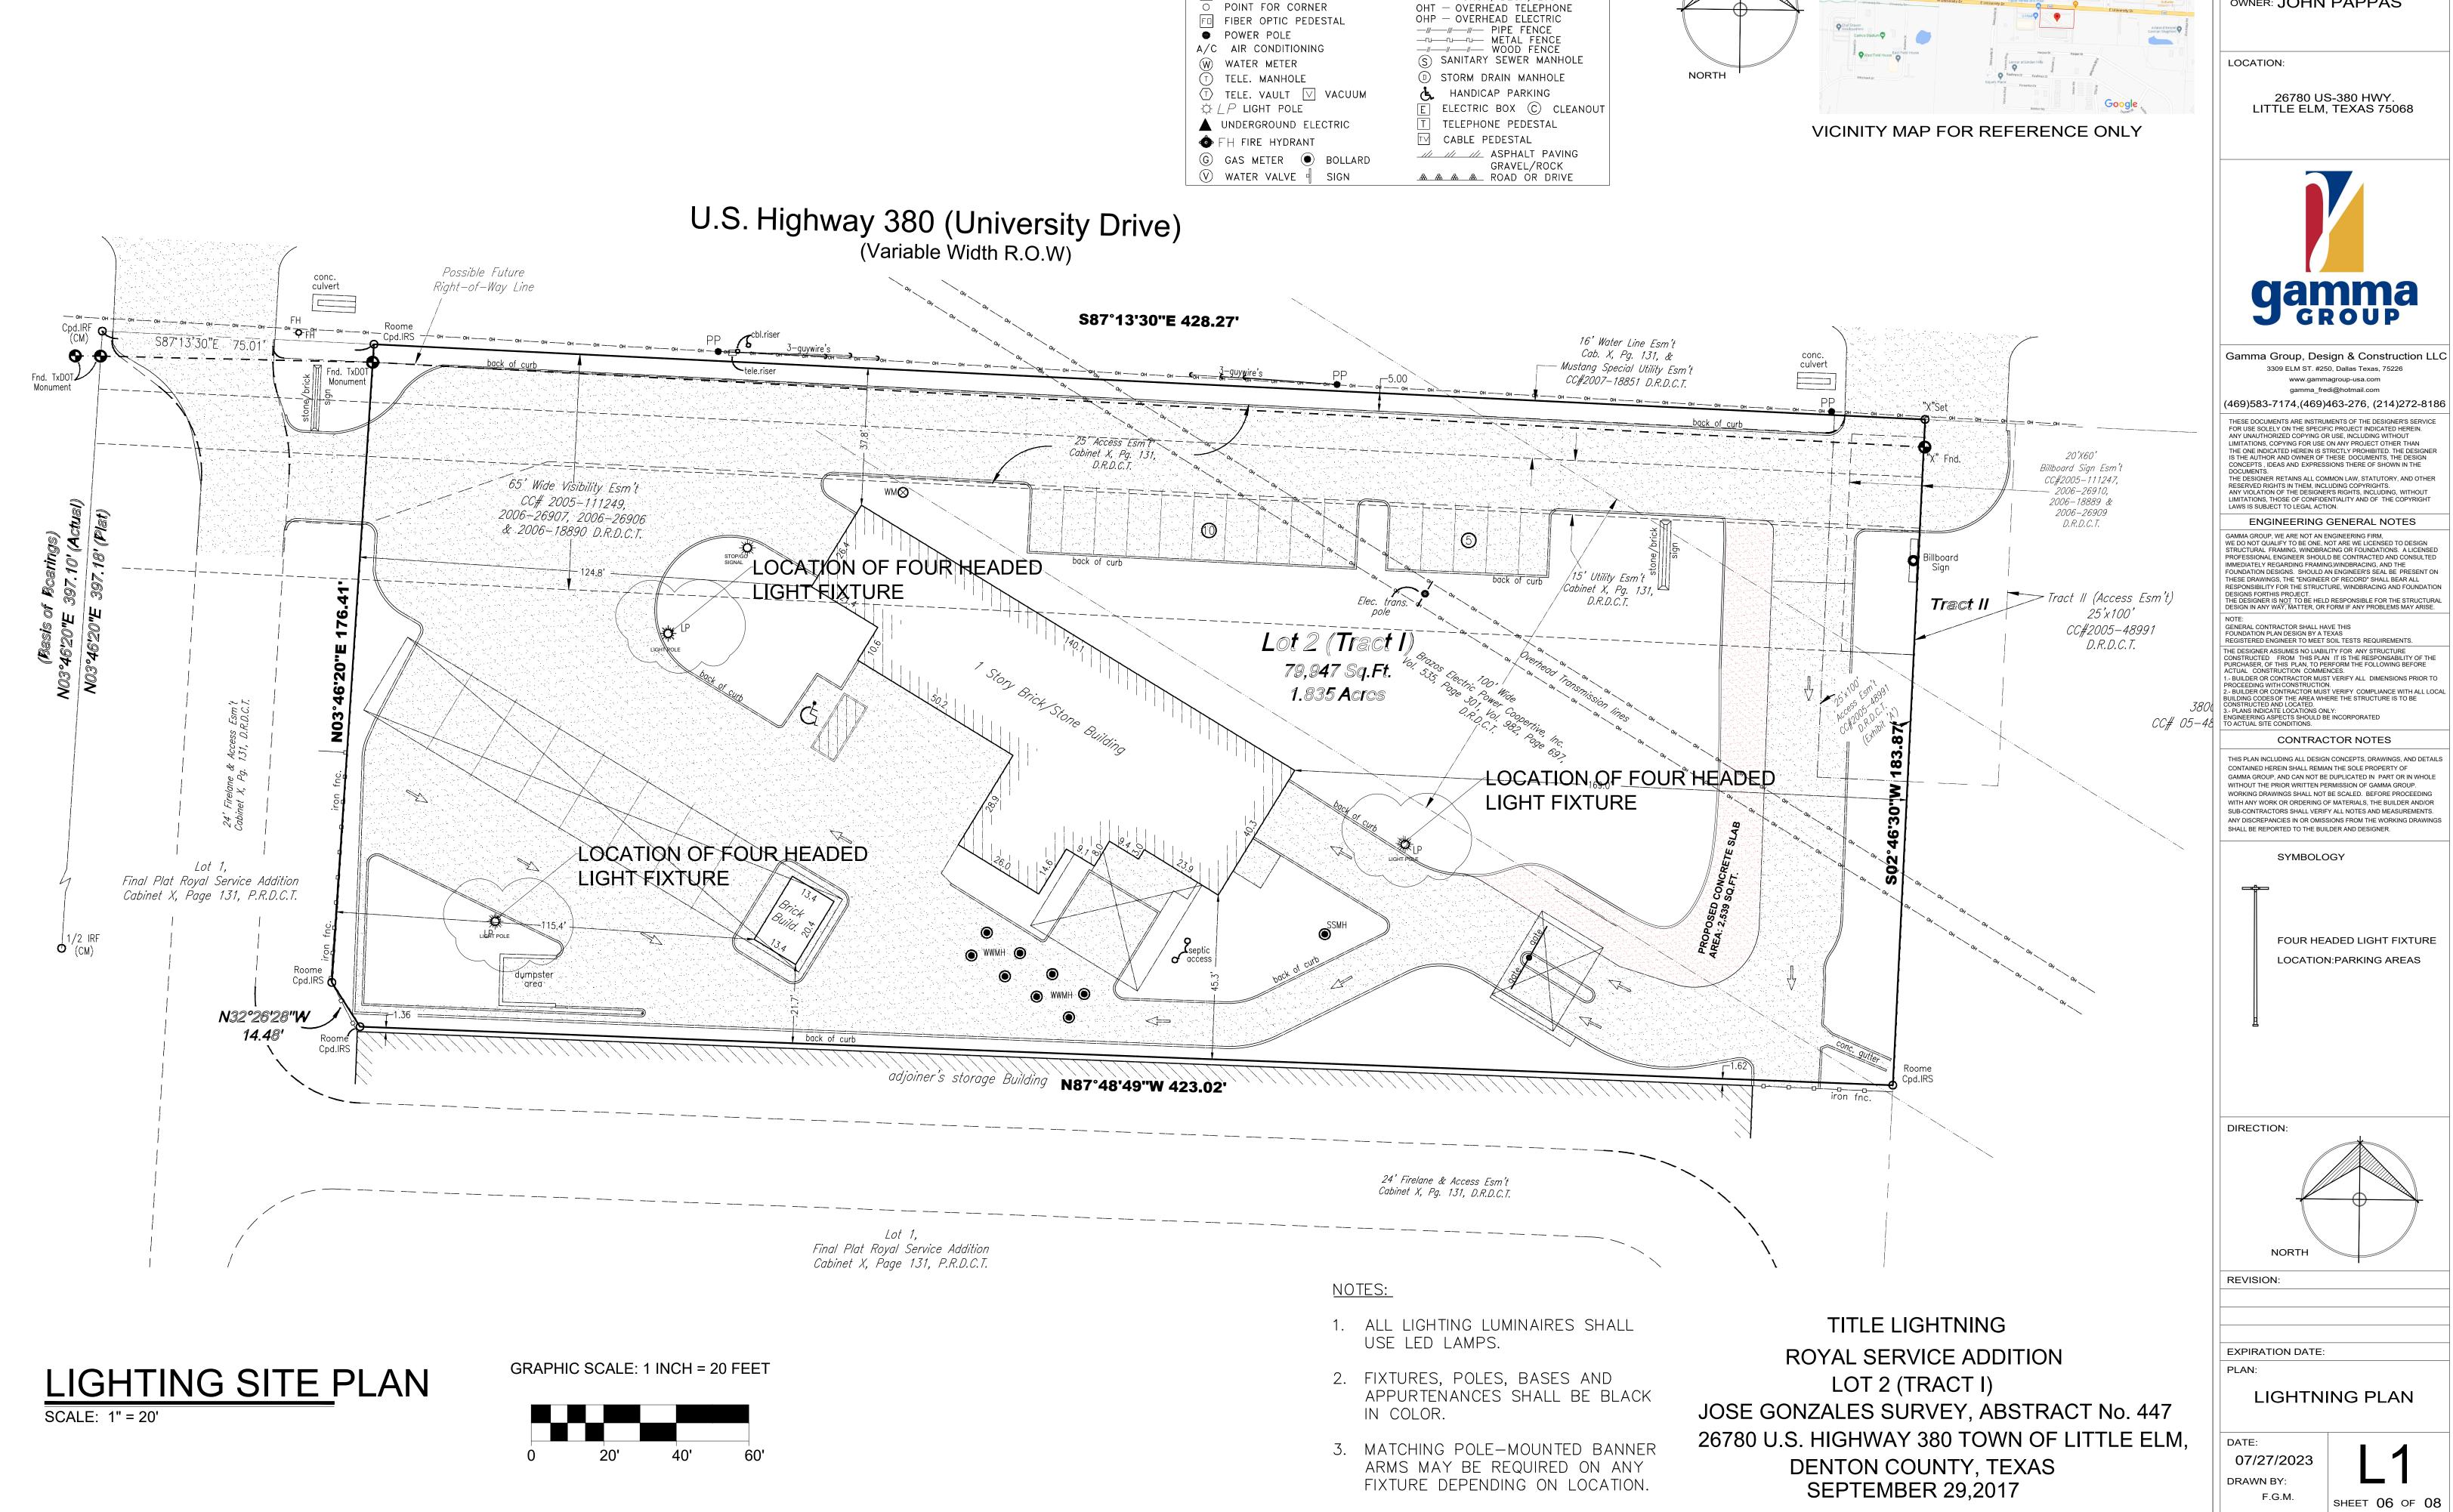

LEGEND

CONCRETE WOOD

COVERED CARPORT,

PORCH, DECK, ETC

CM CONTROLLING MONUMENT

X" FOUND IN CONCRETE

PROJECT:

COMMERCIAL FLATWORK ADDITION

OWNER: JOHN PAPPAS

26780 US-380 HWY. LITTLE ELM, TEXAS 75068



Gamma Group, Design & Construction LLC 3309 ELM ST. #250, Dallas Texas, 75226

www.gammagroup-usa.com gamma_fredi@hotmail.com

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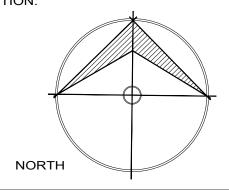
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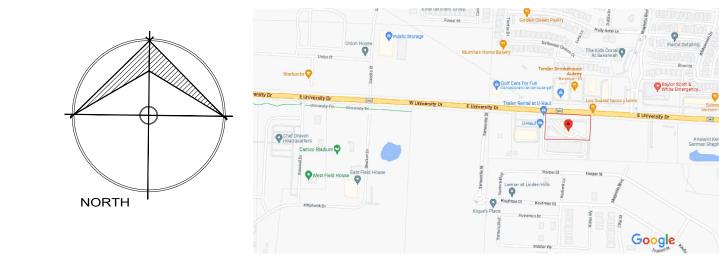
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FOUR HEADED LIGHT FIXTURE LOCATION:PARKING AREAS



SHEET 06 OF 08



VICINITY MAP FOR REFERENCE ONLY

PROJECT:

COMMERCIAL FLATWORK ADDITION

JOHN PAPPAS

LOCATION:

26780 US-380 HWY. LITTLE ELM, TEXAS 75068



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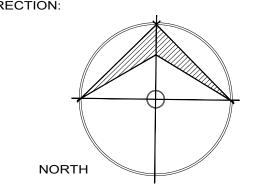
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FOUR HEADED LIGHT FIXTURE LOCATION:PARKING AREAS




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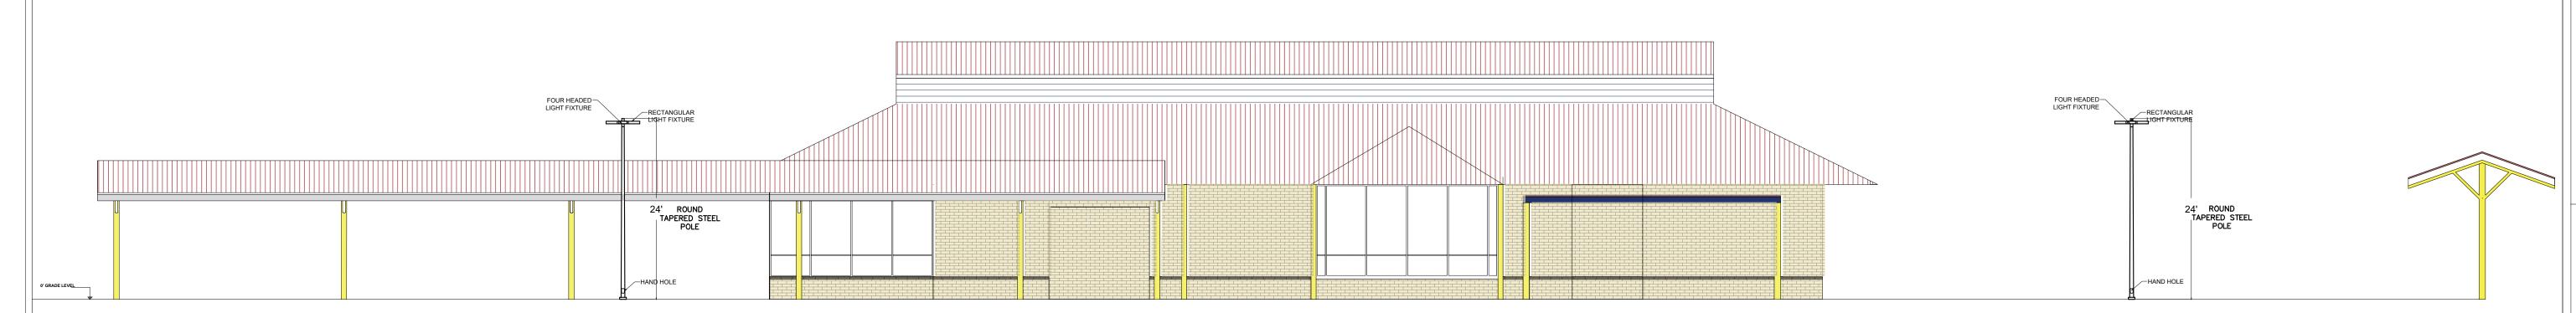
EXPIRATION DATE:

LIGHTNING PLAN

07/27/2023 DRAWN BY: F.G.M.

SHEET 07 OF 08



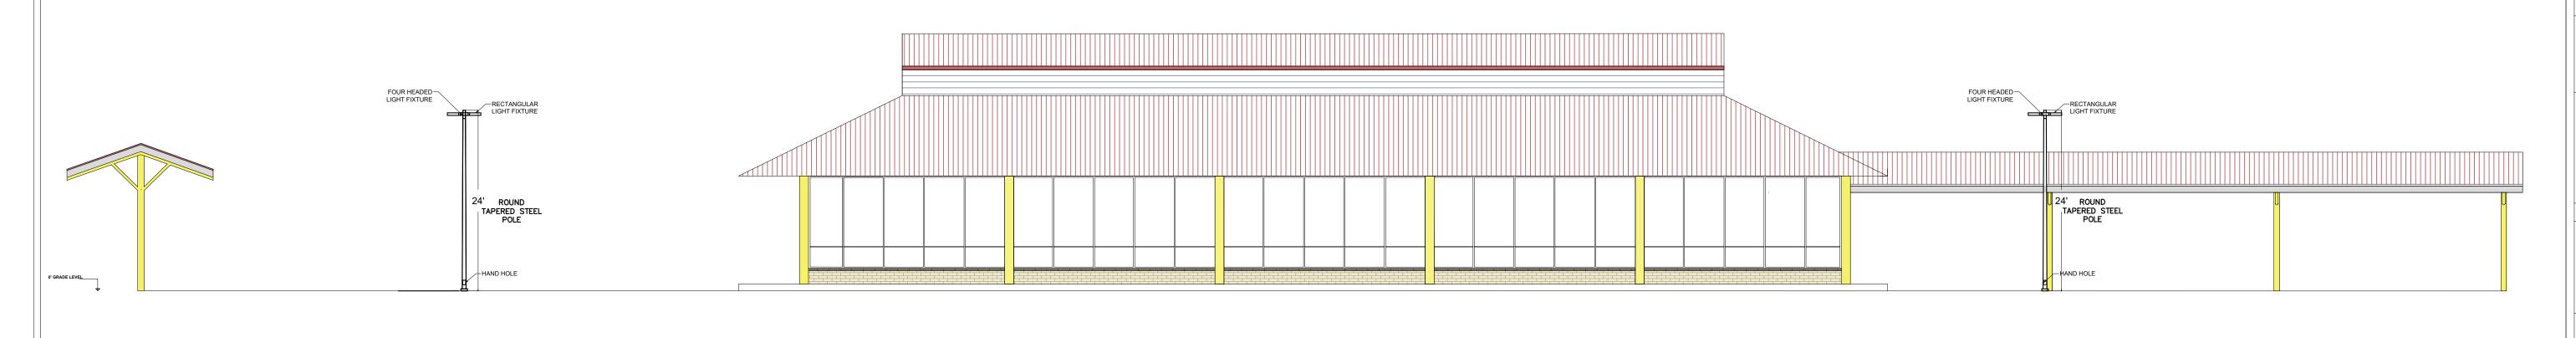

LIGHTNING PLAN

SCALE: 3/32"=1'-0"

ALL LIGHTING LUMINAIRES SHALL USE LED LAMPS.


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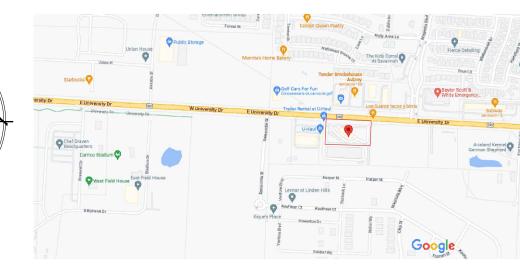
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3. MATCHING POLE-MOUNTED BANNER ARMS MAY BE REQUIRED ON ANY FIXTURE DEPENDING ON LOCATION.


ROYAL SERVICE ADDITION LOT 2 (TRACT I) JOSE GONZALES SURVEY, ABSTRACT No. 447 26780 U.S. HIGHWAY 380 TOWN OF LITTLE ELM, DENTON COUNTY, TEXAS SEPTEMBER 29,2017


TITLE LIGHTNING



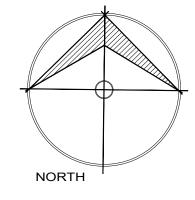

VICINITY MAP FOR REFERENCE ONLY

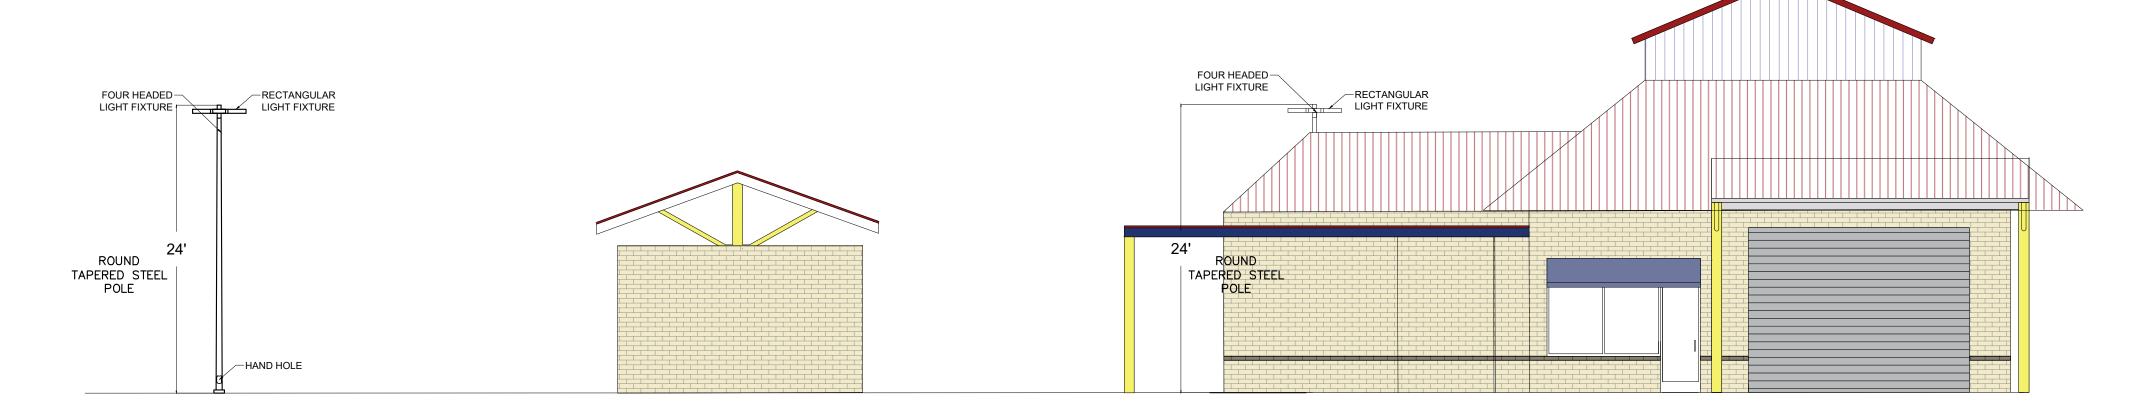

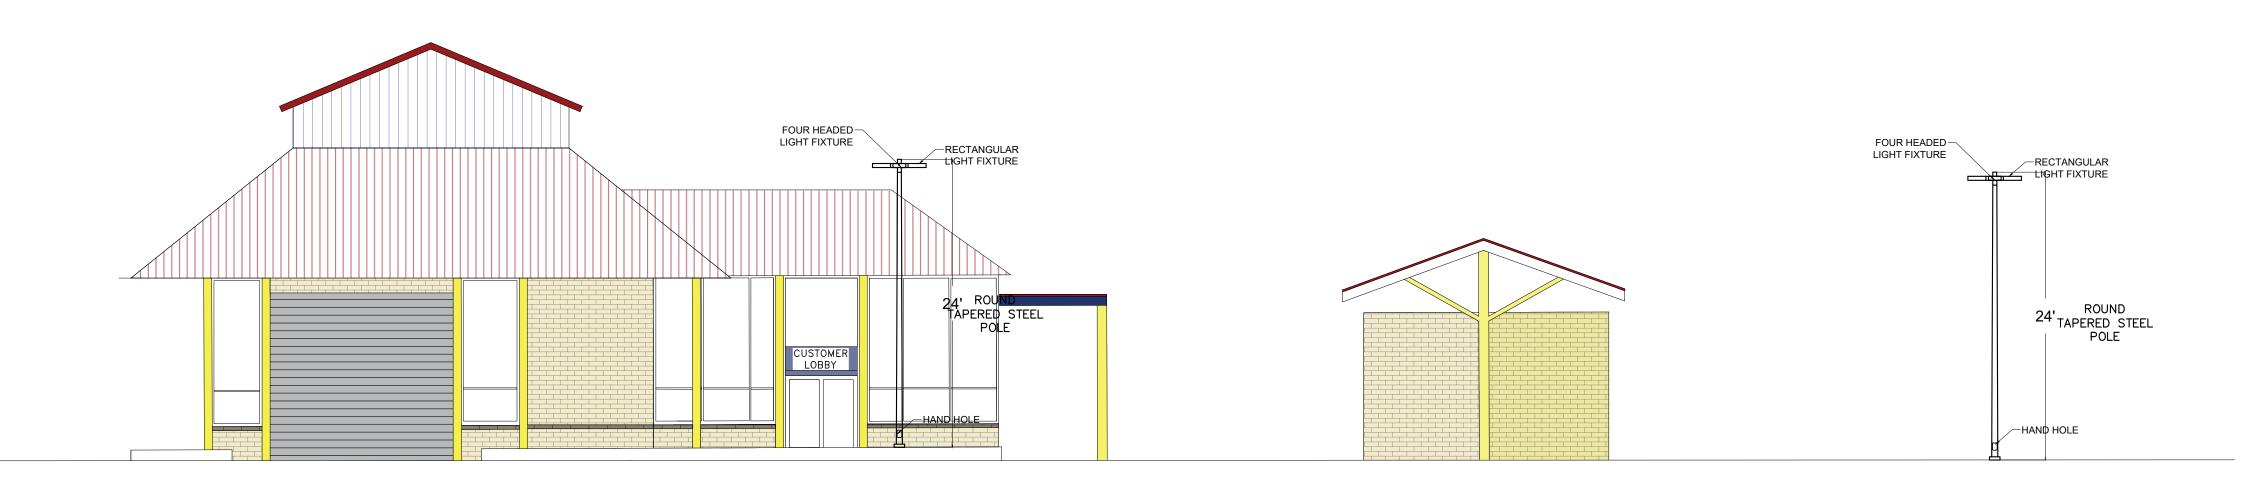

<u>LIGHTNING PLAN</u>

SCALE: 1/8"=1'-0"

NOTES:

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TITLE LIGHTNING ROYAL SERVICE ADDITION LOT 2 (TRACT I) JOSE GONZALES SURVEY, ABSTRACT No. 447 26780 U.S. HIGHWAY 380 TOWN OF LITTLE ELM, DENTON COUNTY, TEXAS

SEPTEMBER 29,2017

PROJECT:

COMMERCIAL FLATWORK ADDITION

OWNER: JOHN PAPPAS

LOCATION:

26780 US-380 HWY. LITTLE ELM, TEXAS 75068



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REGISTERED ENGINEER TO MEET SOIL TESTS REQUIREMENTS.

THE DESIGNER ASSUMES NO LIABILITY FOR ANY STRUCTURE
CONSTRUCTED FROM THIS PLAN IT IS THE RESPONSABILITY OF THE
PURCHASER, OF THIS PLAN, TO PERFORM THE FOLLOWING BEFORE
ACTUAL CONSTRUCTION COMMENCES.


1. BUILDER OR CONTRACTOR MUST VERIFY ALL DIMENSIONS PRIOR TO
PROCEEDING WITH CONSTRUCTION.


2. BUILDER OR CONTRACTOR MUST VERIFY COMPLIANCE WITH ALL LOCAL
BUILDING CODES OF THE AREA WHERE THE STRUCTURE IS TO BE
CONSTRUCTED AND LOCATED.

3. PLANS INDICATE LOCATIONS ONLY:
ENGINEERING ASPECTS SHOULD BE INCORPORATED
TO ACTUAL SITE CONDITIONS.

CONTRACTOR NOTES

THIS PLAN INCLUDING ALL DESIGN CONCEPTS, DRAWINGS, AND DETAILS CONTAINED HEREIN SHALL REMIAN THE SOLE PROPERTY OF GAMMA GROUP, AND CAN NOT BE DUPLICATED IN PART OR IN WHOLE WITHOUT THE PRIOR WRITTEN PERMISSION OF GAMMA GROUP. WORKING DRAWINGS SHALL NOT BE SCALED. BEFORE PROCEEDING WITH ANY WORK OR ORDERING OF MATERIALS, THE BUILDER AND/OR SUB-CONTRACTORS SHALL VERIFY ALL NOTES AND MEASUREMENTS. ANY DISCREPANCIES IN OR OMISSIONS FROM THE WORKING DRAWINGS

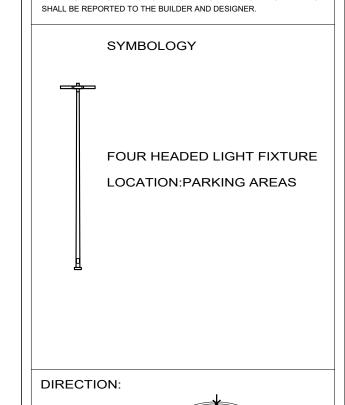

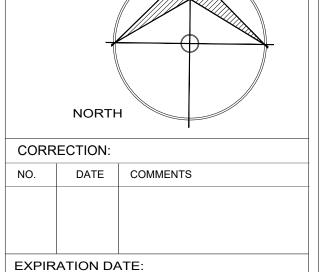

_AN:

LIGHTNING PLAN

DATE:
07/27/2023
DRAWN BY:
F.G.M.

SHEET 08 OF 08



Washguys Car Wash

26780 US-380 Little Elm, TX 76227

Cameron Ray Washguys Car Wash 26780 US-380 Little Elm, TX 76227 2-20-24

City of Little Elm Development Committee 100 W. Eldorado Parkway Little Elm, TX 75068

Dear City of Little Elm Development Committee,

Subject: Proposal for Vacuum Canopy Post Coverings at Washguys Car Wash, Little Elm

I hope this letter finds you well. On behalf of Washguys Car Wash I am writing to outline and seek approval for any of the various vacuum post covering options that we are proposing for the addition of vacuum canopies on the northside of our property. Our goal is to enhance the aesthetic appeal and functionality of our facility while ensuring that the new additions harmonize with the existing structures and the surrounding environment.

We have evaluated several materials and designs for the vacuum post coverings, and we are presenting the following options for your consideration:

Traditional Brick Coverings: This option involves using bricks that are identical or very similar to those used in the current structure of our building. The traditional brick covering aims to ensure a seamless integration with the existing architecture, maintaining the established aesthetic and structural integrity.

Painted Traditional Brick: As an alternative to the natural brick look, we are considering painting the traditional brick coverings to match the exact color scheme of the existing building. This option allows for a uniform appearance across the property while still offering the durability and appeal of brick.

Variety of Stone Options: Recognizing the unique character and diversity of Little Elm, we are also proposing a range of stone coverings. These include but are not limited to limestone, sandstone, and slate. Each stone type has been selected for its durability, aesthetic appeal, and compatibility with the local environment. We believe that offering a variety of stone options allows for customization that can enhance the visual appeal of the area while respecting the natural beauty of Little Elm.

Our team has carefully considered the impact of these additions on the local community, environment, and the overall aesthetic of the area. We are committed to using high-quality materials that are environmentally friendly and sustainable. Moreover, we have ensured that all proposed options comply with the local zoning laws, building codes, and architectural guidelines.

Enclosed with this letter, you will find detailed images for each proposed covering option. We are eager to work closely with the City of Little Elm Development Committee to review these proposals and make any necessary adjustments to meet the city's standards and expectations.


We request the committee's feedback and approval to proceed with our planned enhancements. We believe that these upgrades will not only benefit Washguys Car Wash but also contribute positively to the visual and functional landscape of Little Elm.

Thank you for considering our proposal. We look forward to your guidance and approval to move forward with this project. Please do not hesitate to contact me directly at 972-214-8139 or Cameron@Washguys.net for further discussion or clarification on any of the proposed options.


Warmest regards,

Cameron Ray Washguys Car Wash 972-214-8139



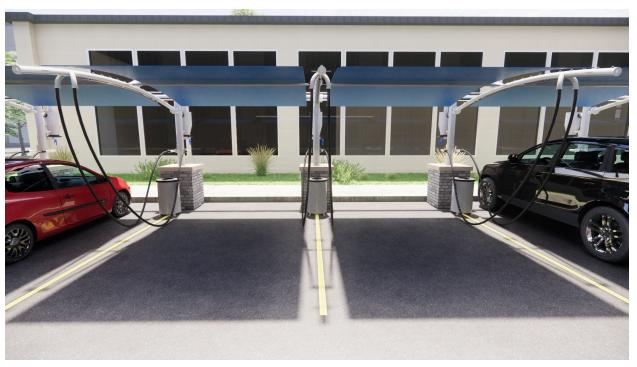



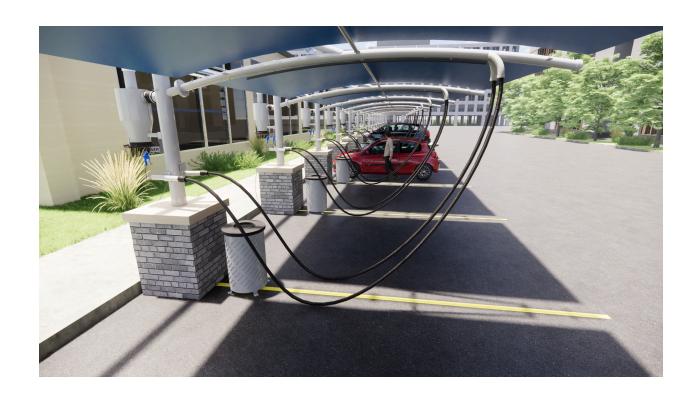









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GENERAL NOTES

Preliminary Drawings:

Preliminary drawings may be provided with a quote to indicate the location of vacuum equipment, piping, and hoses. Drawings may be used in direct coordination with Architects and Engineers' plans for city/AHJ/client approval. Accurate and complete site plans must be provided to ensure the quality of your vacuum area to coordinate issues such as vacuum parking space width/angle, traffic flow, and hose reach.

Drawings are preliminary until the final system order is signed by the client.

Changes made to a vacuum system without Vacutech's consultation voids all Vacutech responsibility as well as the system warranty.

INSTALLATION NOTES

Installation By Others:

Installation drawings are provided with each project. Most projects require 2 or more installers and a forklift. Buried pipe, footings and concrete equipment pad(s) should be completed before installing Vacutech systems. J-bolt template kits for footings for vacuum arches and stanchions are available for purchase from Vacutech. Refer to drawings for footing requirements. Changes to vacuum piping, vacuum equipment location, and vacuum equipment enclosure will effect the performance of your system. Changes made to a vacuum system without Vacutech's consultation voids all Vacutech responsibility and the system warranty.

Vacutech System Install:

Vacutech offers installation as an option when bidding a project

Please note that the scope of Vacutech's installation only includes work above ground. Vacutech will install vacuum arches/stanchions to concrete footings, install vacuum piping and set vacuum equipment in place.

Vacutech does not dig trenches, auger footings, dig/backfill/bury pipe or conduit, or provide any work below grade.

Vacutech does not pour footings, install J-bolts, install concrete trenches with covers, pour concrete pads, or do concrete work of any kind. Vacutech does not do core drilling through building walls.

Vacutech does not wire lights, turbines, disconnects, VFDs , starters or any other electrical component. Vacutech does not pull wire through conduits. These items must be done by a Licensed Electrician.

WARRANTY NOTES

CHANGES MADE TO VACUUM SYSTEM WITHOUT VACUTECH CONSULTATION VOIDS ALL VACUTECH RESPONSIBILITY AND SYSTEM WARRANTY

Equipment warranty information: (if applicable)

When vacuum equipment is installed in an enclosure with 4 walls and a roof it must be ventilated. Enclosure door must be louvered and an exhaust fan with thermostat set at 85°f must be installed to turn over air every 15 min. Vacuum turbine must be exhausted outside with metallic pipe no smaller than 6" with exhaust pipe opening protected from elements. Equipment pad must be flat and level.

<u>Variable frequency drive (VFD) warranty information:</u> (if applicable)

VFDs must be wired from main distribution panel in separate conduit (sized per code; based on turbine H.P. and voltage) to each VFD and from each VFD to turbine motor.

A separate conduit, sized per code, must also be installed from VFD to vacuum pressure transducer installed on filter separator. If two (2) or more VFD's are installed in one (1) enclosure, a separate conduit must be installed for each VFD. Install separate conduit from enclosure to each turbine motor, and each filter separator if there is more than one (1).

1350 HI-TECH DRIVE

SHERIDAN, WY 82801 PHONE: (307) 675-1982 EMAIL: vacinfo@ncswash.com

WEB: www.vacutechllc.com

PIPE NOTES

Piping systems above ground

Piping system shall be schedule 40 (or sch 80) solid core PVC or ABS plastic pipe, with plastic D.W.V. (drain, waste and vent) fittings. Zinc, aluminum, or galvanized tubing, with directional flow zinc fittings of no less than 16 gauge, designed specifically for central vacuum systems are also acceptable.

Buried piping systems cast iron no-hub

In-ground piping systems that are subject to ground freeze/thaw conditions or excessive movement shall be cast iron with no-hub fittings and no-hub couplings (w/ stainless steel band).

Buried piping systems PVC sch 40 (or sch 80)

In-ground piping systems using PVC pipe shall be sch 40 (or sch 80) solid core, with PVC D.W.V.(drain, waste, and vent) fittings. Plastic pipe installed in-ground have a potential of possible cracking and wear. All plastic pipe systems in-ground must be below freeze line.

vstem notes:

All interior surfaces shall be free of burrs and obstructions for a non-restrictive air flow.ABS and PVC piping shall be cut straight and removed of burrs. Piping shall be attached together using a primer, and a cement (clear PVC cement for PVC/ black abs cement for a 100% tight seal

Overhead piping systems shall be supported by means of approved pipe hangers, and shall be installed at a maximum of six feet O.C. when using abs or PVC pipe and ten feet when using zinc or aluminum tubing. All fittings supporting vacuum drop/hose assemblies shall be supported with within one foot on each side of fitting connection.

Piping systems shall be tested to hold 10 psi for a minimum of 24 hours.

When vacuum system is installed in potentially explosive environment, the following may be required as a minimum: Explosion proof motor Class I - Group D & Class II - Group E, F & G. Aluminum piping with zinc fittings. Primary and filtered separators and hose assemblies require special grounding. Verify all conditions.

PVC and ABS plastic pipe are not U.V. rated and will discolor and soften/cause bowing when exposed to direct sunlight. It is recommended that all exposed plastic pipe and fittings be primed and painted to help prevent this. It is recommended to use zinc, or aluminum tubing and zinc fittings be used when exposed to sun.

Plastic pipe exposed to elements:

PVC pipe will become brittle at 40° f and can crack/split when moving debris collides with it, it is recommended to use cast iron, zinc, or aluminum tubing for colder conditions.

ADDITIONAL NOTES

VFD System

Instructions for wiring VFD to Turbine and Filter Separator are available for your electrician After wiring is complete, call our customer service to complete programming.

Arch Systems: How Awnings are ordered (Cooloroo/Weblon)

Step 1: Arches are to be completely installed on site.

Step 2: After installation, Vacutech will send an awning measurement form to be filled out with instructions on how and where to measure. The awning form must be filled out entirely, signed, dated, and faxed or emailed to Vacutech for production.

Step 3: Awnings are shipped to site w/ instructions.


Maintenance:

System longevity under continuous operation is extended by regular maintenance. Issues commonly result from failure to remove obstructions in the piping system, replace damaged or worn parts, or not regularly changing filter bags. Refer to Vacutech maintenance instructions

Assign a person to central vacuum maintenance:

To ensure continued trouble free central vacuum system operation and to avoid downtime during periods of heavy use, assign an employee to follow a strict maintenance schedule.

Refer to Vacutech recommended maintenance schedule.

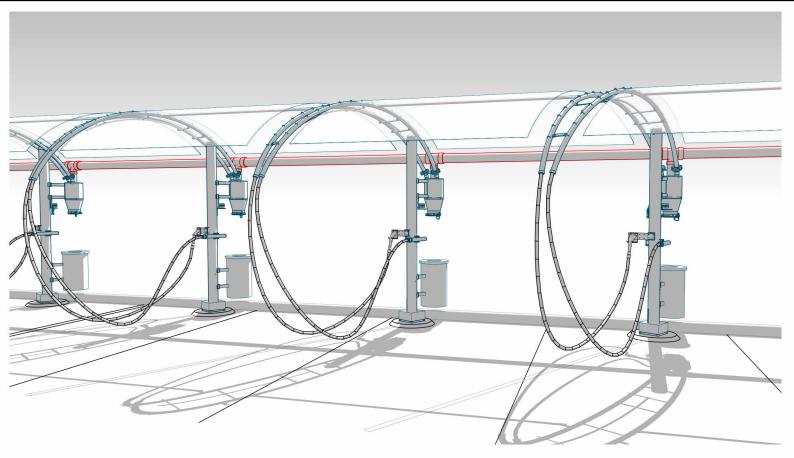



Elevation: 545' ASL

SHEET INDEX				
NO.	NAME	REV.		
V001	COVER SHEET			
V101	OVERALL SITE PLAN			
V111	VACUUM SITE PLAN - A			
V112	VACUUM SITE PLAN - B			
V121	VAC. SITE ISOMETRIC - A			
V122	VAC. SITE ISOMETRIC - B			

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VACUTECH WASH GUYS 13

26780 US HIGHWAY 380 LITTLE ELM, TEXAS 76227

#	Revision	Ву	Chk	Date
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COVER SI	HEET	
Project Number	111934	
Date	4/18/22	V001
Drawn By	ML	VUUI
Checked By	TD	

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CONSTRUCTION NOTES

GENERAL NOTES:


- ALL DIMENSIONS TO BE FIELD VERIFIED BY OWNER
- IF VACUUM EQUIPMENT IS ENCLOSED WITH ROOF/CEILING, REFER TO VENTILATION REQUIREMENTS UNDER EQUIPMENT WARRANTY INFORMATION
- PIER DESIGN AND REINFORCEMENT FOR CONCEPTUAL USE ONLY. CONSULT STRUCTURAL ENGINEER IN YOUR AREA FOR SPECIFIC DESIGN CRITERIA.
- COMPLY WITH ALL STATE/ COUNTY BUILDING CODES IN YOUR AREA

EQUIPMENT & MATERIAL

- RUN COMPRESSED AIR TO AIR COMPRESSOR LOCATION (BY OTHERS)
- WALL PENETRATION: CORE DRILLING MAY BE REQUIRED FIELD VERIFY HEIGHT
- 14'Lx5'Wx4"H MINIMUM FLAT AND LEVEL CONCRETE FLOOR SPACE REQUIRED FOR VACUUM EQUIPMENT **VERIFY SEPARATOR WILL FIT THROUGH DOOR (60" CLEAR OPENING WIDTH RECOMMENDED) - BOTH AREAS**

VACUUM & PLUMBING:

- SUPPORT SCHEDULE 40 PVC OVERHEAD DRY/WET VACUUM PIPE EVERY 6' MAXIMUM; USE UNISTRUT & CLAMP OR OTHER SUPPORT (PROVIDED BY OTHERS)
- ALL FITTINGS TO BE 'DWV'

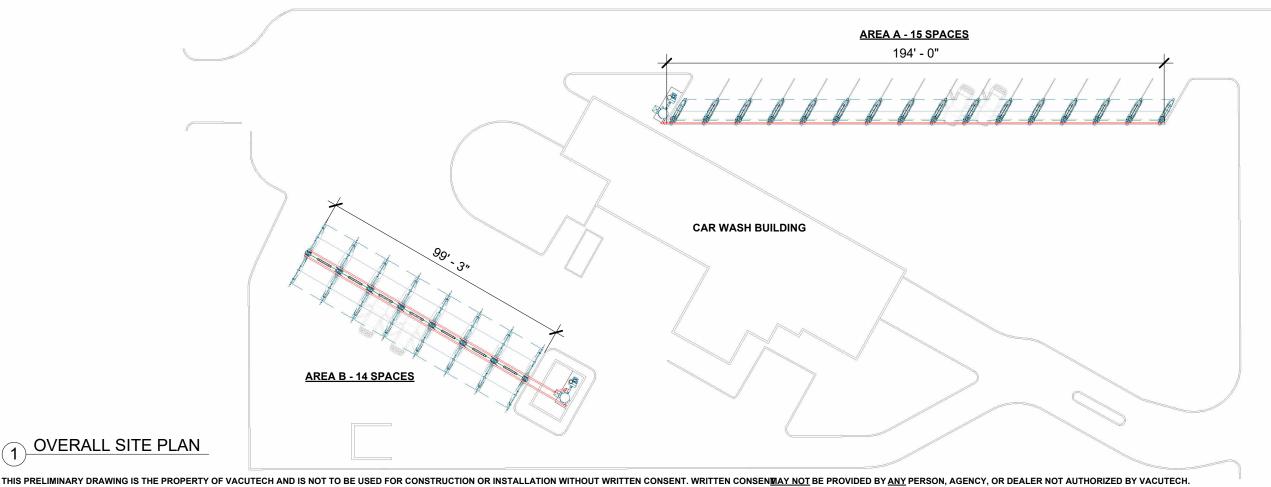



1350 HI-TECH DRIVE

SHERIDAN, WY 82801

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WASH GUYS 13

26780 US HIGHWAY 380 LITTLE ELM, TEXAS 76227

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OVERALL S	SITE PLAN
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Project Number	111934
Date	4/18/22
Drawn By	ML
Checked By	TD

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VACUUM AREA A

QTY ITEM

<u>QTY</u> <u>ITEM</u>

VACUUM EQUIPMENT A


- 60HP T5 DIRECT DRIVE TURBINE
- 8" T5 OUTDOOR EXHAUST SILENCER
- 45x96 FILTER SEPARATOR **CLAW VACUUM TOOL & HOLDER** CREVICE VACUUM TOOL & HOLDER
- **CLAW TOOL EXTENSION BRACKET** 1-1/2"x15' VACUUM HOSE
- AIR NOZZLE & HOSE
- 16 AIR TOOL HANGER
- 30 GALLON WASTE RECEPTACLE

SINGLE USER UMBRELLA ARCH

DUAL USER UMBRELLA ARCH

- 6' LED LIGHT
- 9' 16'-6" ADJUSTABLE CROSSBAR
- FABRIC AWNING

	SITE PLAN - AREA A
ITEM	DESCRIPTION
1	SINGLE USER UMBRELLA ARCH AT ENDS OF VACUUM SPACES
2	DUAL USER UMBRELLA ARCH BETWEEN VACUUM SPACES
3	6" OVERHEAD ALUMINUM VACUUM TUBE BETWEEN ARCHES
4	BURIED COMPRESSED AIR LINE (BY OTHERS)
5	FABRIC AWNING
6	9' - 16'-6" ADJUSTABLE CROSSBAR
7	15' HOSE REACH
	1 2 3 4 5

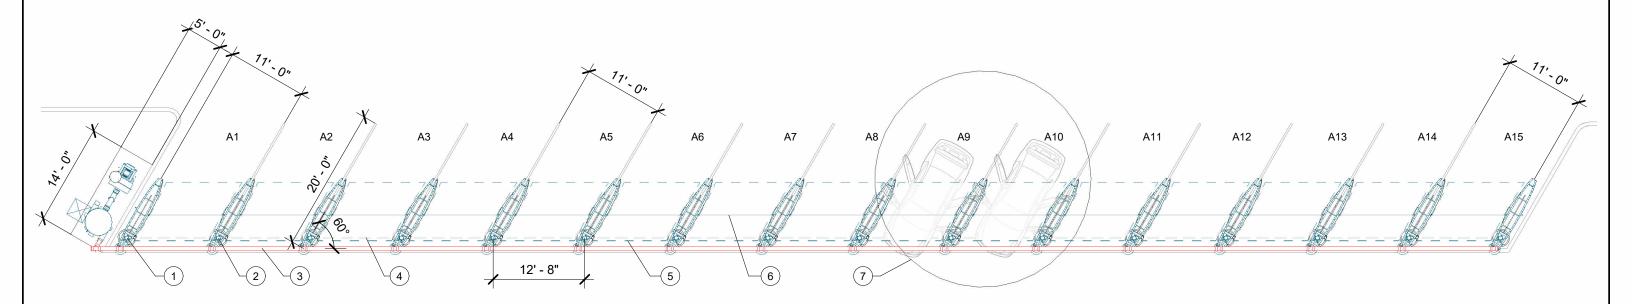

SITE PLAN - AREA A

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1350 HI-TECH DRIVE SHERIDAN, WY 82801 PHONE: (307) 675-1982 EMAIL: vacinfo@ncswash.com WEB: www.vacutechllc.com

VACUTECH WASH GUYS 13

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#	Revision	Ву	Chk	Date

VACUUM	SITE	PLAN -	Α

Project Number	111934
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VACUUM AREA B

QTY ITEM


- SINGLE USER FULL PALM ARCH
- DUAL USER FULL PALM ARCH
- CLAW VACUUM TOOL & HOLDER
- CREVICE VACUUM TOOL & HOLDER
- FULL PALM CREVICE BRACKET SINGLE
- FULL PALM U BRACKET
- 14 L-EXTENSION BRACKET
- 1-1/2"x15' VACUUM HOSE
- 16 AIR NOZZLE & HOSE
- 16 AIR TOOL HANGER
- 16 30 GALLON WASTE RECEPTACLE
- 16 8' LED LIGHT
- 14 9' - 16'-6" ADJUSTABLE CROSSBAR
- FABRIC AWNING

VACUUM EQUIPMENT B

QTY ITEM

- 60HP T5 DIRECT DRIVE TURBINE
- 8" T5 INDOOR EXHAUST SILENCER
- 45x96 FILTER SEPARATOR

ITEM DESCRIPTION
1 SINGLE USER FULL PALM ARCH AT ENDS OF VACUUM SPACES
2 6" OVERHEAD ALUMINUM VACUUM TUBE BETWEEN ARCHES
3 DUAL USER FULL PALM ARCH BETWEEN VACUUM SPACES
4 15' HOSE REACH
5 FABRIC AWNING
6 9' - 16'-6" ADJUSTABLE CROSSBAR
7 BURIED COMPRESSED AIR LINE (BY OTHERS)

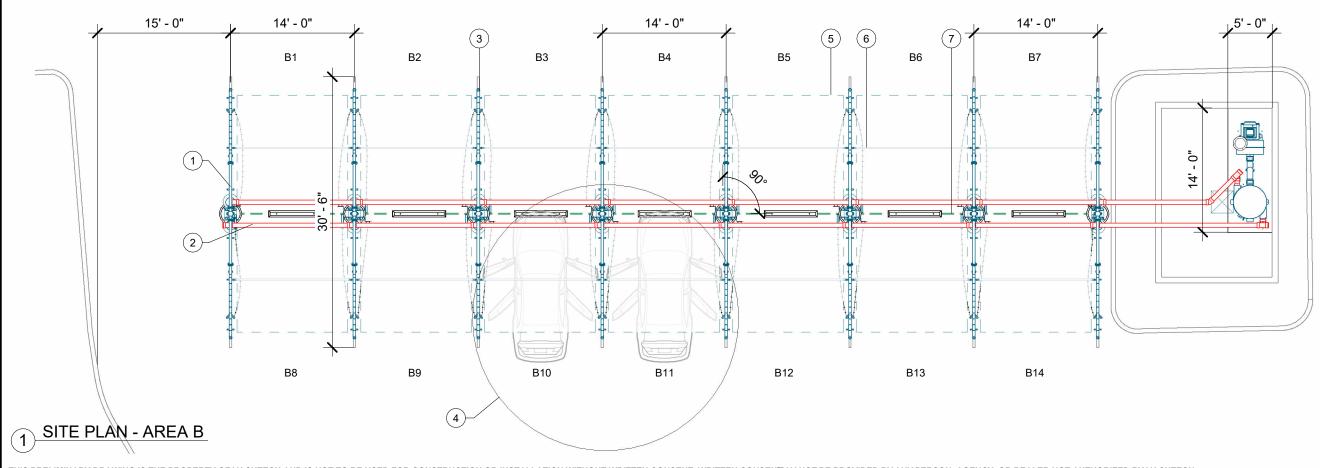



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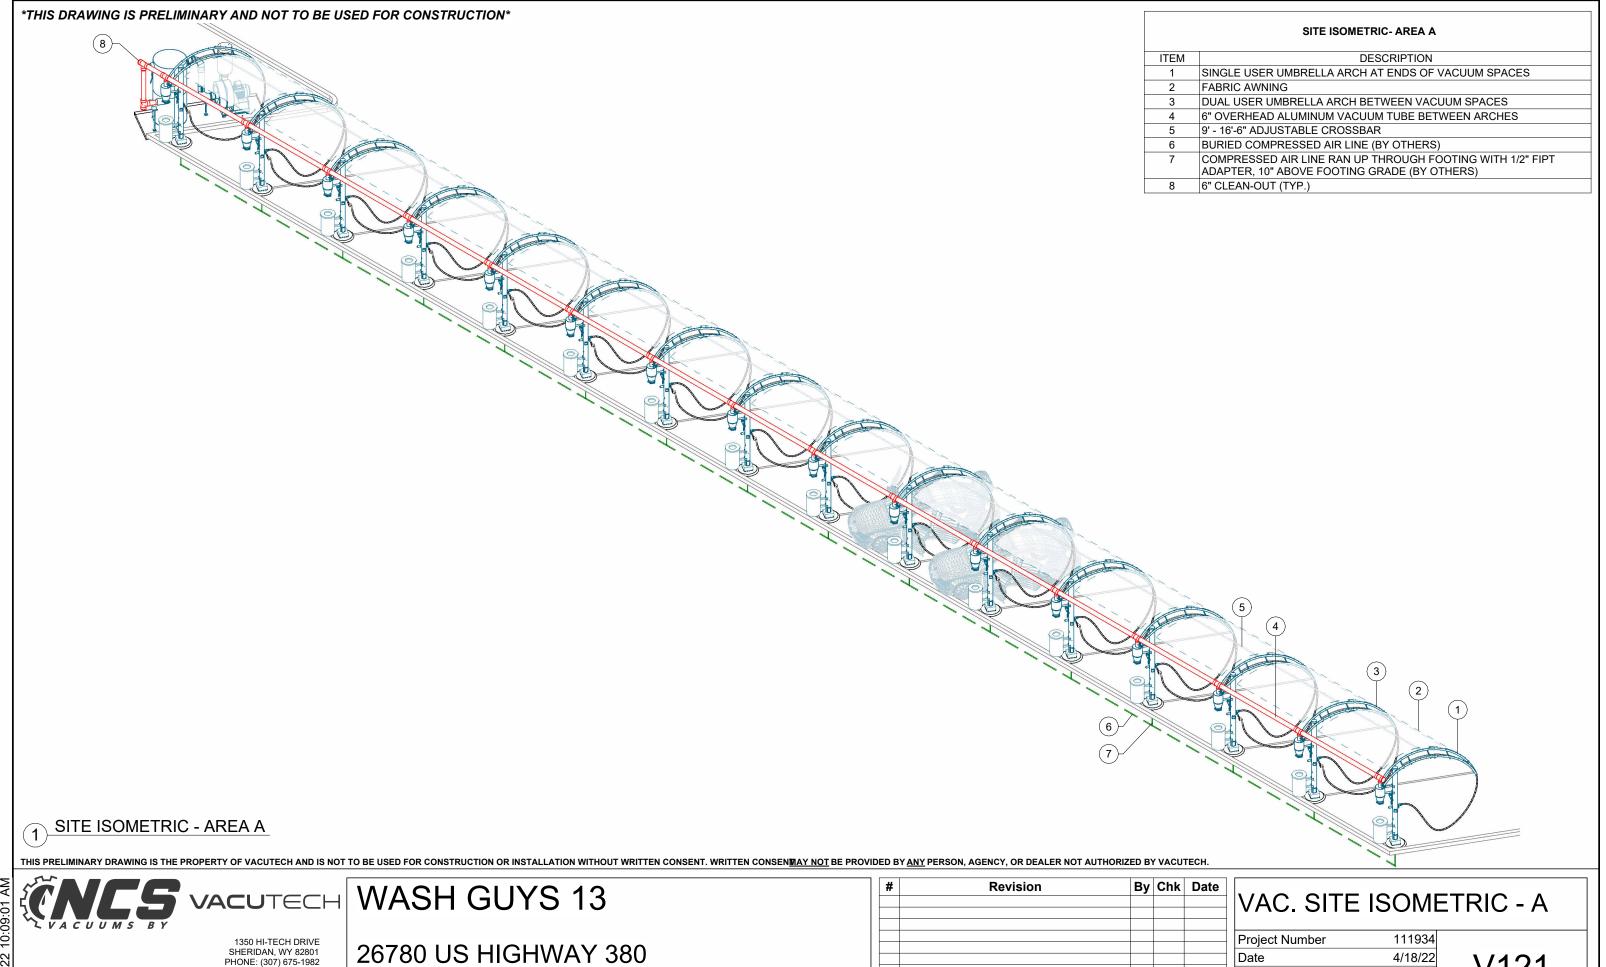
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4/18/22

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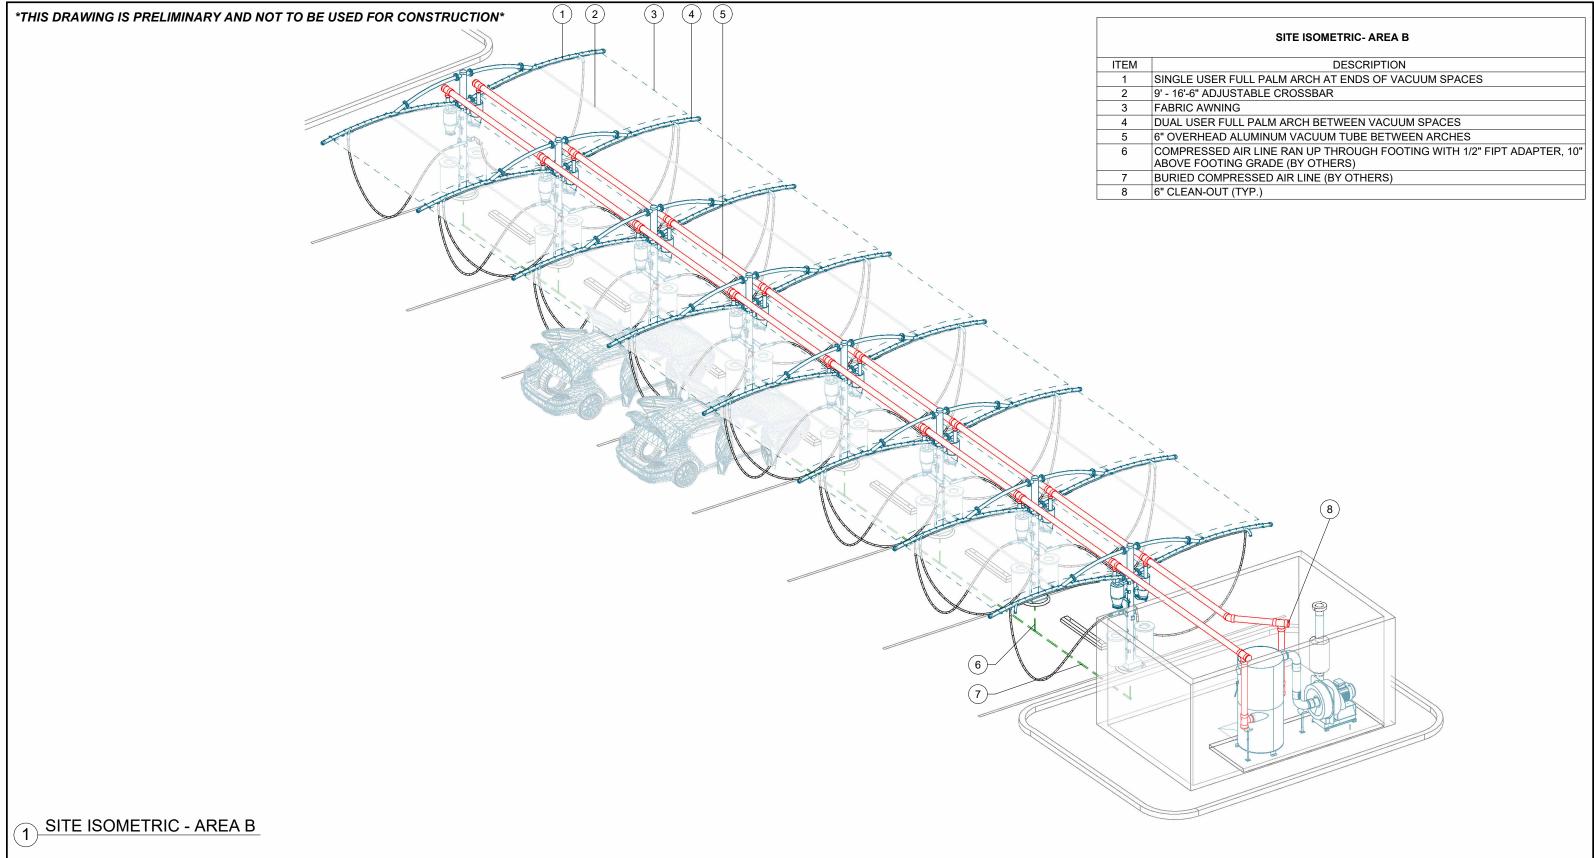
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