

**TOWN OF LITTLE ELM
ORDINANCE NO. 1802**

**AN ORDINANCE OF THE TOWN OF LITTLE ELM, TEXAS,
AMENDING THE COMPREHENSIVE ZONING ORDINANCE, BY
ESTABLISHING A NEW PLANNED DEVELOPMENT – SINGLE
FAMILY 4 (PD-SF4) DISTRICT BASED ON SINGLE FAMILY 4
STANDARDS, WITH MODIFIED DEVELOPMENT STANDARDS TO
ALLOW A NEW SUBDIVISION DEVELOPMENT ON A 10 ACRE
PROPERTY LOCATED 2,000 FEET NORTH OF THE INTERSECTION
OF US HWY 380 AND OAK GROVE; PROVIDING A SAVINGS
CLAUSE; CORRECTING THE OFFICIAL ZONING MAP; PROVIDING
A PENALTY; PROVIDING A SEVERABILITY CLAUSE; PROVIDING A
REPEALER CLAUSE; AND PROVIDING AN EFFECTIVE DATE.**

WHEREAS, the Town of Little Elm ("Town") is a home rule municipal corporation organized and existing by virtue of the Constitution and laws of the State of Texas and by its Charter adopted on May 1, 2001; and

WHEREAS, the Town possesses all the rights, powers, and authorities possessed by all home rule municipalities, including the authority to regulate land uses under Chapter 211 of the Texas Local Government Code; and

WHEREAS, a request to establish a Planned Development-Single Family 4 (PD-SF4) District based on Single Family 4 district with modified development standards, on approximately 10 acres of land, more specifically described in the exhibits, attached hereto; and

WHEREAS, this zoning change is in accordance with the most current adopted Comprehensive Plan of the Town of Little Elm; and

WHEREAS, the Town Council and the Planning & Zoning Commission of the Town of Little Elm, in compliance with the laws of the State of Texas and the ordinances of the Town of Little Elm, have given the required notices and held the required public hearings and afforded a full and fair hearing to all property owners generally and to all persons interested in and situated in the affected area and in the vicinity thereof regarding the requested zoning change described herein; and

WHEREAS, at its regular meeting held on February 20, 2025 the Planning & Zoning Commission considered and made recommendations on Case No. PD- 24-004830; and

WHEREAS, after due deliberations and consideration of the recommendation of the Planning & Zoning Commission and any other information and materials received at the public hearing, the Town Council of the Town of Little Elm, Texas, has determined that the request is in the interest of public health, safety and welfare of the citizens of the Town of Little Elm.

NOW, THEREFORE, BE IT ORDAINED BY THE TOWN COUNCIL OF THE TOWN OF LITTLE ELM, TEXAS:

SECTION 1. INCORPORATION OF PREMISES. The above and foregoing premises are true and correct and are incorporated herein and made a part hereof for all purposes.

SECTION 2. ZONING AMENDMENT. That Ordinance No. 226 of the Town of Little Elm, Texas, the same being the Comprehensive Zoning Ordinance of the Town, is hereby amended by establishing a new Planned Development-Single Family 4 (PD-SF4) based on Single Family 4 (SF4) district requirements with modified development standards, on property located at 2,000 feet north of the intersection of US HWY 380 and Oak Grove, within Little Elm's town limits, on approximately 10 acres of land more particularly described in **Exhibit A**, and attached hereto, subject to all of the terms and conditions set forth herein, the terms and conditions of the Comprehensive Zoning Ordinance, and all other applicable ordinances, laws, rules, regulations, and standards.

SECTION 3. CONDITIONS AND REGULATIONS. The permitted uses and standards shall be in accordance with the Single Family 4 (SF4), and all current, at the time of development, applicable provisions of Chapter 106 – Zoning Ordinance in general, plus as specified herein:

- a. The Zoning and Land Use Regulations, and all conditions set forth in **Exhibit B** attached hereto and made a part hereof for all purposes shall be adhered to in their entirety for the purposes of this Planned Development. In the event of conflict between the provisions of **Exhibit B** and provisions of any other exhibit, the provisions of **Exhibit B** control.

SECTION 4. PLANNED DEVELOPMENT MASTER PLAN. The Concept Plan and related plans, images, and documents approved and described as **Exhibit C** attached hereto and made a part hereof are approved. The subject property shall be improved in accordance with the plans set forth in **Exhibit C**.

- a. If, after two years from the date of approval of the Planned Development Master Plan, no substantial development progress has been made within the PD, then the Planned Development Master Plan shall expire. If the Planned Development Master Plan expires, a new Planned Development Master Plan must be submitted and approved according to the procedures within the Zoning Ordinance, Planned Development Districts. An extension of the two-year expiration shall be granted if a development application for the PD has been submitted and is undergoing the development review process or if the Director of Development Services determines development progress is occurring.
- b. The Planned Development Master Plan shall control the use and development of the property, and all building permits and development requests shall be in accordance with the plan until it is amended by the City Council.
- c. If a change to the Concept Plan, if any, is requested, the request shall be processed in accordance with the development standards in effect at the time the change is requested for the proposed development.

SECTION 5. SAVINGS. This Ordinance shall be cumulative of all other ordinances of the Town, and shall not repeal any of the provisions of those ordinances except in those instances where the provisions of those ordinances are indirect conflict with the provisions of this Ordinance; provided, however, that any complaint, notice, action, cause of action, or claim which prior to the effective date of this Ordinance has been initiated or has arisen under or pursuant to such other ordinance(s) shall continue to be governed by the provisions of that ordinance or those ordinances, and for that purpose that ordinance or those ordinances shall be deemed to remain and shall continue in full force and effect.

SECTION 5. ZONING MAP. The official zoning map of the Town shall be amended to reflect the changes in zoning made by this ordinance.

SECTION 6. PENALTY. Any person, firm, or corporation violating any of the provision of this ordinance shall be punished by a penalty of a fine not to exceed the sum of Two Thousand Dollars (\$2,000) for each offense and each and every day such offense shall continue shall be deemed to constitute a separate offense.

SECTION 7. SEVERABILITY. The sections, paragraphs, sentences, phrases, and words of this Ordinance are severable, and if any section or provision of this ordinance or the application of that section or provision to any person, firm, corporation, situation or circumstance is for any reason judged invalid or unconstitutional, the adjudication shall not affect any other section or provision of this ordinance or the application of any other section or provision to any person, firm, corporation, situation or circumstance, nor shall adjudication affect any other section or provision of the Comprehensive Zoning Ordinance of the Town of Little Elm, Texas, and the Town Council hereby declares that it would have

adopted the valid portions and applications of the ordinance without the valid parts and to this end the provisions of this ordinance shall remain in full force and effect.

SECTION 8. REPEALER. That all ordinances of the Town of Little Elm in conflict with the provisions of this ordinance be and the same are hereby repealed to the extent of that conflict.

SECTION 9. EFFECTIVE DATE. That this Ordinance shall take effect immediately upon its adoption and publication in accordance with and as provided by law and the Town Charter.

PASSED AND APPROVED by the Town Council of the Town of Little Elm, Texas on the 4th day of March, 2025.

Town of Little Elm, Texas

Curtis Cornelious, Mayor

ATTEST:

Caitlan Biggs, Town Secretary

Exhibit A
Property Description

Exhibit B
PD Exhibits



SUB-DIVISION AT OAK GROVE PLANNED DEVELOPMENT DISTRICT

This zoning submittal encompasses approximately 10 acres of land within the Town of Little Elm, more fully described on the legal description attached as Exhibit A (the “Property”). The planned development (“PD”) will allow for a new residential development consisting of a 50 single family residential lots.

This PD will provide the zoning regulations as depicted in Exhibit B. The final layout must generally conform with Exhibit C.

It is the intent of this PD to primarily follow the Single-Family 4 (SF4) zoning regulations as the base districts, with modified development standards as outlined within Exhibit B, therefore amending the existing Town of Little Elm, Texas zoning map. Any conflict between this PD and the Zoning Ordinance shall be resolved in favor of the regulations set forth in this PD, or as may be ascertained through the intent of this PD. As used herein, “Zoning Ordinance” means the comprehensive zoning of the Town of Little Elm, Texas, in effect on the effective date of this PD, except as otherwise defined within this PD. Uses and development regulations specifically modified, designated or included in this PD shall not be subject to amendment after the date of the adoption of this PD (11/07/2024) (whether through the amendment of the Zoning Ordinance or otherwise), except through an amendment of this PD. Uses and development regulations which otherwise are not specifically modified, designated or included in this PD shall be controlled by the “Zoning Ordinance”, as it may be amended unless context provides to the contrary, as determined by the Director.

As used herein, “Director” means the Director of Development Services.

PROJECT LOCATION

The proposed PD is located approximately 1900 L.F. north of U.S. 380 & Oak Grove Lane intersection. (Exhibit A).


CONCEPT PLAN

The Concept Site Plan attached hereto as Exhibit C, and incorporated herein by reference, demonstrate potential locations and relationships of the uses permitted under this PD. An amendment to a concept plan approved as a part of the ordinance establishing the planned development district is a change in zoning district classification and must follow the same procedures set forth in Section 106.04.03, except the Director may approve minor revisions which do not alter the basic relationship of the proposed development and align with the overall intent of this PD.



EXHIBIT A

PROJECT LOCATION

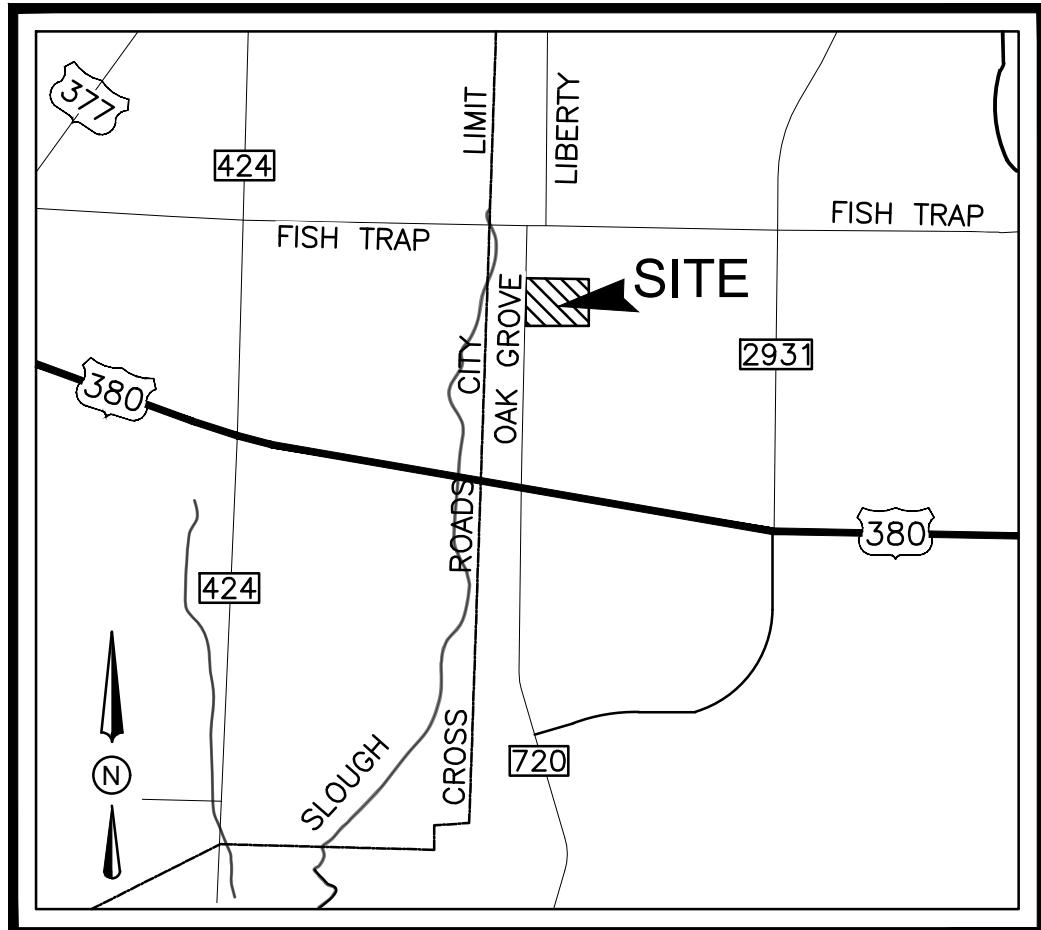

VICINITY MAP
N.T.S.

EXHIBIT-A
SUB-DIVISION AT OAK GROVE
TOWN OF LITTLE ELM
DENTON COUNTY, TX 76227

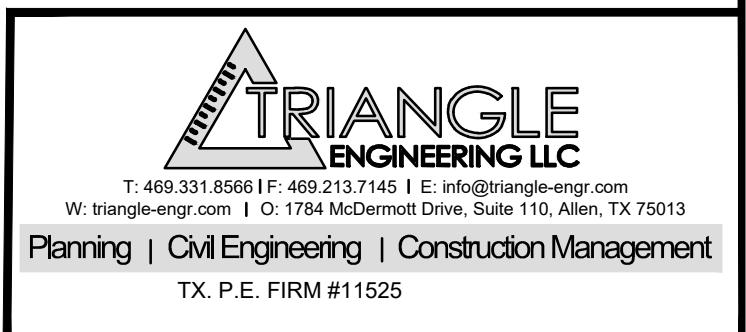




EXHIBIT B

DEVELOPMENT STANDARDS



DEVELOPMENT STANDARDS

Except as otherwise set forth in these development standards, the development of this area shall follow the regulation of the Town Little Elm's Code of Ordinances in general, and more specifically Chapter 106 - Zoning Ordinance, Chapter 107 - Subdivision Ordinance, and Chapter 86 – Sign Ordinance, as they exist, or may be amended, at the time of development.

GENERAL CONDITIONS FOR PD:

1. BASE ZONING DISTRICT

The permitted uses and standards will be in accordance with the Single-Family 4 (SF4) zoning and the district as defined in the Zoning Ordinance, unless otherwise specified in the PD regulations.

2. USE REGULATIONS

All permitted uses in the Single-Family 4 (SF4) district shall be allowed with the same provisions and restrictions, including uses permitted by a Specific Use Permit (SUP) and Conditional Use Permit (C), except as noted below:

3. LOT REGULATIONS

Front yard setbacks, side yard setbacks, rear yard setbacks, building height, maximum floor area, lot width, lot area, and lot coverage shall be in accordance with the Zoning Ordinance, reference Sec. 106.03.02 - Zoning districts—Residential, (g) SF-4 Single-Family District, unless otherwise specified here in.

- *Minimum Side Yard on Corner: 10'*
- *Minimum Side Yard: 5'*
- *Minimum Front Yard: 15'*
- *Minimum Lot Width: 40'*
- *Minimum Lot Area: 4400 sf*
- *Maximum Height: Block A Lots 13-18: 25' and single-story*

4. ARCHITECTURAL STANDARDS

Architectural and building design standards shall be in accordance with the Zoning Ordinance reference section 106.06.03, Division 1 - Exterior Construction and Architectural Design Standards reference for residential structures, unless otherwise specified here in.

- Driveway width-16'
- Driveway location: Block A, Lot 1 driveway in Taper with 2 car parking



5. LANDSCAPING STANDARDS

All provisions within Article VI. Division 2. Landscaping and Tree Preservation shall be met, as it exists or may be amended in accordance with the standards in effect at the time of development, or requested change, unless otherwise shown on the Landscape Plans attached hereto, or unless specified.

- Tree mitigation capped at \$150,000.00

6. SCREENING STANDARDS

All provisions within Article VI. Division 3 Screening Walls and Fences shall be met except as specified below:

- Screening Fence Material : Wood

7. PARKING STANDARDS

All provisions within Article VI. Division 4. Parking, Stacking, and Loading Standards shall be met except unless specified.


Exhibit C
Development Plans

PRELIMINARY SITE DEVELOPMENT PLANS

FOR

ARBORS AT OAK GROVE

OAK GROVE ROAD
CITY OF LITTLE ELM
DENTON COUNTY, TEXAS
10.00 ACRES

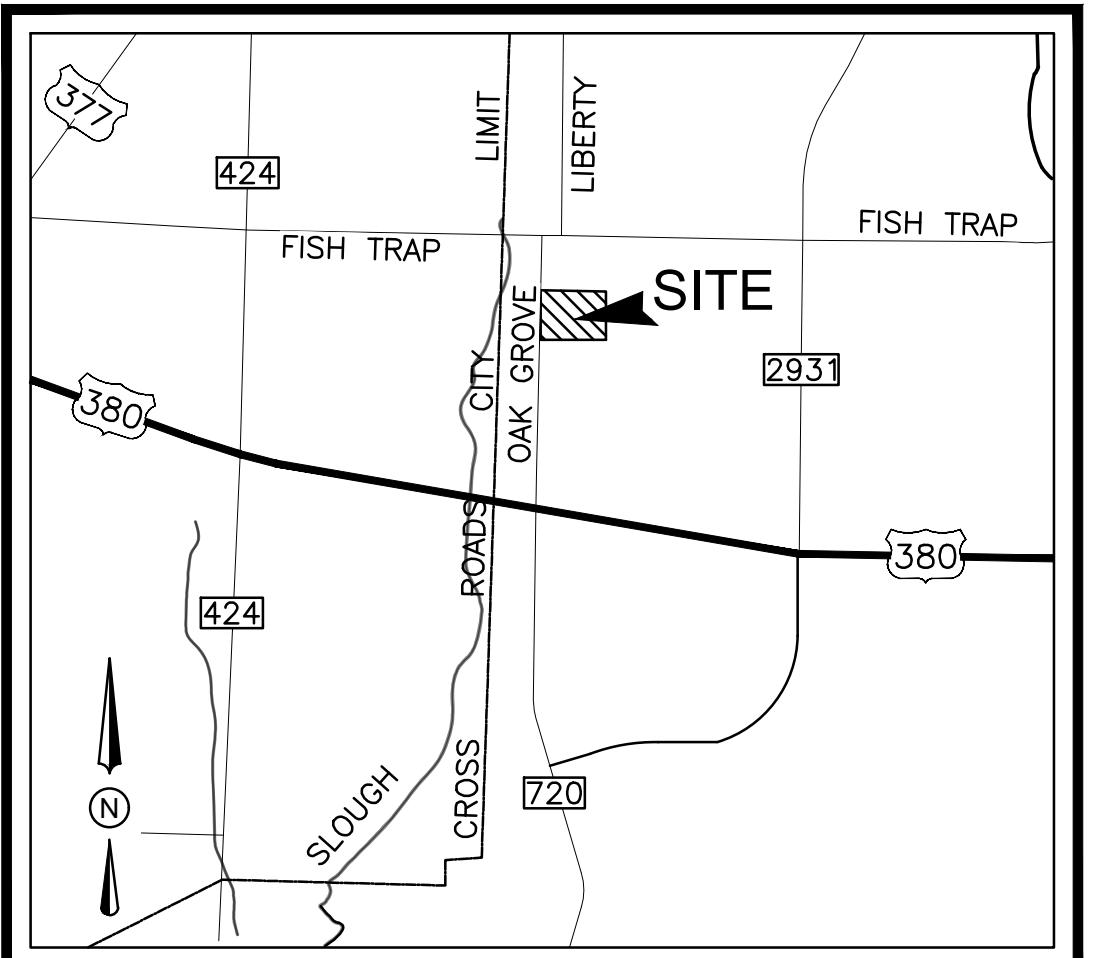

VICINITY MAP
N.T.S.

SHEET LIST TABLE	
SHEET NUMBER	SHEET TITLE
C-1.0	COVER SHEET
C-2.0	SITE PLAN
C-3.0	PRE-DRAINAGE PLAN
XASBLT-1	AS-BUILT DRAINAGE AREA MAP
XASBLT-2	AS-BUILT DRAINAGE AREA MAP
C-4.0	POST-DRAINAGE AREA MAP
C-5.0	UTILITY PLAN
C-6.0	PRELIMINARY PAVING PLAN
C-7.0	SIGNAGE PLAN

BENCHMARK NOTES

THE BENCHMARKS AND ELEVATIONS SHOWN ARE BASED ON THE NORTH AMERICAN VERTICAL DATUM 1988 (NAVD88) BY USING GPS OBSERVATIONS IN CONJUNCTION WITH THE ALLTERRA RTK NETWORK. SHOT CITY BENCHMARKS:
563.48' = ELEVATION
577.34' = ELEVATION

BENCHMARK NO. 1
FROM THE MOST SOUTHWESTERLY CORNER EAST
18.82 FEET THENCE NORTH 5.68 FEET TO A "SQUARE CUT X" ON A CONCRETE INLET. ELEVATION: 597.28'

PROJECT CONTACT LIST	
ENGINEER TRIANGLE ENGINEERING LLC 1782 W. McDERMOTT DRIVE ALLEN, TEXAS 75013 CONTACT: KARTAVYA PATEL, P.E. PHONE: 469-331-8566	OWNER PO BOX 866128 PLANO, TX 75086 CONTACT: SUNIL KONANKI PHONE: 512-797-5346
SURVEYOR TRaverse Land Surveying 14200 MIDWAY ROAD, SUITE 130 DALLAS, TEXAS 75244 CONTACT: DAVID F. McCULLAH PHONE: 469-784-9321	



NO.	DATE	DESCRIPTION	BY
1	08/05/24	1st ZONNING PD SUBMITTAL	KP
2	09/03/24	2ND ZONING PD SUBMITTAL	KP
3	12/19/24	3RD ZONING PD SUBMITTAL	KP
4	01/15/25	4TH ZONING PD SUBMITTAL	KP
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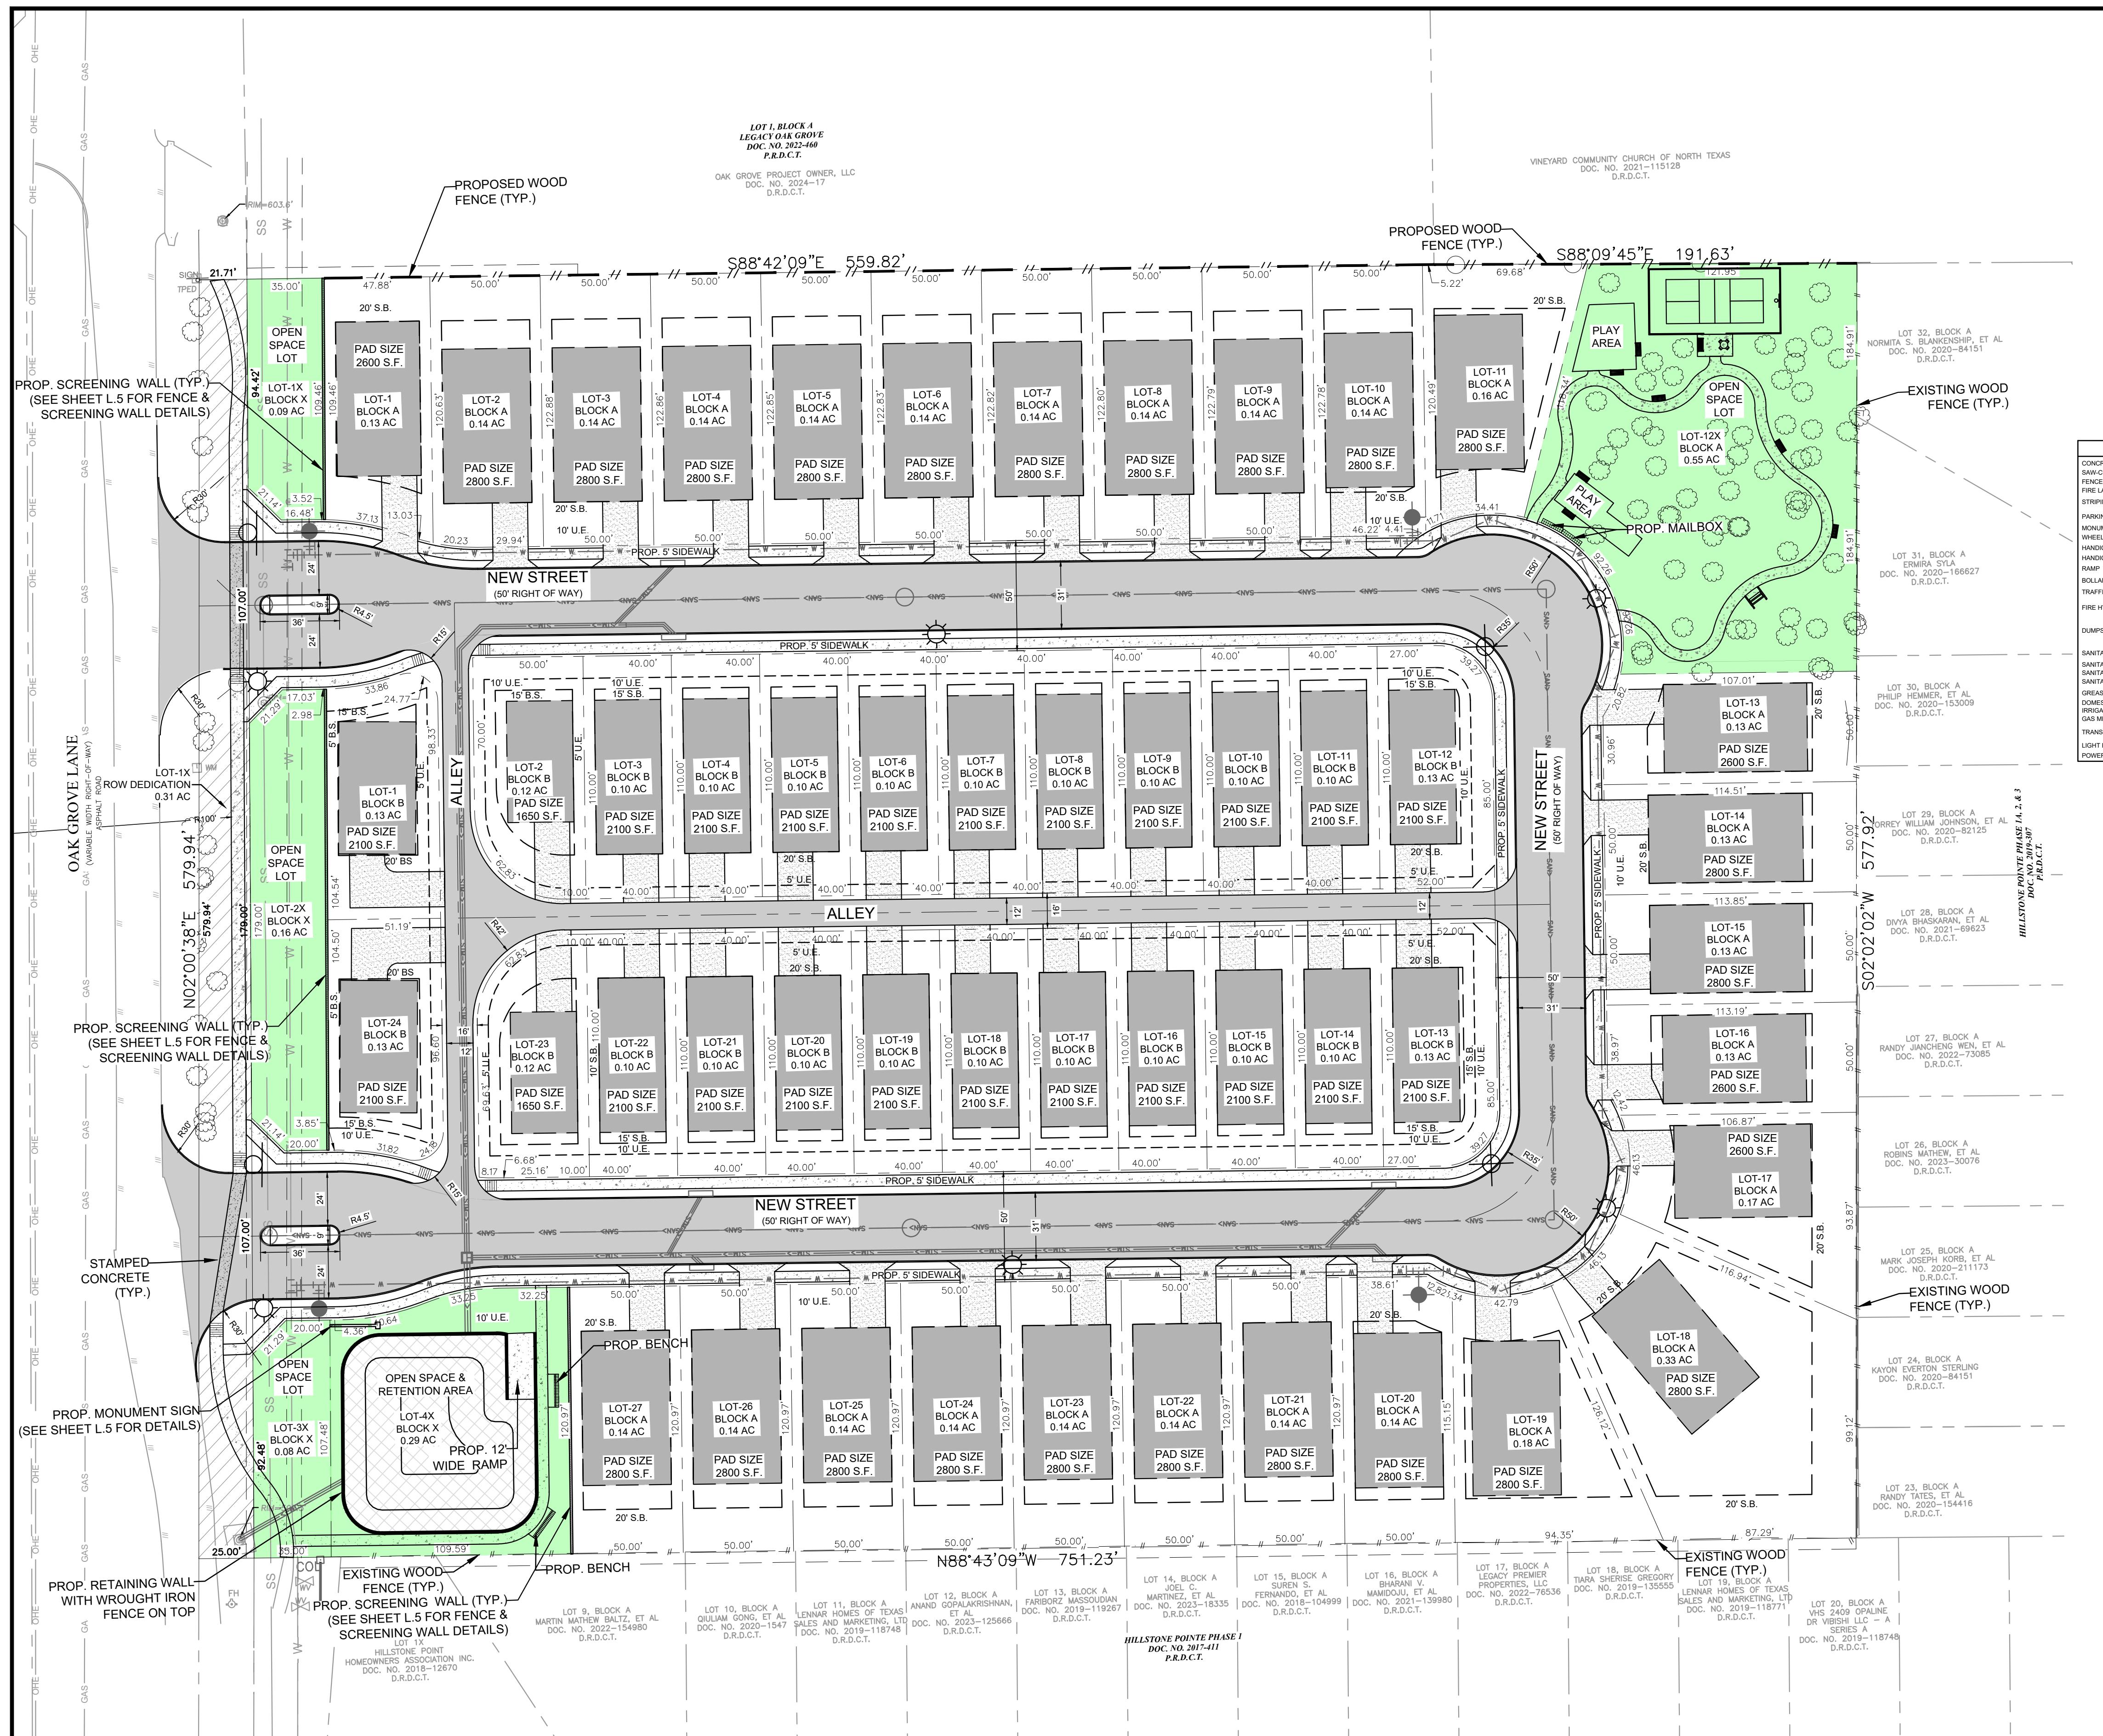
01/15/25

STATE OF TEXAS
KARTAVYA S. PATEL
PROFESSIONAL ENGINEER
LIC# 97534

Planning | Civil Engineering | Construction Management

T: 469.331.8566 | F: 469.213.7145 | E: info@triangle-engr.com
W: triangle-engr.com | O: 1784 McDermott Drive, Suite 110, Allen, TX 75013

P.E. DES. DATE SCALE PROJECT NO. SHEET NO.
KP RK 08/05/24 SC 077-24
TX. P.E. FIRM #11525 C-1.0



FLOOD NOTES:

NO PORTION OF THE SUBJECT PROPERTY SHOWN HEREON LIES WITHIN THE 100 YEAR FLOOD HAZARD AREA ACCORDING TO THE FLOOD INSURANCE RATE MAP, COMMUNITY PANEL NO. 48121C0405G, DATED APRIL 18, 2011. THE SUBJECT PROPERTY IS LOCATED IN THE AREA DESIGNATED AS ZONE "X", (AREAS DETERMINED TO BE OUTSIDE THE 0.2% ANNUAL CHANCE FLOOD PLAIN).

CERTIFICATION OF SUBMITTED INFORMATION:

I HEREBY CONFIRM THAT THE ABOVE DETAILED INFORMATION AS REQUIRED BY THE CHECKLIST IS COMPLETE AND ACCURATE TO THE BEST OF MY KNOWLEDGE. I UNDERSTAND THAT PROPER TOWN STAFF REVIEW OF THIS APPLICATION IS DEPENDENT UPON THE ACCURACY OF THE INFORMATION PROVIDED AND THAT ANY INACCURATE OR INADEQUATE INFORMATION PROVIDED BY ME OR MY FIRM MAY DELAY THE PROPER REVIEW OF THIS APPLICATION.

Answers - Chapter 1

Date

Firm

CERTIFICATION OF SUBMITTED INFORMATION:

HEREBY CERTIFY THAT THE ABOVE STATED INFORMATION IS INCLUDED WITH THE ACCOMPANYING SUBMISSION MATERIALS. FURTHER, I HAVE INCLUDED ANY REQUIRED CONDITIONS OF SITE PLAN, AS LISTED IN SECTION 106.02.15 AND OF THE LANDSCAPE PLAN, AS LISTED IN SECTION 106.06.13 OF THE ZONING ORDINANCE.

Applicant's Signature

ate

NO.	DATE	DESCRIPTION	BY
	08/05/24	1st ZONNING PD SUBMITTAL	KP
	09/03/24	2ND ZONING PD SUBMITTAL	KP
	12/19/24	3RD ZONING PD SUBMITTAL	KP
	01/15/25	4TH ZONING PD SUBMITTAL	KP
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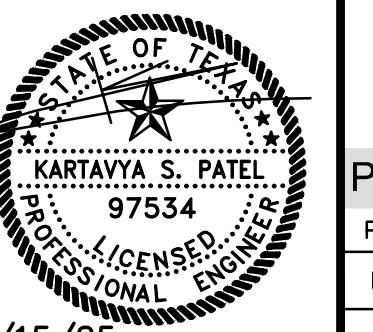
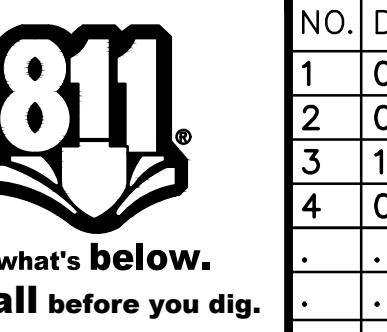


EXHIBIT - C

SITE PLAN

BORS AT OAK GROVE

EXHIBITS FOR PD

TOWN OF LITTLE ELM

ENTON COUNTY, TEXAS 76227

10

TRIANGLE

**TRI-TECH
ENGINEERING LLC**


8566 | F: 469.213.7145 | E: Info@triangle-enr.com
om | O: 1784 McDermott Drive, Suite 110, Allen, T

Engineering | Construction Management

DATE	SCALE	PROJECT NO.	SH
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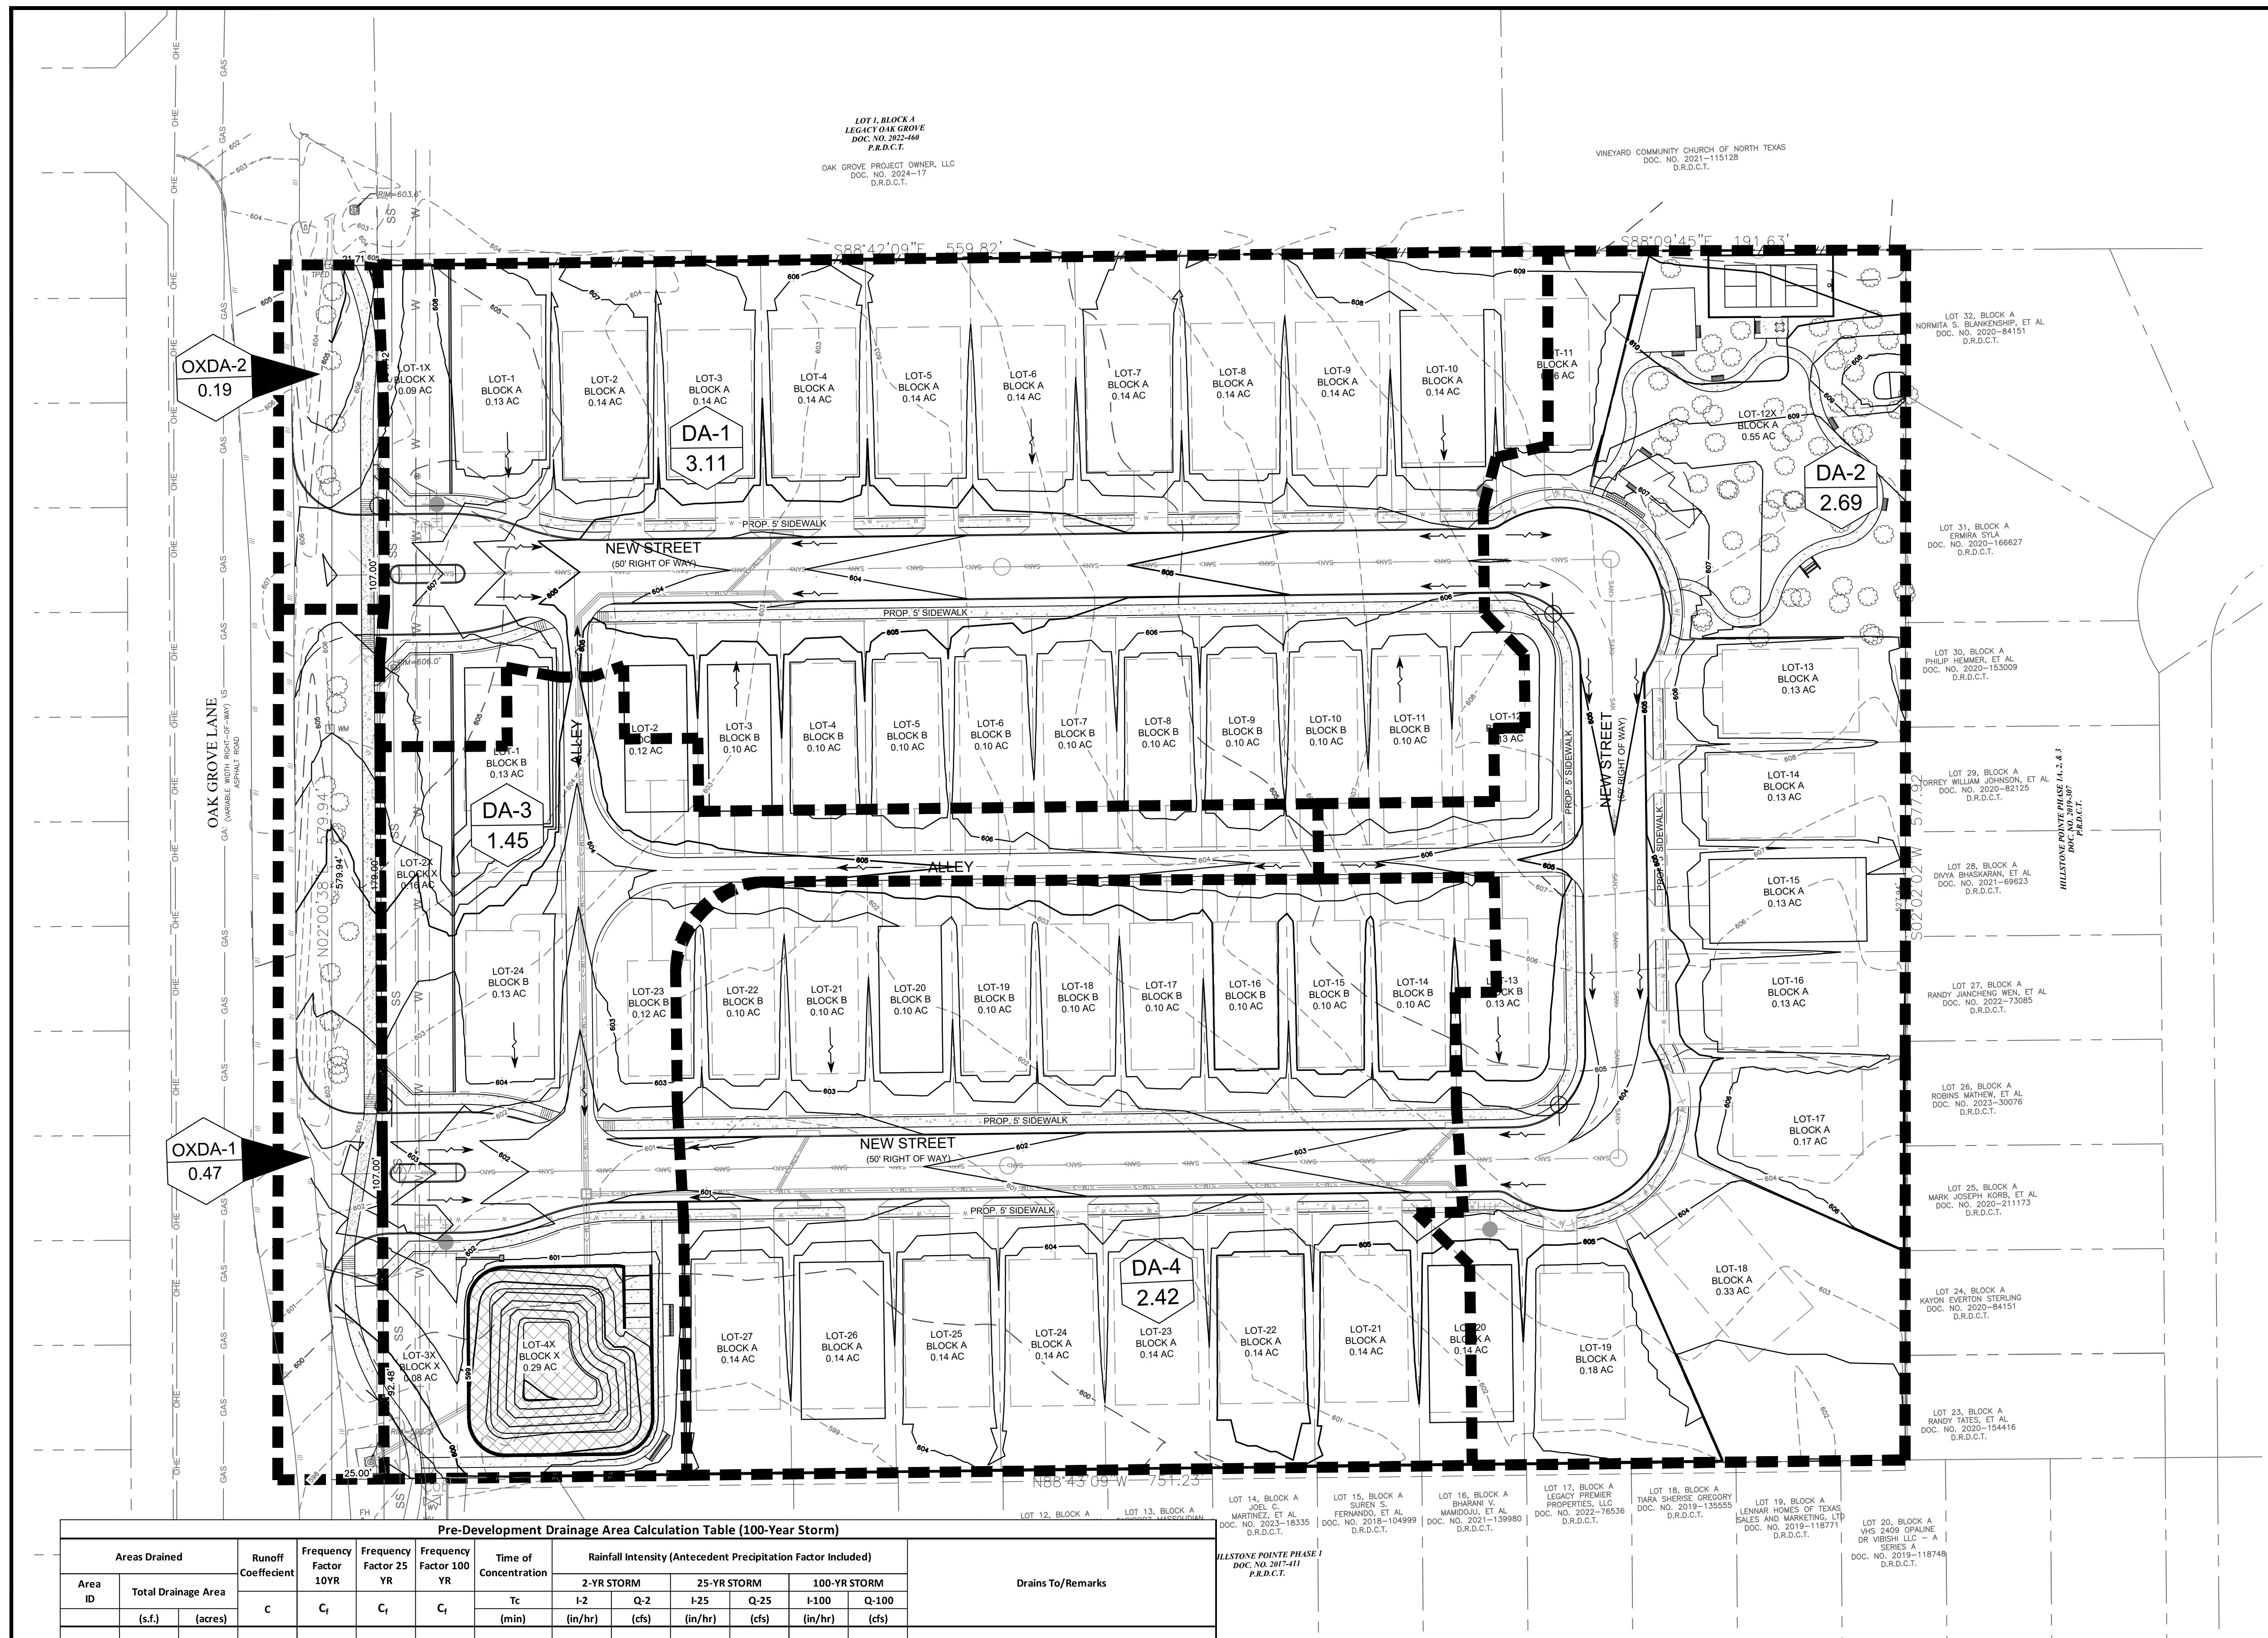
P.E. FIRM #11525

Digitized by srujanika@gmail.com



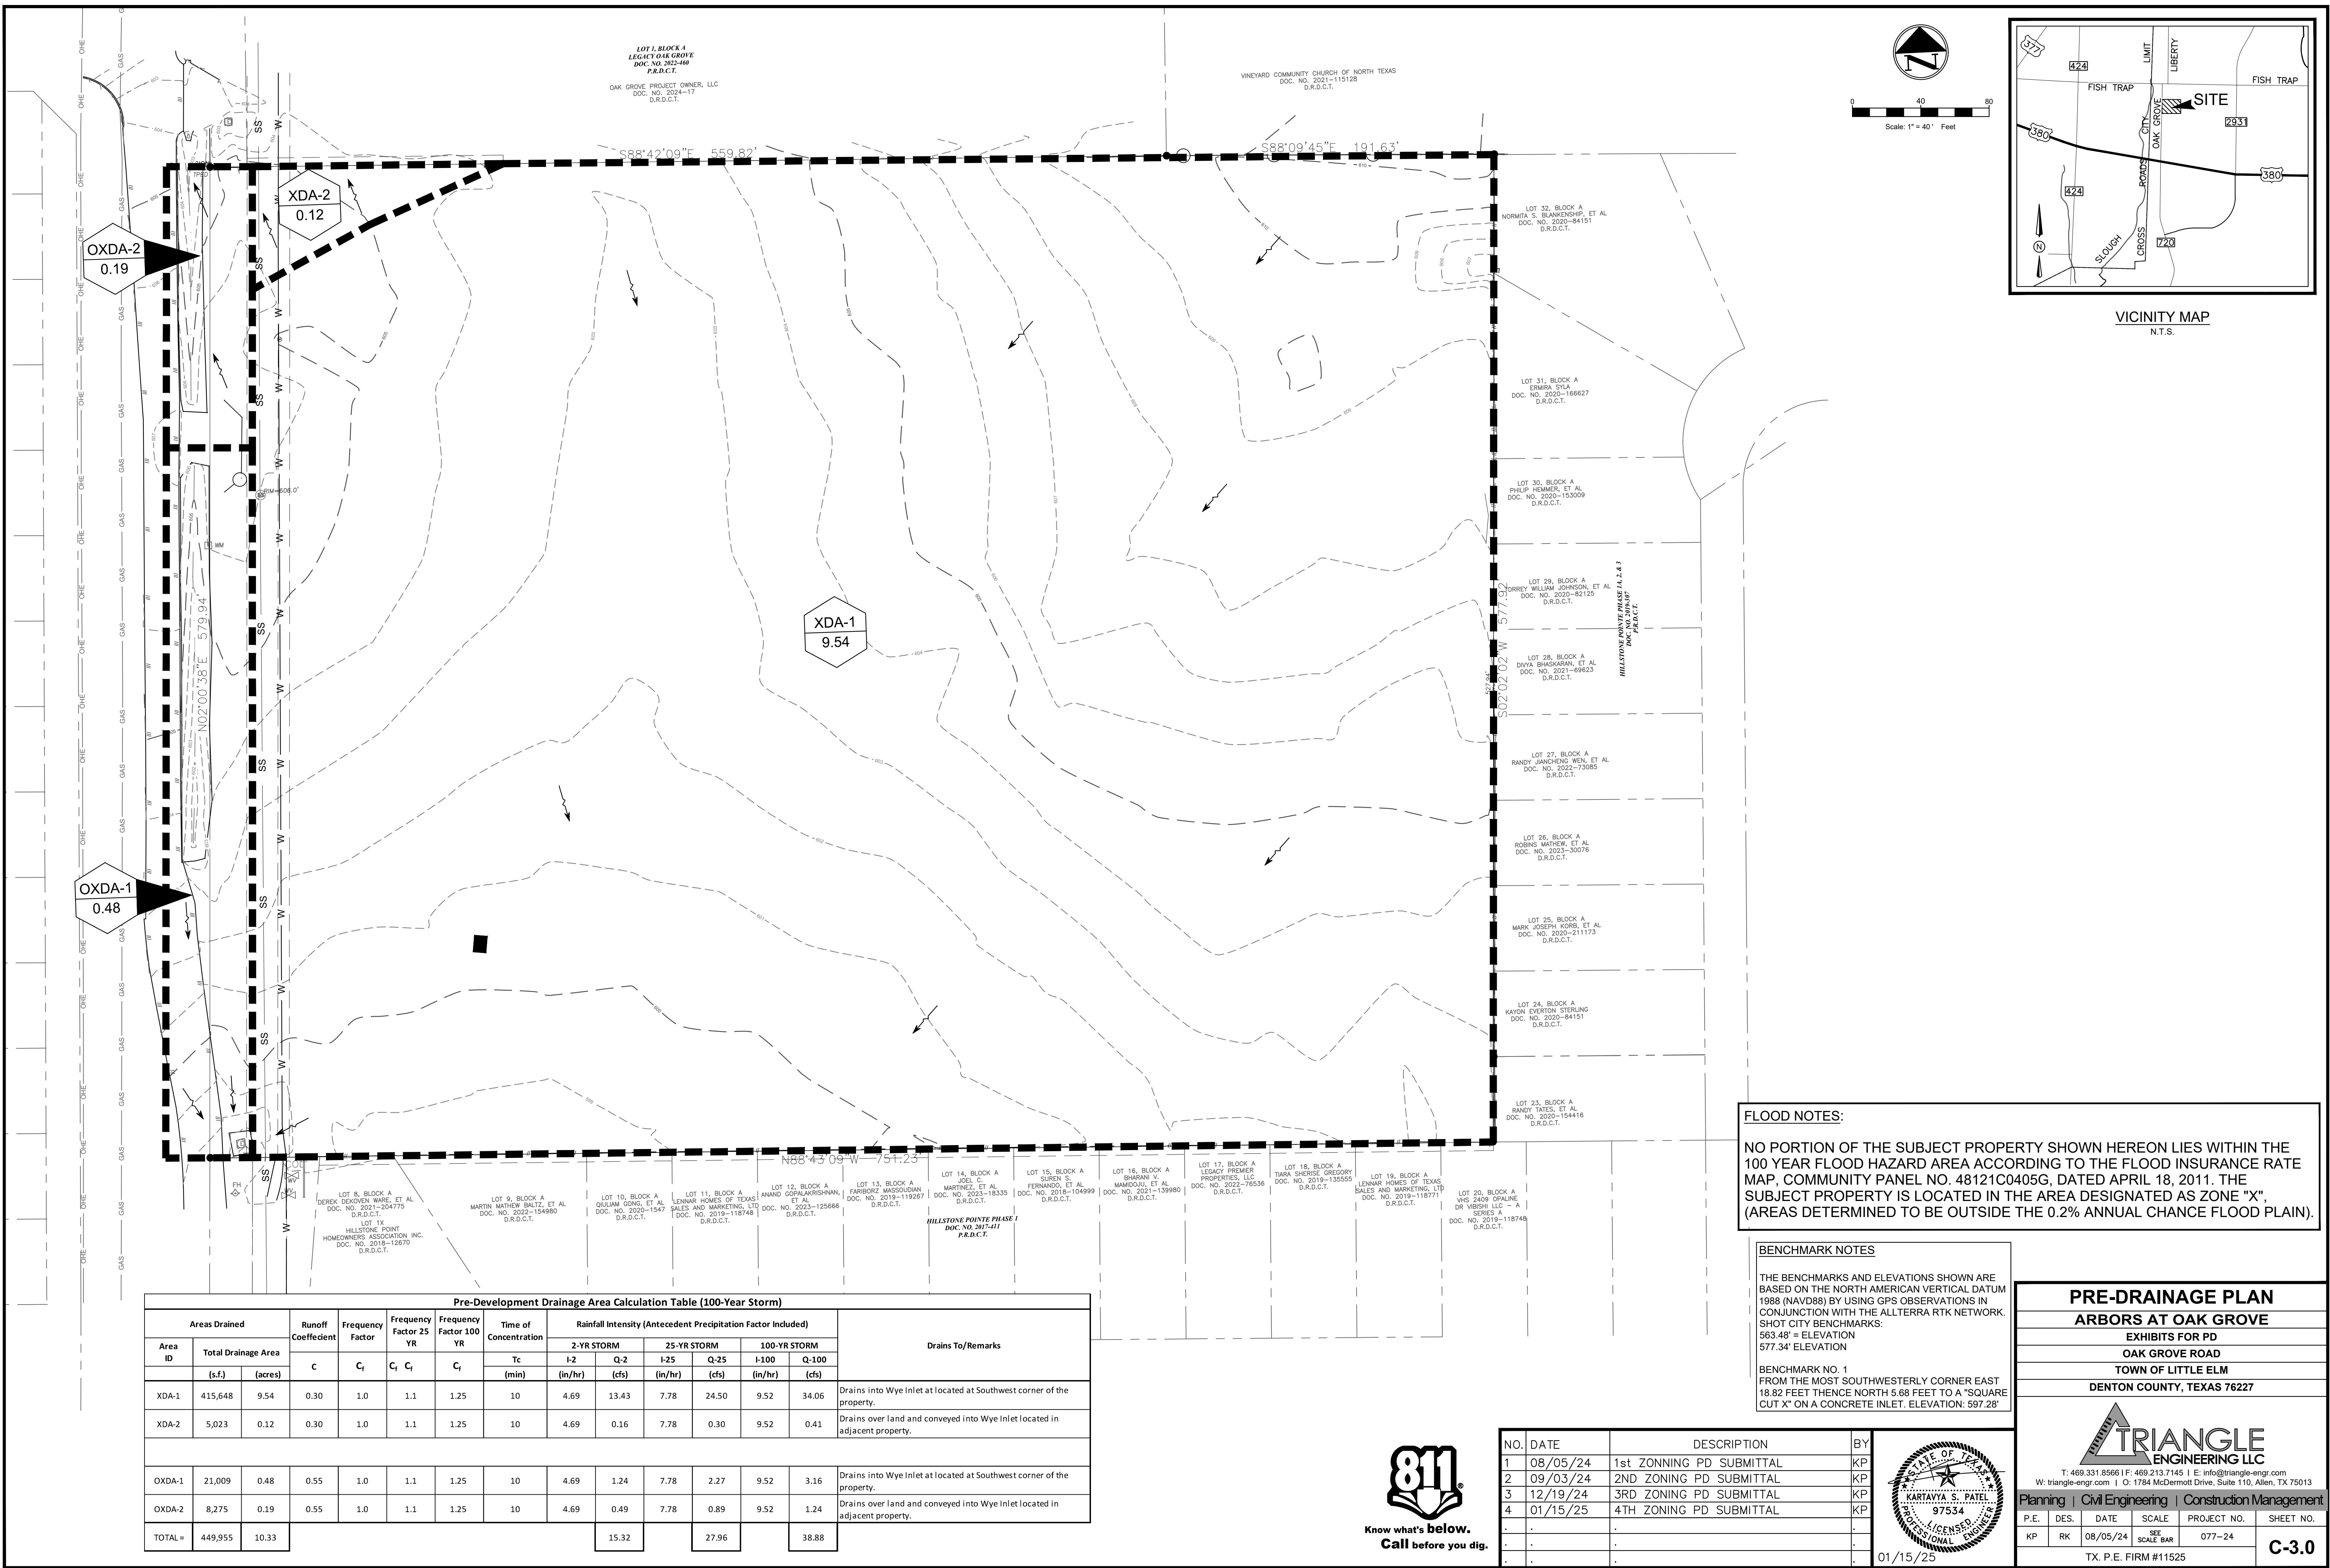

0 40 80
Scale: 1" = 40' Feet



POST-DRAINAGE LEGEND	
EXISTING MINOR CONTOURS	464
EXISTING MAJOR CONTOURS	465
MINOR CONTOURS	464
MAJOR CONTOURS	465
DRAINAGE DIVIDE	HP
HIGH POINT	HP
DRAINAGE AREA NO.	DA-X
DRAINAGE AREA ACREAGE	X.XX
DRAINAGE FLOW DIRECTION	→

BENCHMARK NOTES
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BENCHMARK NO. 1 FROM THE MOST SOUTHWESTERLY CORNER EAST 18.82 FEET THENCE NORTH 5.68 FEET TO A 'SQUARE CUT X' ON A CONCRETE INLET. ELEVATION: 597.28'

Pre-Development Drainage Area Calculation Table (100-Year Storm)

Areas Drained		Runoff Coefficient	Frequency Factor 10YR	Frequency Factor 25YR	Frequency Factor 100YR	Time of Concentration	Rainfall Intensity (Antecedent Precipitation Factor Included)				Drains To/Remarks			
Area ID	Total Drainage Area (s.f.)						C _f	C _f	C _f	Tc (min)				
	(acres)	C	C _f	C _f	C _f		(in/hr)	(in/hr)	(in/hr)	(in/hr)				
DA-1	135,363	3.11	0.55	1.0	1.1	1.25	10	4.69	8.02	7.78	14.63	9.52	20.34	Drains to Detention Pond Via Inlet
DA-2	117,370	2.69	0.55	1.0	1.1	1.25	10	4.69	6.95	7.78	12.68	9.52	17.64	Drains to Detention Pond Via Inlet
DA-3	63,211	1.45	0.55	1.0	1.1	1.25	10	4.69	3.74	7.78	6.83	9.52	9.50	Drains to Detention Pond Via Inlet
DA-4	110,231	2.53	0.55	1.0	1.1	1.25	10	4.69	6.53	7.78	11.91	9.52	16.56	Drains to Detention Pond Via Inlet
OXDA-1	20,584	0.47	0.55	1.0	1.1	1.25	10	4.69	1.22	7.78	2.22	9.52	3.09	Drains into Wye Inlet located at Southwest corner of the property.
OXDA-2	8,162	0.19	0.55	1.0	1.1	1.25	10	4.69	0.48	7.78	0.88	9.52	1.23	Drains over land and conveyed to adjacent property.
TOTAL	454,922	10.44					26.94		49.16		68.35			


NOTE:
ALL THE INLETS AND PIPE SIZES ARE BASED ON PRELIMINARY GRADING AND DRAINAGE AND SUBJECT TO CHANGE AT THE TIME OF FINAL DESIGN.




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12/19/24

TX. P.E. FIRM #11525 C-4.0



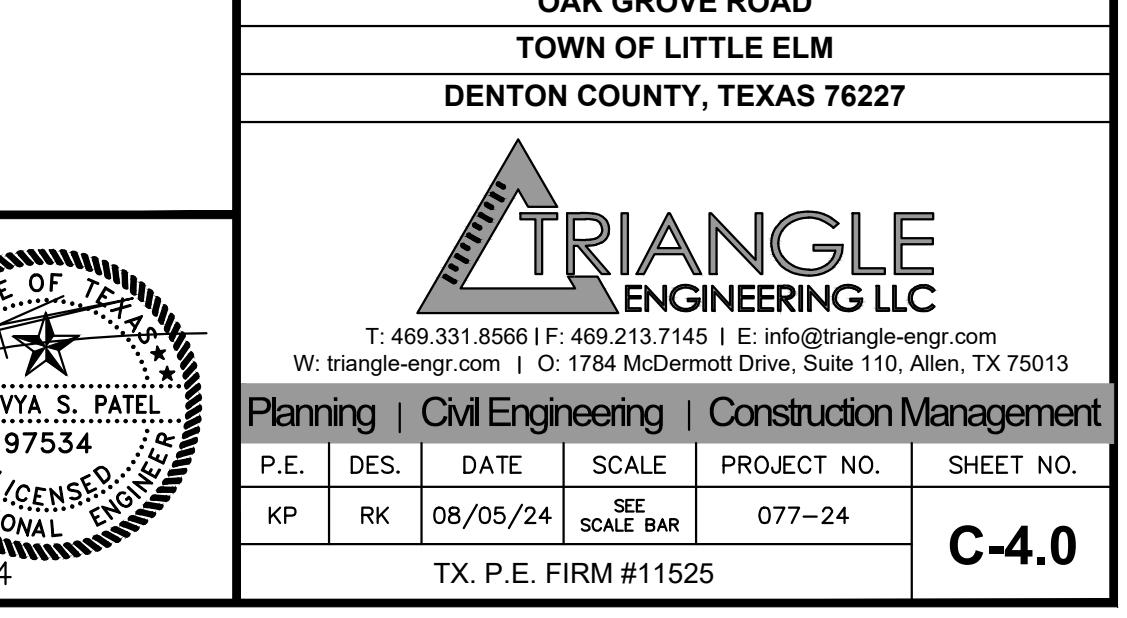


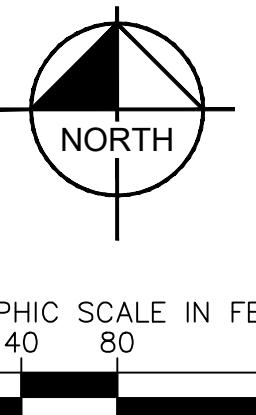GRAPHIC SCALE IN FEET
0 40 80 160

DRAINAGE GENERAL NOTES

- OFFSITE DRAINAGE AREAS SHOWN PER PROPOSED HILLSTONE POINTE WEST PHASE 2 PLAN SET DATED 12/1/2016
- DRAINAGE AREA A, OS.A.1, OS.A.1, OS.A.2, OS.A.3, OS.A.4, OS.A.5 ARE BASED ON CONDITIONS POINTE WEST ACCOUNTED FOR THE AREAS UNDER A PROPOSED DEVELOPMENT WITH THE CONDITIONS OF A $T_c = 15$ MIN, $C_r = 0.60$, $i = 7.91$ IN/HR. THE Q_{100} FOR DRAINAGE AREA A ACCOUNTED FOR BY POINTE WEST IS $Q_{100} = 55.91$ CFS.
- LAT S05, LAT A1, LAT A2, LAT B1 ARE SHOWN PER POINTE WEST PLANS FOR THE HGL AND T_c

LEGEND

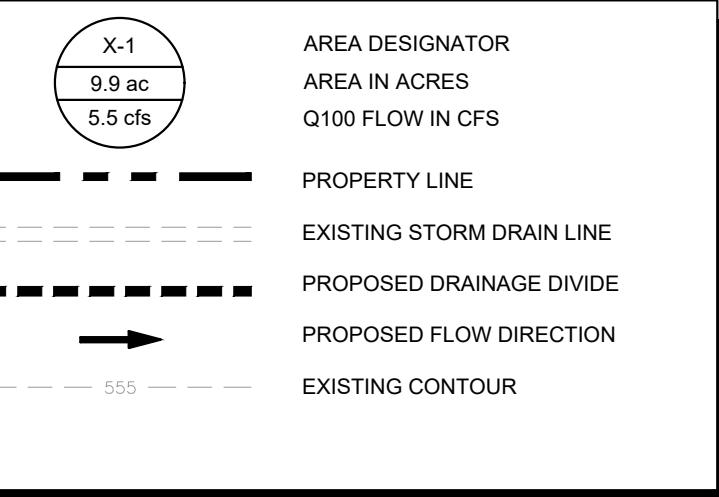

DRAINAGE AREA TABLE


DRAINAGE AREA NO.	AREA (ac)	ANTECEDENT FACTOR	RUNOFF COEFFICIENT "C"	RAINFALL INTENSITY "I" 100 (in/hr)	TIME OF CONCENTRATION (minutes)	TOTAL FLOW Q100 (cfs)	LAND USE
A	11.78	1.00	0.30	7.91	22.7	23.2	ONSITE
A-OS.1a	0.21	1.00	0.60	7.91	15.0	1.0	1/4 AC. RESIDENTIAL
A-OS.1b	0.73	1.00	0.60	7.91	15.0	3.5	1/4 AC. RESIDENTIAL
A-OS.1c	0.48	1.00	0.60	7.91	15.0	2.3	1/4 AC. RESIDENTIAL
A-OS.1d	0.91	1.00	0.60	7.91	15.0	4.3	1/4 AC. RESIDENTIAL
A-OS.1e	0.32	1.00	0.60	7.91	15.0	1.5	1/4 AC. RESIDENTIAL
A-OS.1f	0.11	1.00	0.60	7.91	15.0	0.5	1/4 AC. RESIDENTIAL
A-OS.2	1.25	1.00	0.60	9.24	10.0	6.9	PER HILLSTONE POINTE WEST PHASE 2 PLAN
A-OS.4.1	1.99	1.00	0.65	7.91	15.0	10.2	1/8 AC. RESIDENTIAL
A-OS.4.2	0.78	1.00	0.65	7.91	15.0	4.0	1/8 AC. RESIDENTIAL
A-OS.5.1	3.24	1.00	0.65	7.91	15.0	16.6	1/8 AC. RESIDENTIAL
A-OS.5.2	1.35	1.00	0.65	7.91	15.0	6.9	1/8 AC. RESIDENTIAL
B-OS.1a	0.22	1.00	0.70	9.24	10.0	1.5	COMMERCIAL
B-OS.1b	0.26	1.00	0.70	9.24	10.0	1.7	COMMERCIAL
B-OS.1c	0.35	1.00	0.70	9.24	10.0	2.3	COMMERCIAL
B-OS.1d	0.14	1.00	0.70	9.24	10.0	0.9	COMMERCIAL
B-OS.2	1.44	1.00	0.70	9.24	10.0	9.3	COMMERCIAL
C-OS.1	0.11	1.00	0.60	7.91	15.0	0.5	AGI PER LITTLE ELM ZONING
C-OS.2	0.32	1.00	0.60	9.24	10.0	1.8	FUTURE ROW
D-OS.1	0.14	1.00	0.30	7.91	15.0	0.3	OFFSITE AGI

100 - YEAR PRE PROJECT CONDITION PEAK FLOW						
POINT OF INTEREST	CUMULATIVE AREAS (ACRES)	CUMULATIVE C*A	TOTAL TIME OF CONCENTRATION	I ₁₀₀	Q _{HILLSTONE}	Q ₁₀₀
DESIGN POINT A	17.39	7.89	22.7	6.55	83.90	51.70
DESIGN POINT B	18.64	6.95	22.9	6.52	N/A	45.31
DESIGN POINT C	26.00	12.76	23.7	6.40	N/A	81.71

*TC BASED ON ROUTED FLOW TIME THROUGH STORM NETWORK
Q_{HILLSTONE} IS PRE RECORD DRAWING "HILLSTONE POINTE WEST PHASE 2" DATED 12/06/2016

Kimley»Horn

13455 NOEL RD. TWO GALLERIA OFFICE TOWER
SUITE 700 DALLAS, TX 75240
PHONE: 972-770-1300 FAX: 972-239-3820
WWW.KIMLEY-HORN.COM TX F-928
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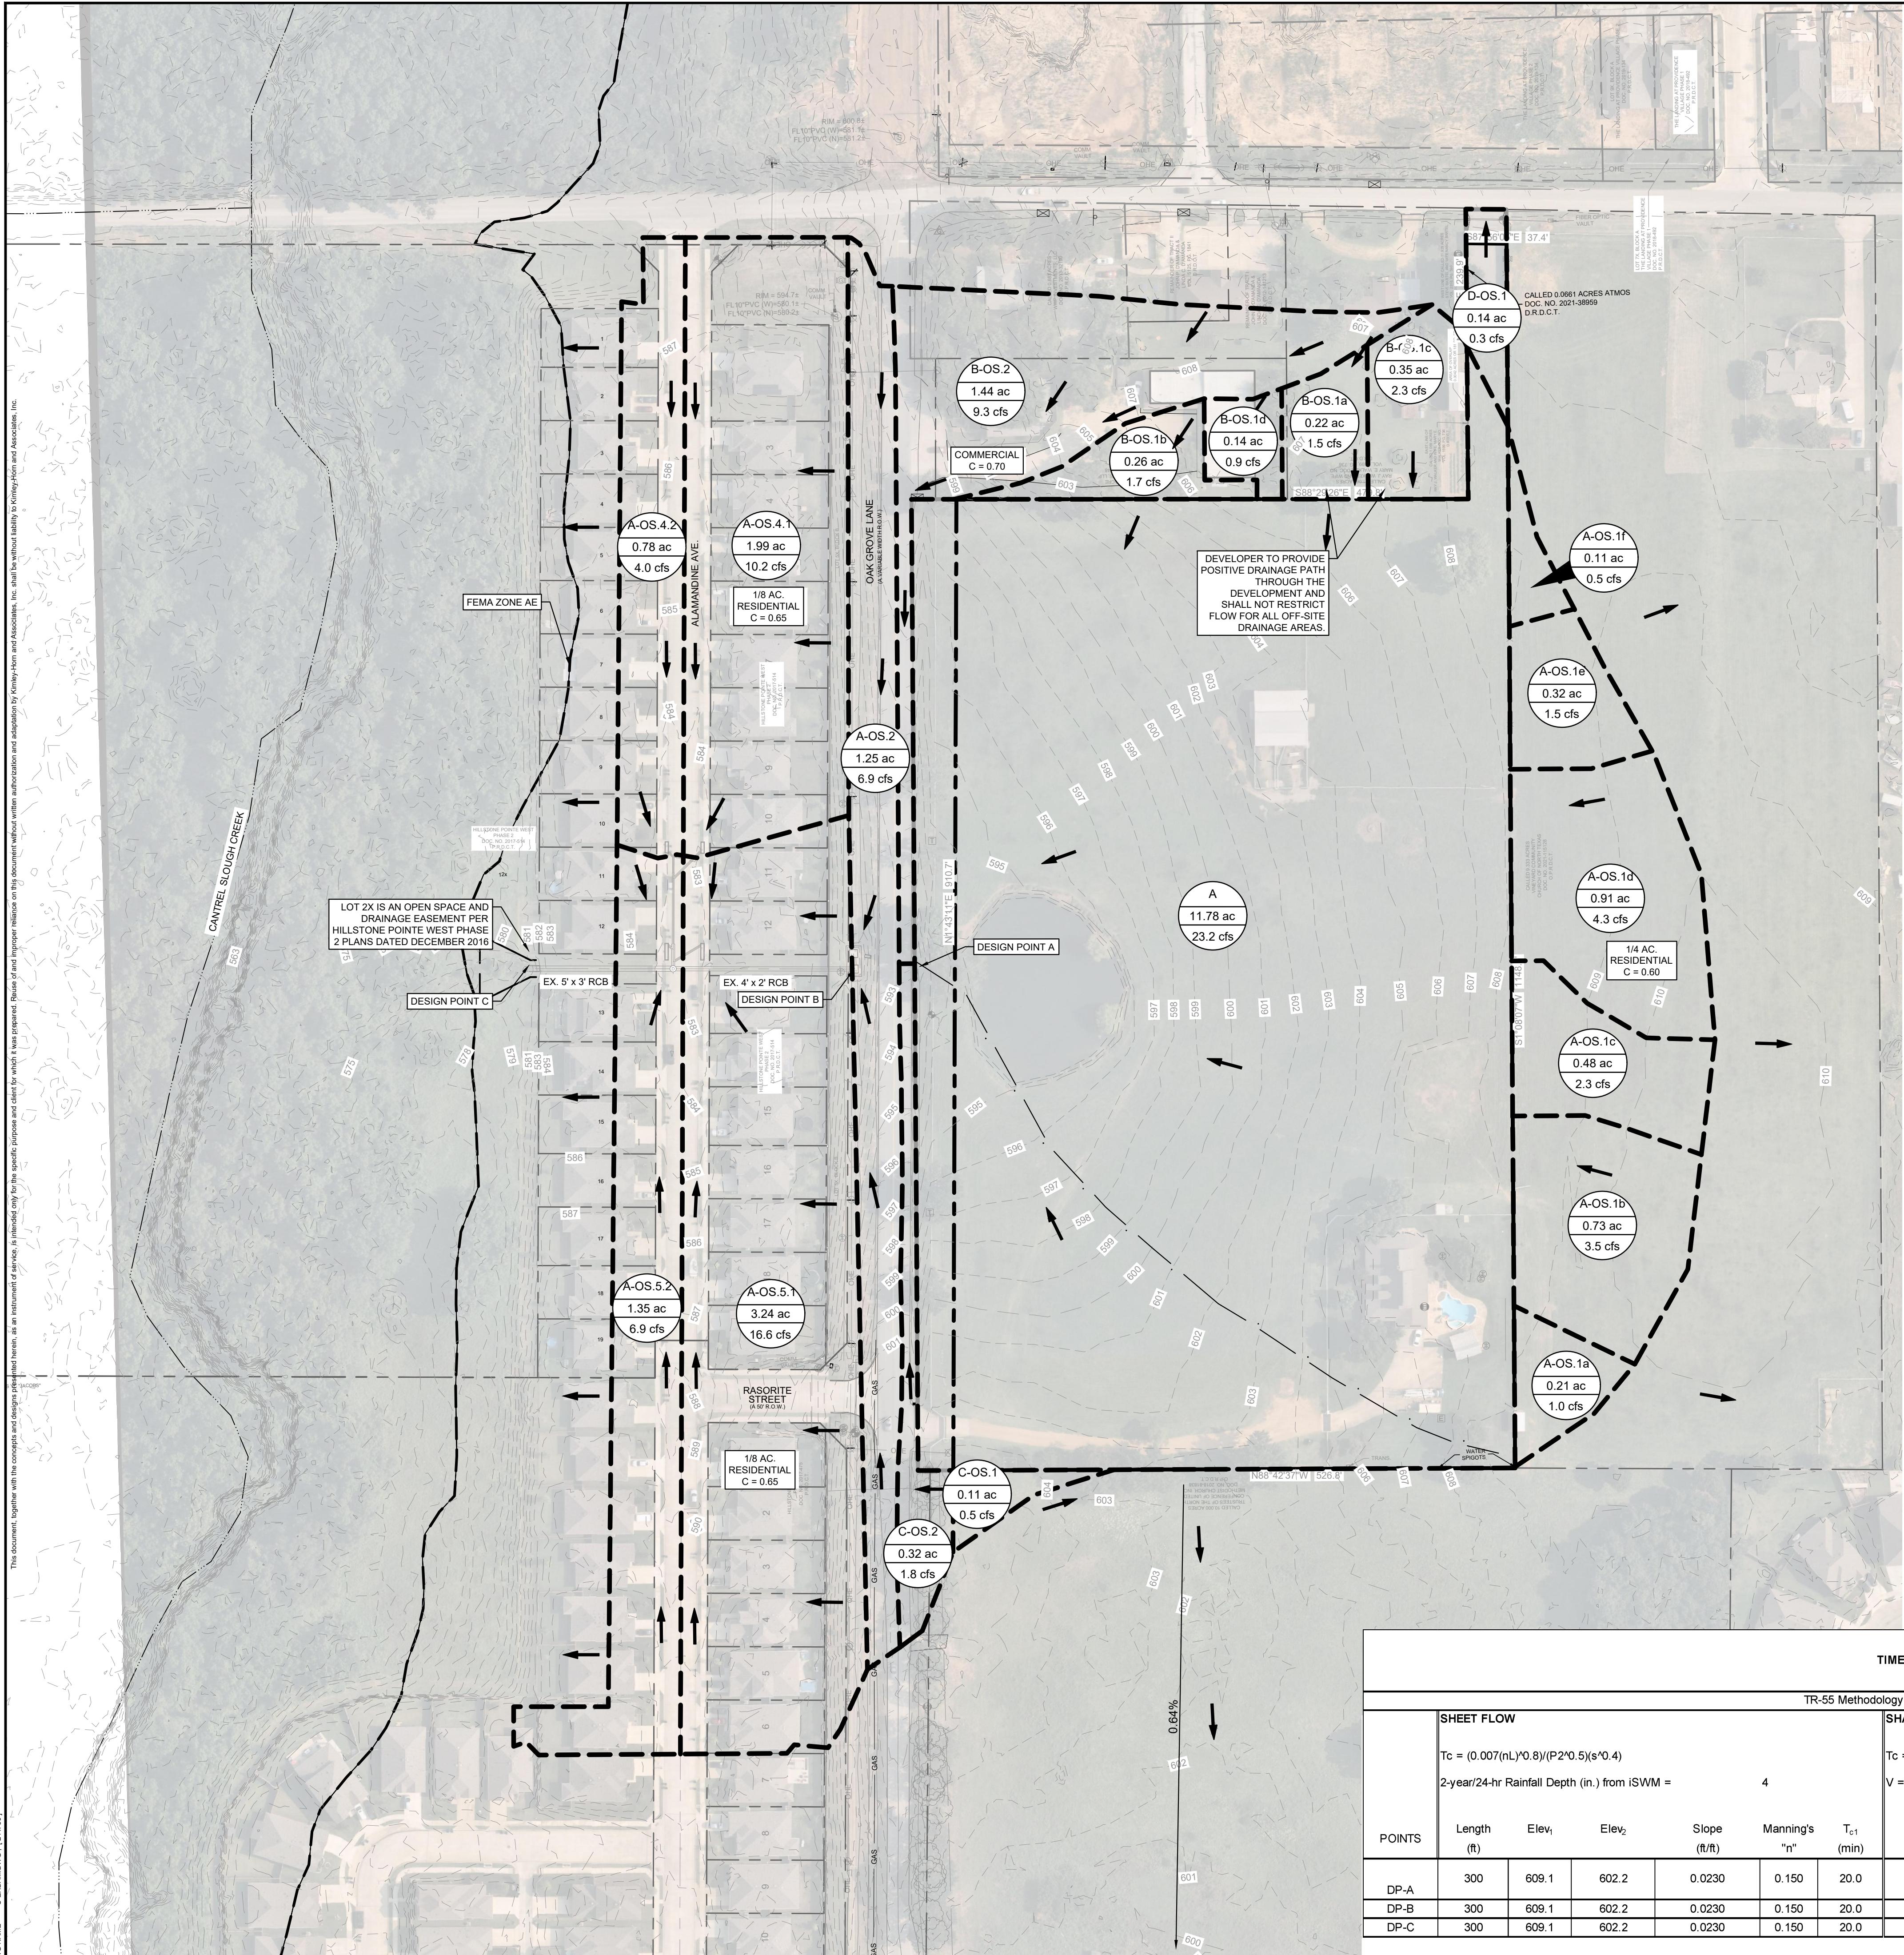


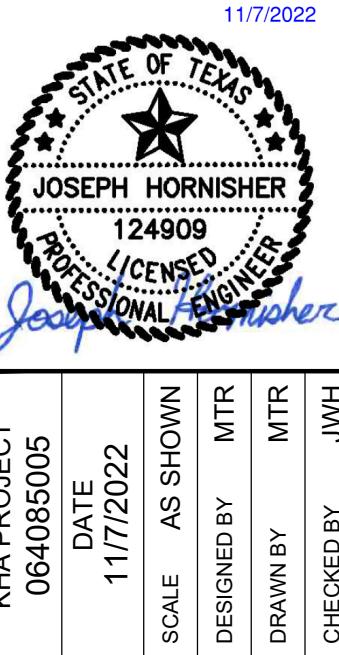LEGACY OAK GROVE
PREPARED FOR
LEGACY PARTNERS
TOWN OF CROSS ROADS ETU, TEXAS

XASBLT-1

TIME OF CONCENTRATION & LAG TIME																	
TR-55 Methodology																	
POINTS	SHEET FLOW						SHALLOW CONCENTRATED FLOW					PIPE FLOW	TOTAL				
	Tc = (0.007(nL)^0.6)/(P^2(0.5)(s^0.4))	2-year/24-hr Rainfall Depth (in.) from iSWM =	4				Tc = L / 60'V	V = (1.49/n)^R^(2/3)s^(1/2)									
POINTS	Length (ft)	Elev ₁	Elev ₂	Slope (ft/ft)	Manning's "n"	T _{c1} (min)	Length (ft)	Elev ₁	Slope (ft/ft)	Condition TR-55 Fig. 3-1	V _{avg} (ft/s)	T _{c2} (min)	Length (ft)	V _{avg} (ft/s)	T _{c3} (min)	T _{cTOTAL} * (min)	T _{lag} 0.6*T _c (min)
DP-A	300	609.1	602.2	0.0230	0.150	20.0	437	602.200	590.000	Unpaved	2.70	2.7	-	-	-	22.7	13.6
DP-B	300	609.1	602.2	0.0230	0.150	20.0	437	602.200	590.000	Unpaved	2.70	2.7	80	6.00	0.22	22.9	13.7
DP-C	300	609.1	602.2	0.0230	0.150	20.0	437	602.200	590.000	Unpaved	2.70	2.7	380	6.00	1.06	23.7	14.2

SHEET NUMBER
C-400



Kimley-Horn

13455 NOEL RD. TWO GALLERIA OFFICE TOWER
SUITE 700, DALLAS, TX 75240

PHONE: 972-770-1300 FAX: 972-239-3820

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LEGACY OAK GROVE PREPARED FOR LEGACY PARTNERS

TOWN OF CROSS ROADS ETU, TEXAS


PROPOSED DRAINAGE AREA MAP

SHEET NUMBER
C-401

DRAINAGE NOTES

- OFFSITE DRAINAGE AREAS PROVIDED FROM HILLSTONE POINTE WEST PHASE 2 PLAN SET DATED 12/1/2016
- REFER TO RAS REPORT FOR ANALYSIS ON HYDRAULIC PARAMETERS OF OUTFALL AND CHANNELS
- FOR ALL CHANNEL CROSS SECTIONS FOR REACH A & B FOR THE EAST AND WEST CHANNEL REFER TO THE RAS REPORT ON SHEET C-406 & C-407 FLOW, VELOCITY, WSE, FREEBOARD, SLOPE, & MANNINGS N.

LEGEND

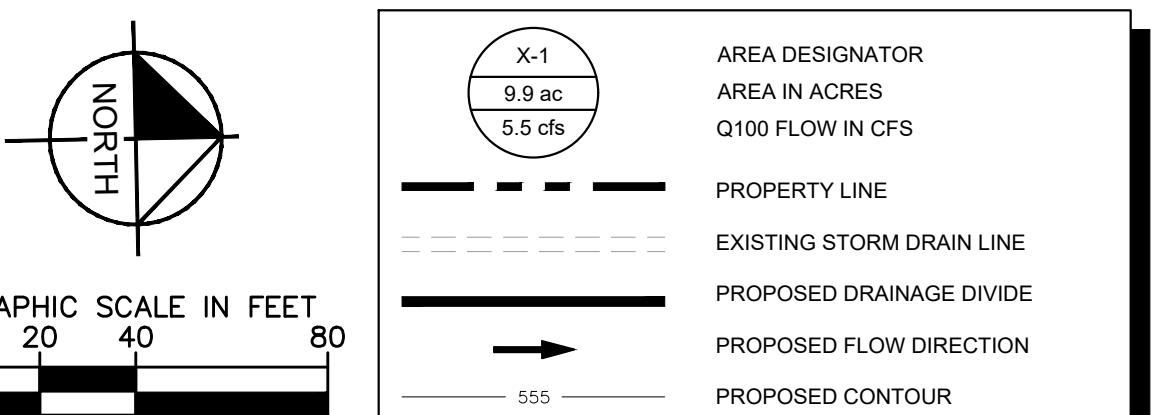

DRAINAGE AREA TABLE


DRAINAGE AREA NO.	AREA (ac)	ANTECEDENT FACTOR	RUNOFF COEFFICIENT "C"	RAINFALL INTENSITY "I" 100 (in/hr)	TIME OF CONCENTRATION (minutes)	TOTAL FLOW Q100 (cfs)
A-1	2.14	1.00	0.66	7.91	15.0	11.2
A-2	1.00	1.00	0.66	7.91	15.0	5.2
A-3	0.98	1.00	0.66	7.91	15.0	5.1
A-4	0.71	1.00	0.66	7.91	15.0	3.7
A-5	1.60	1.00	0.66	7.91	15.0	8.3
A-6a	0.44	1.00	0.66	7.91	15.0	2.3
A-6b	0.35	1.00	0.66	0.00	15.0	0.0
A-OS.1a	0.21	1.00	0.60	7.91	15.0	1.0
A-OS.1b	0.73	1.00	0.60	7.91	15.0	3.5
A-OS.1c	0.48	1.00	0.60	7.91	15.0	2.3
A-OS.1d	0.91	1.00	0.60	7.91	15.0	4.3
A-OS.1e	0.32	1.00	0.60	7.91	15.0	1.5
A-OS.1f	0.11	1.00	0.60	7.91	15.0	0.5
A-OS.2	1.25	1.00	0.60	9.24	10.0	6.9
A-OS.4.1	1.99	1.00	0.65	7.91	15.0	10.2
A-OS.4.2	0.78	1.00	0.65	7.91	15.0	4.0
A-OS.5.1	3.24	1.00	0.65	7.91	15.0	16.6
A-OS.5.2	1.35	1.00	0.65	7.91	15.0	6.9
B-1	1.52	1.00	0.66	7.91	15.0	7.9
B-2	0.09	1.00	0.66	7.91	15.0	0.5
B-OS.1a	0.22	1.00	0.70	9.24	10.0	1.5
B-OS.1b	0.26	1.00	0.70	9.24	10.0	1.7
B-OS.1c	0.35	1.00	0.70	9.24	10.0	2.3
B-OS.1d	0.14	1.00	0.70	9.24	10.0	0.9
B-OS.2	1.44	1.00	0.70	9.24	10.0	9.3
C-1	0.95	1.00	0.66	7.91	15.0	5.0
C-2	1.19	1.00	0.66	7.91	15.0	6.2
C-3	0.03	1.00	0.66	7.91	15.0	0.2
C-OS.1	0.11	1.00	0.60	7.91	15.0	0.5
C-OS.2	0.32	1.00	0.60	9.24	10.0	1.8
D-OS.1	0.14	1.00	0.30	7.91	15.0	0.3
ROW-A.1a	0.35	1.00	0.60	9.24	10.0	2.0
ROW-A.1b	0.34	1.00	0.60	9.24	10.0	1.9
ROW-A.2	0.06	1.00	0.60	9.24	10.0	0.4
ROW-A.3	0.03	1.00	0.60	9.24	10.0	0.2


WEIGHTED RUNOFF COEFFICIENT CALC			
AREA	SQ. FEET	ACRES	RUNOFF (C)
BASIN A	479,160	11.00	-
BUILDING	150,908	3.46	1
PAVEMENT	98,442	2.26	1
PERVIOUS	229,810	7.54	0.3
C		0.66	

POINT OF INTEREST	CUMULATIVE AREAS (ACRES)	CUMULATIVE C/A	TOTAL TIME OF CONCENTRATION	I ₁₀₀	Q _{HILLSTONE}	Q ₁₀₀
DESIGN POINT A	17.39	5.90	16.7	7.55	N/A	87.02
DESIGN POINT B	18.64	11.34	16.7	7.55	83.9	91.30
DESIGN POINT C	26.00	16.87	16.8	7.53	122	127.11

*TC BASED ON ROUTED FLOW TIME THROUGH STORM NETWORK

XASBLT-2

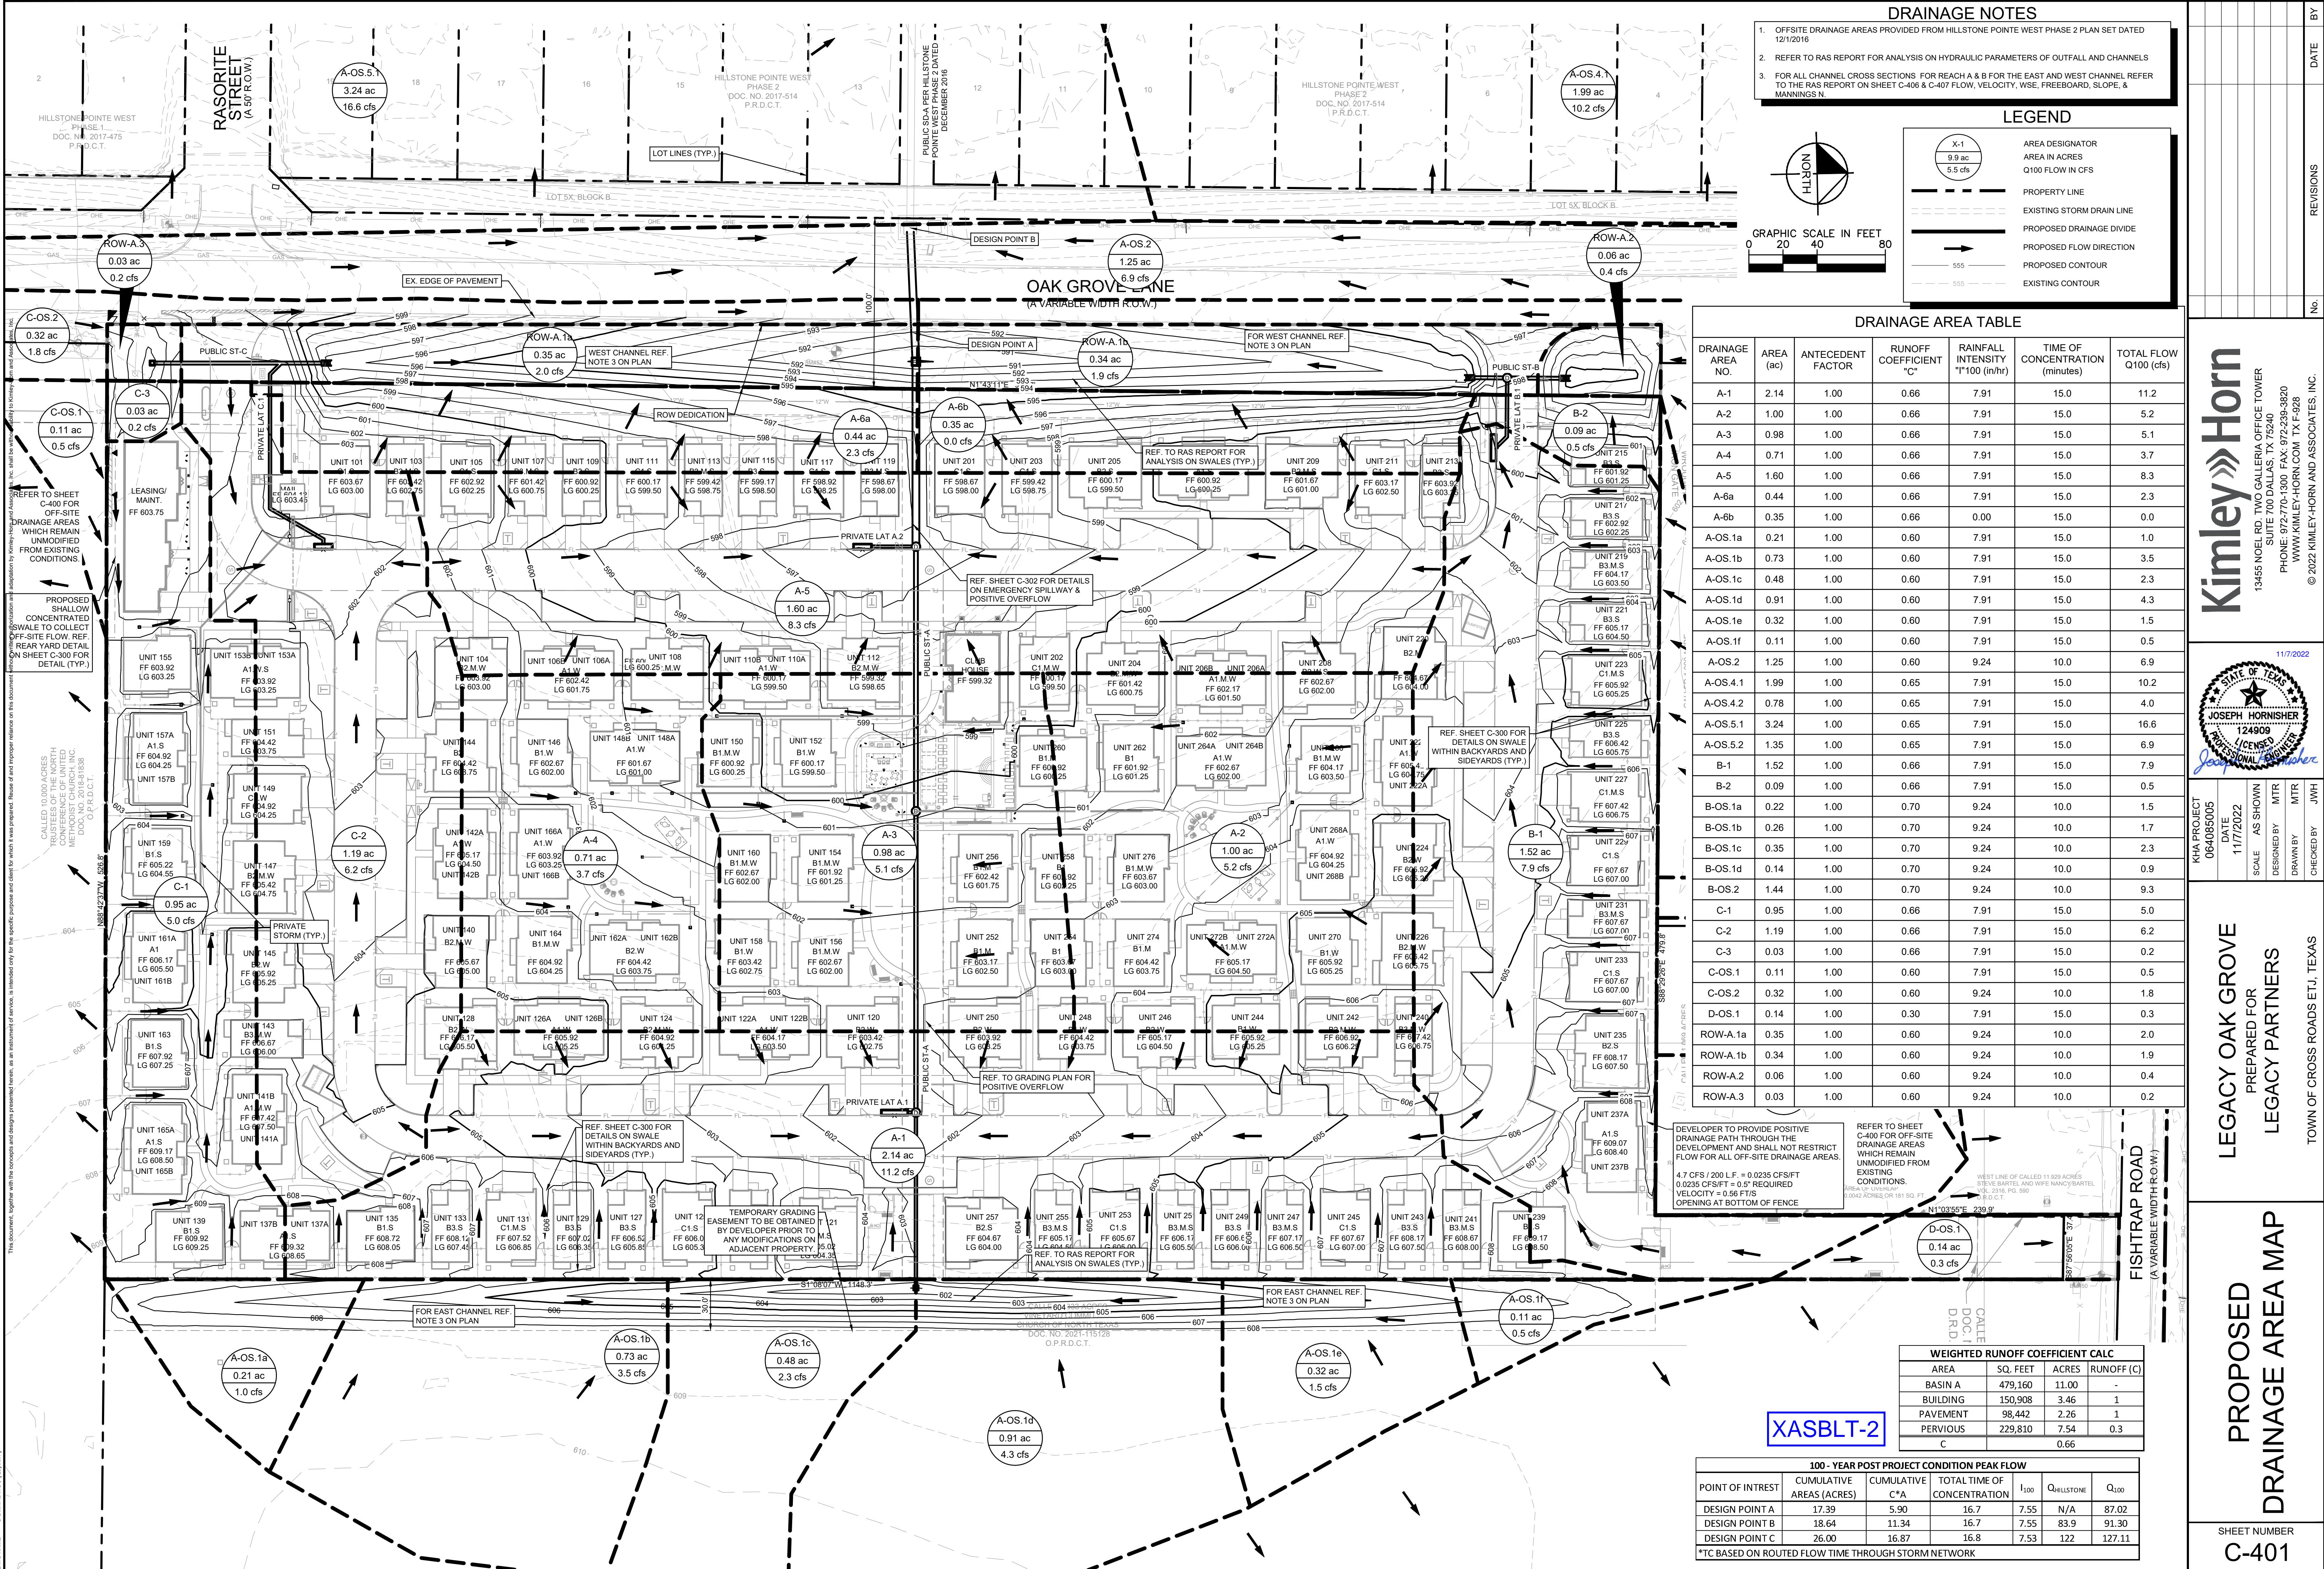

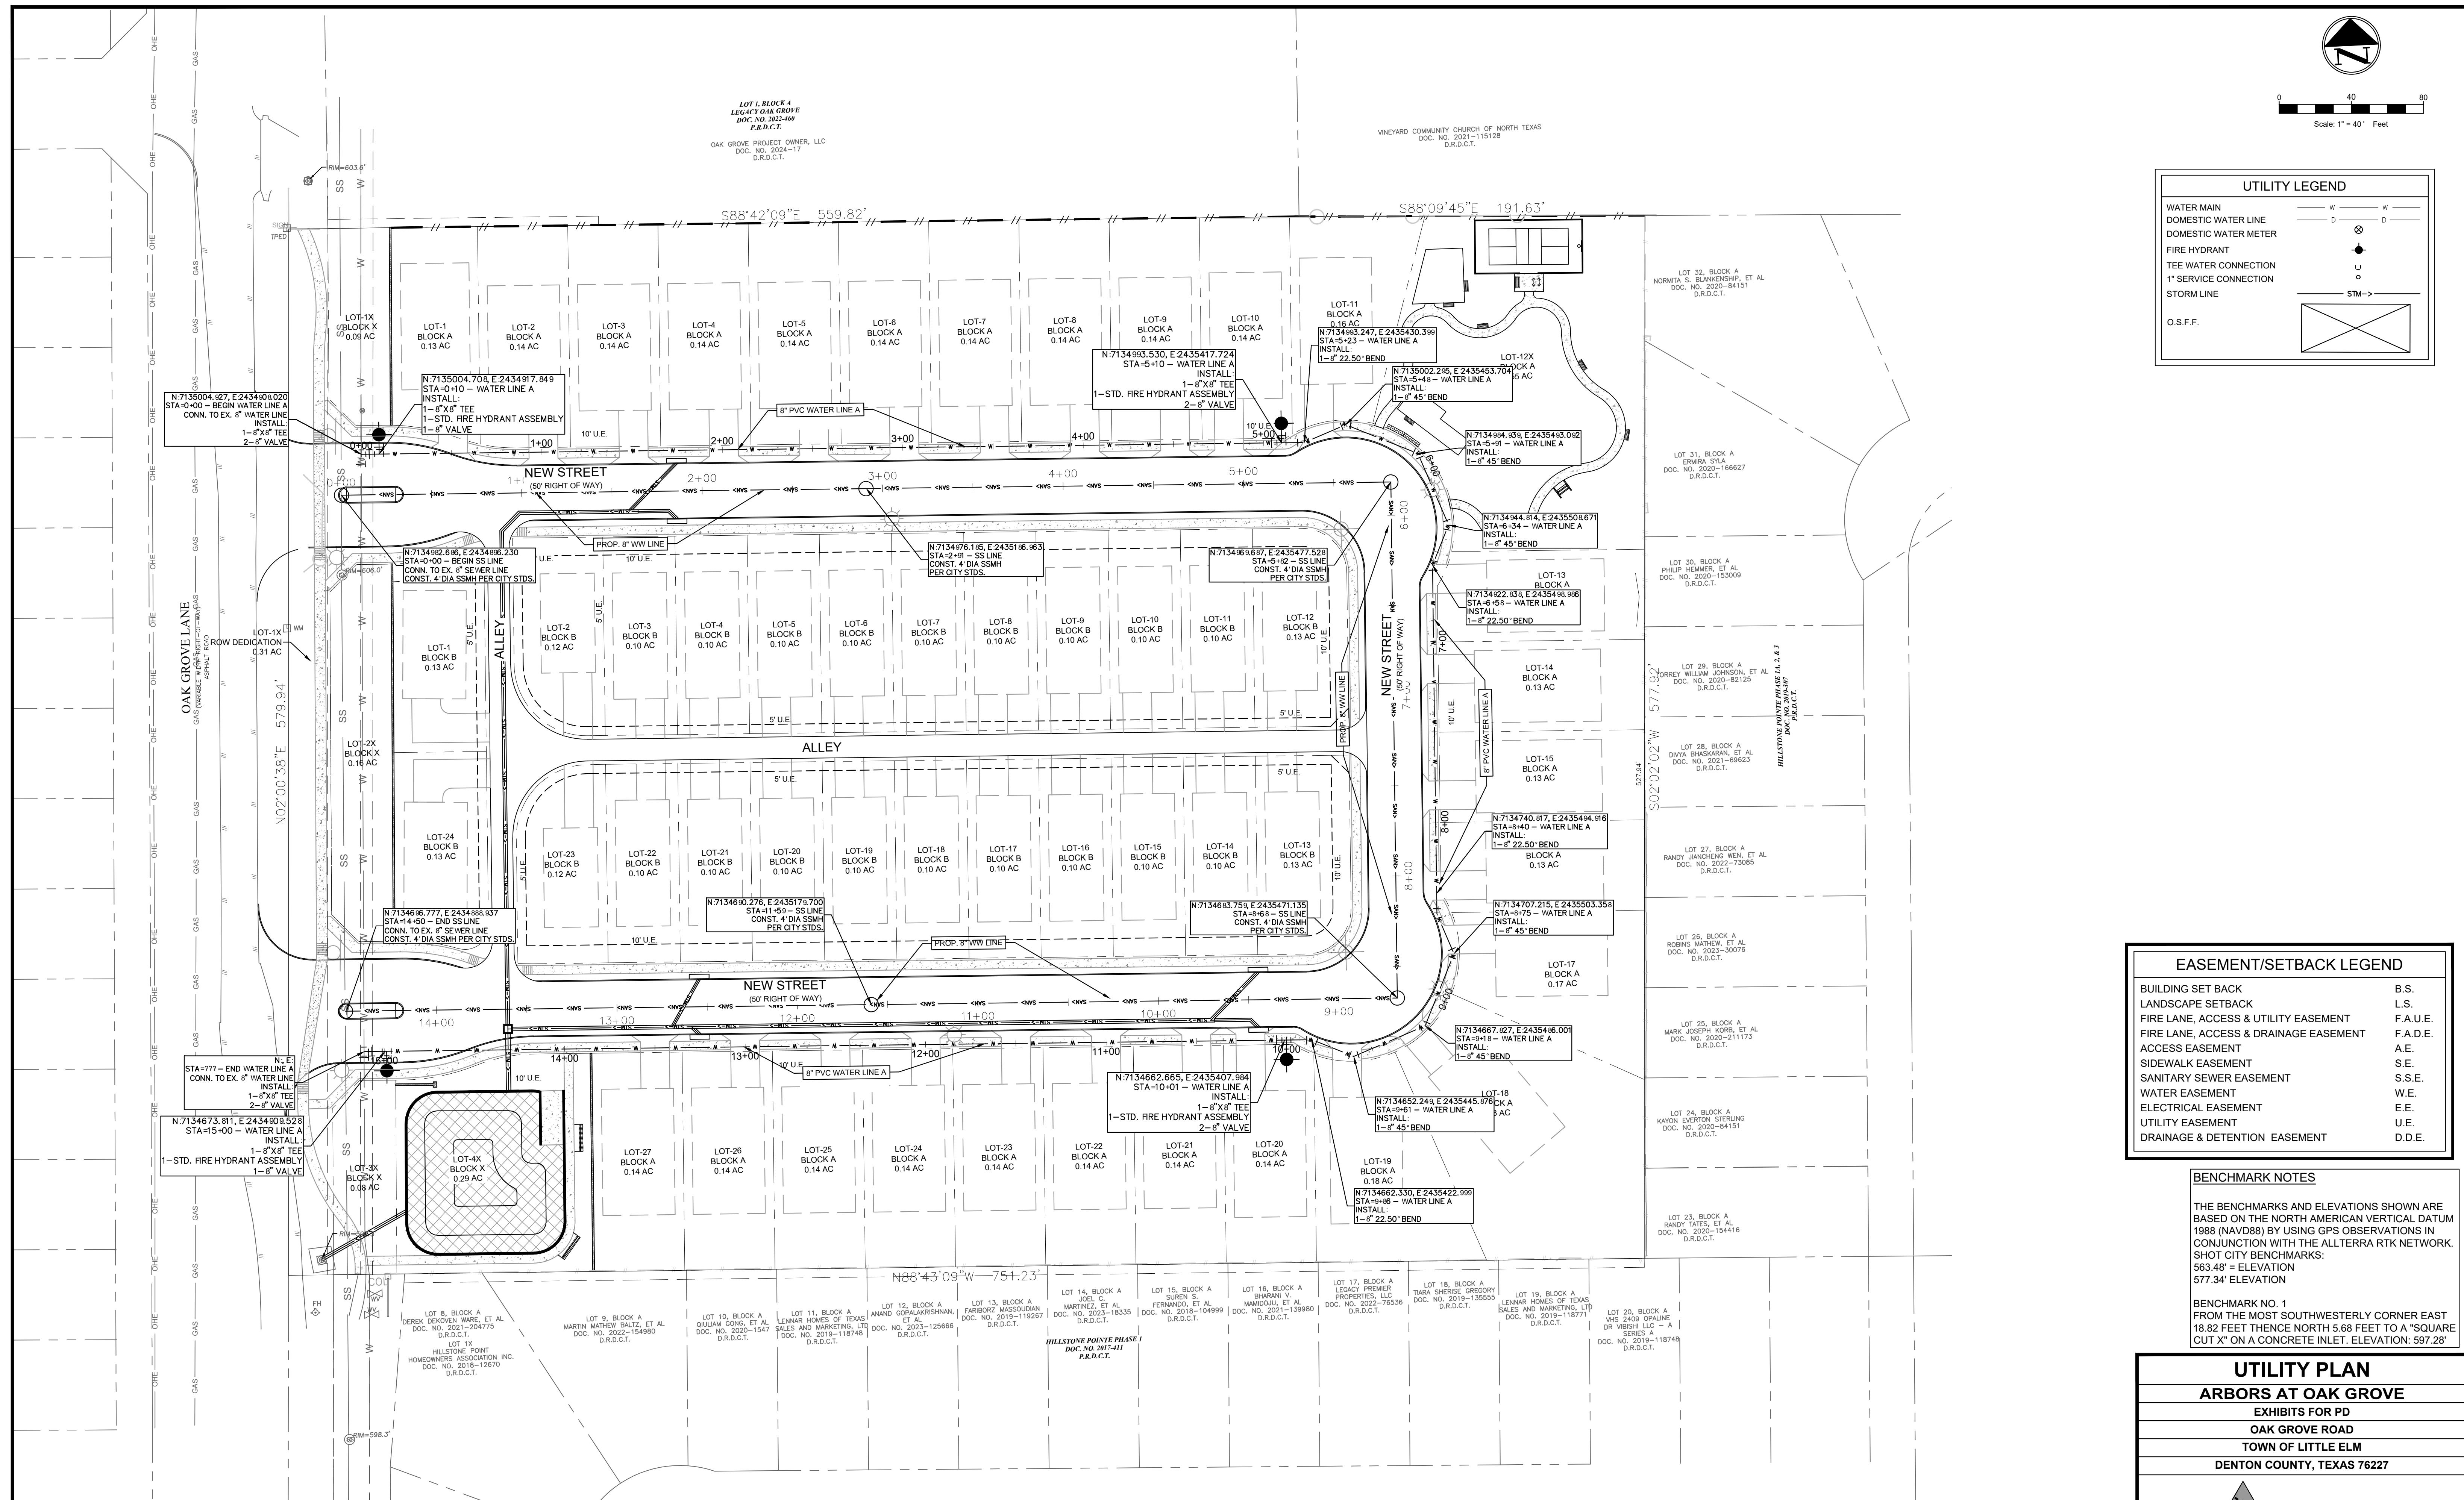

FLOOD NOTES:


NO PORTION OF THE SUBJECT PROPERTY SHOWN HEREON LIES WITHIN THE 100 YEAR FLOOD HAZARD AREA ACCORDING TO THE FLOOD INSURANCE RATE MAP, COMMUNITY PANEL NO. 48121C0405G, DATED APRIL 18, 2011. THE SUBJECT PROPERTY IS LOCATED IN THE AREA DESIGNATED AS ZONE "X", (AREAS DETERMINED TO BE OUTSIDE THE 0.2% ANNUAL CHANCE FLOOD PLAIN).

CAUTION- CONTRACTOR'S NOTE

THE CONTRACTOR SHALL LOCATE THE VERTICAL AND HORIZONTAL LOCATIONS OF ALL EXISTING UTILITIES IN THE AREA OF CONSTRUCTION. THE LOCATION OF EXISTING UTILITIES ARE SHOWN BASED ON BEST AVAILABLE INFORMATION AND SHALL NOT BE TAKEN AS EXACT OR COMPLETE. THE CONTRACTOR SHALL NOTIFY THE APPLICABLE UTILITY COMPANY AT LEAST 48 HOURS PRIOR TO BEGINNING EXCAVATION NEAR THEIR FACILITY.



NO.	DATE	DESCRIPTION	BY
1	08/05/24	1st ZONNING PD SUBMITTAL	KP
2	09/03/24	2ND ZONING PD SUBMITTAL	KP
3	12/19/24	3RD ZONING PD SUBMITTAL	KP
4	01/15/25	4TH ZONING PD SUBMITTAL	KP
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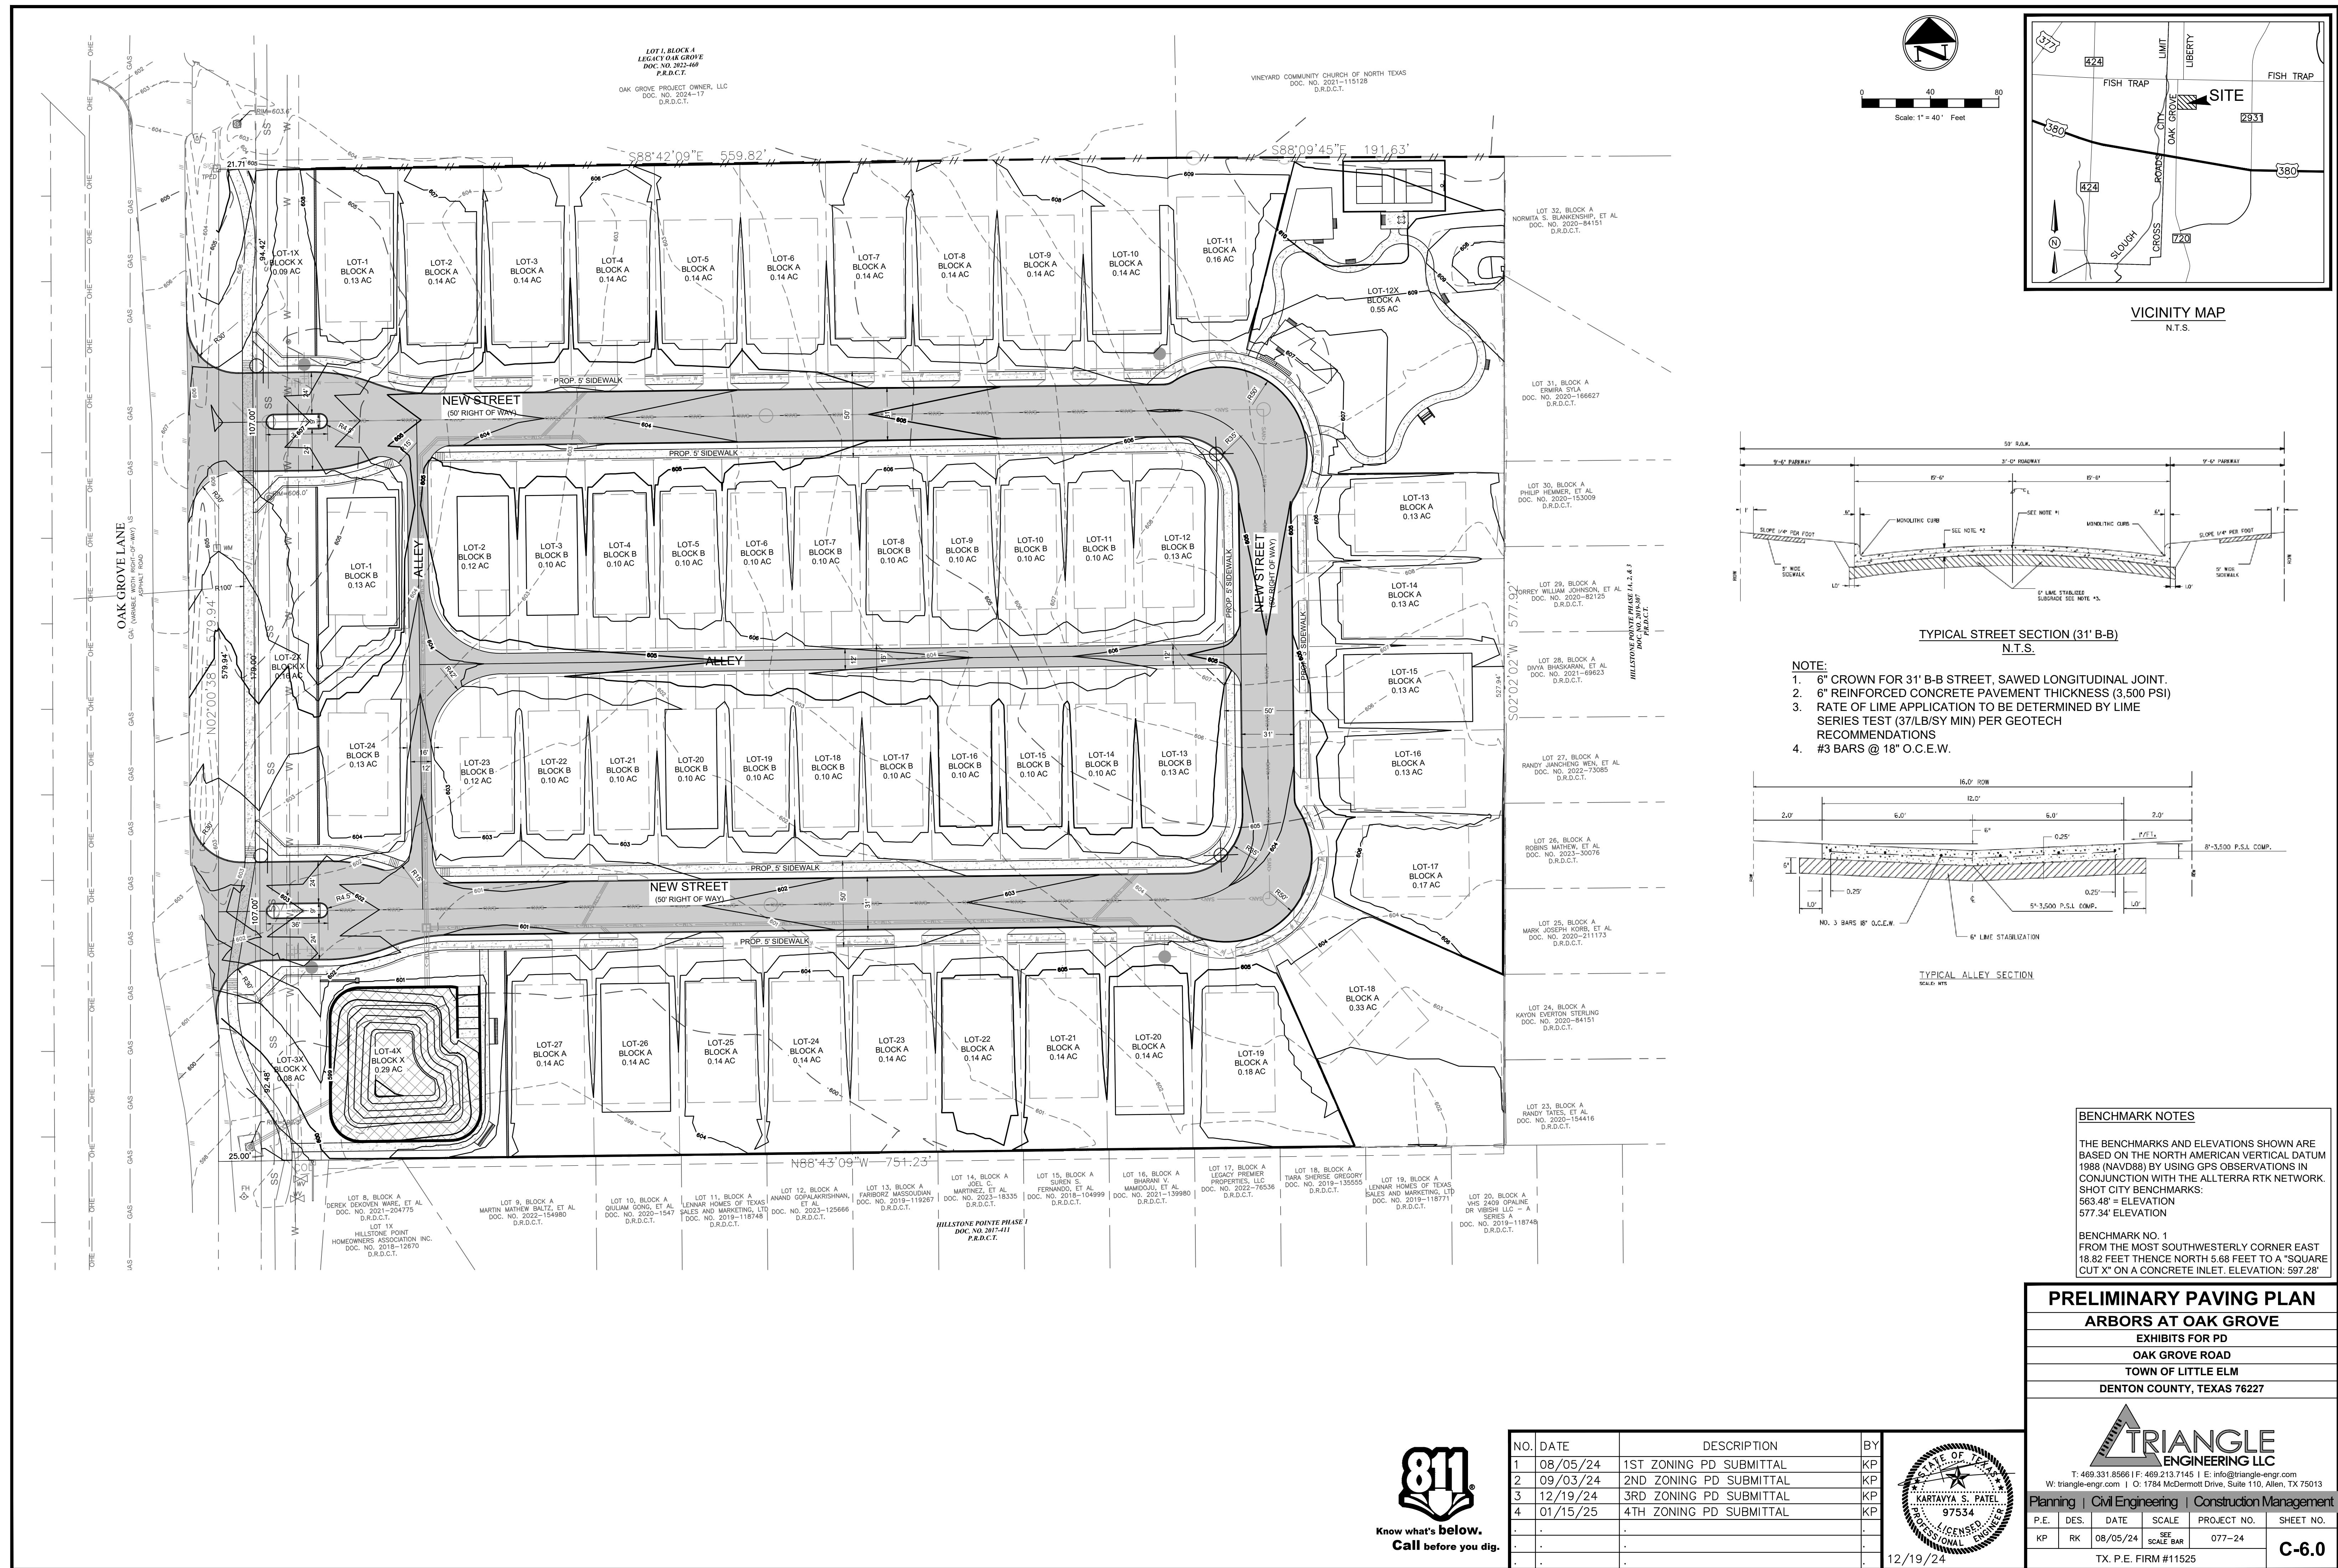



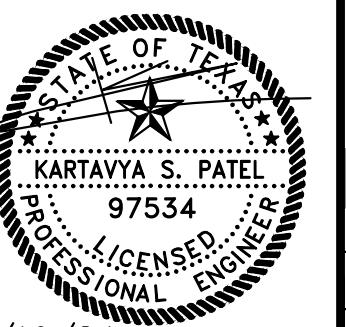
**UTILITY PLAN
ARBORS AT OAK GROVE
EXHIBITS FOR PD
OAK GROVE ROAD
TOWN OF LITTLE ELM
DENTON COUNTY, TEXAS 76227**

BENCHMARK NOTES

EASEMENT/SETBACK LEGEND	
BUILDING SET BACK	B.S.
LANDSCAPE SETBACK	L.S.
RE LANE, ACCESS & UTILITY EASEMENT	F.A.U
RE LANE, ACCESS & DRAINAGE EASEMENT	F.A.D
ACCESS EASEMENT	A.E.
DEWALK EASEMENT	S.E.
ANITARY SEWER EASEMENT	S.S.E
ATER EASEMENT	W.E.
ELECTRICAL EASEMENT	E.E.
ILITY EASEMENT	U.E.
RAINAGE & DETENTION EASEMENT	D.D.E

Scale: 1" = 40' Feet



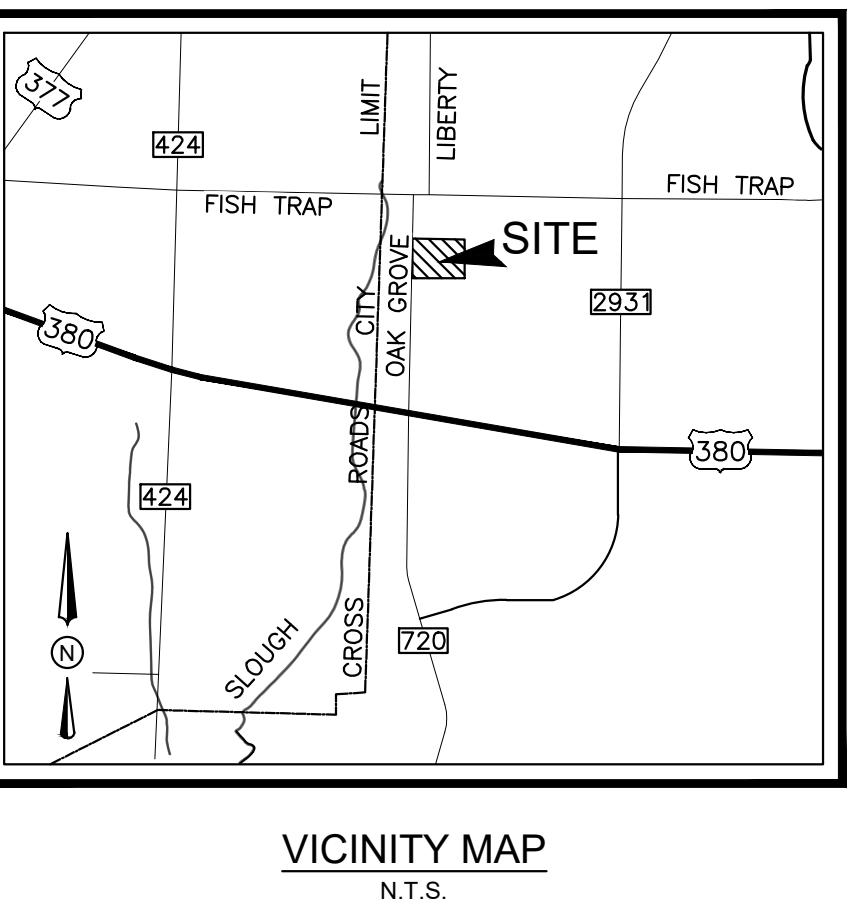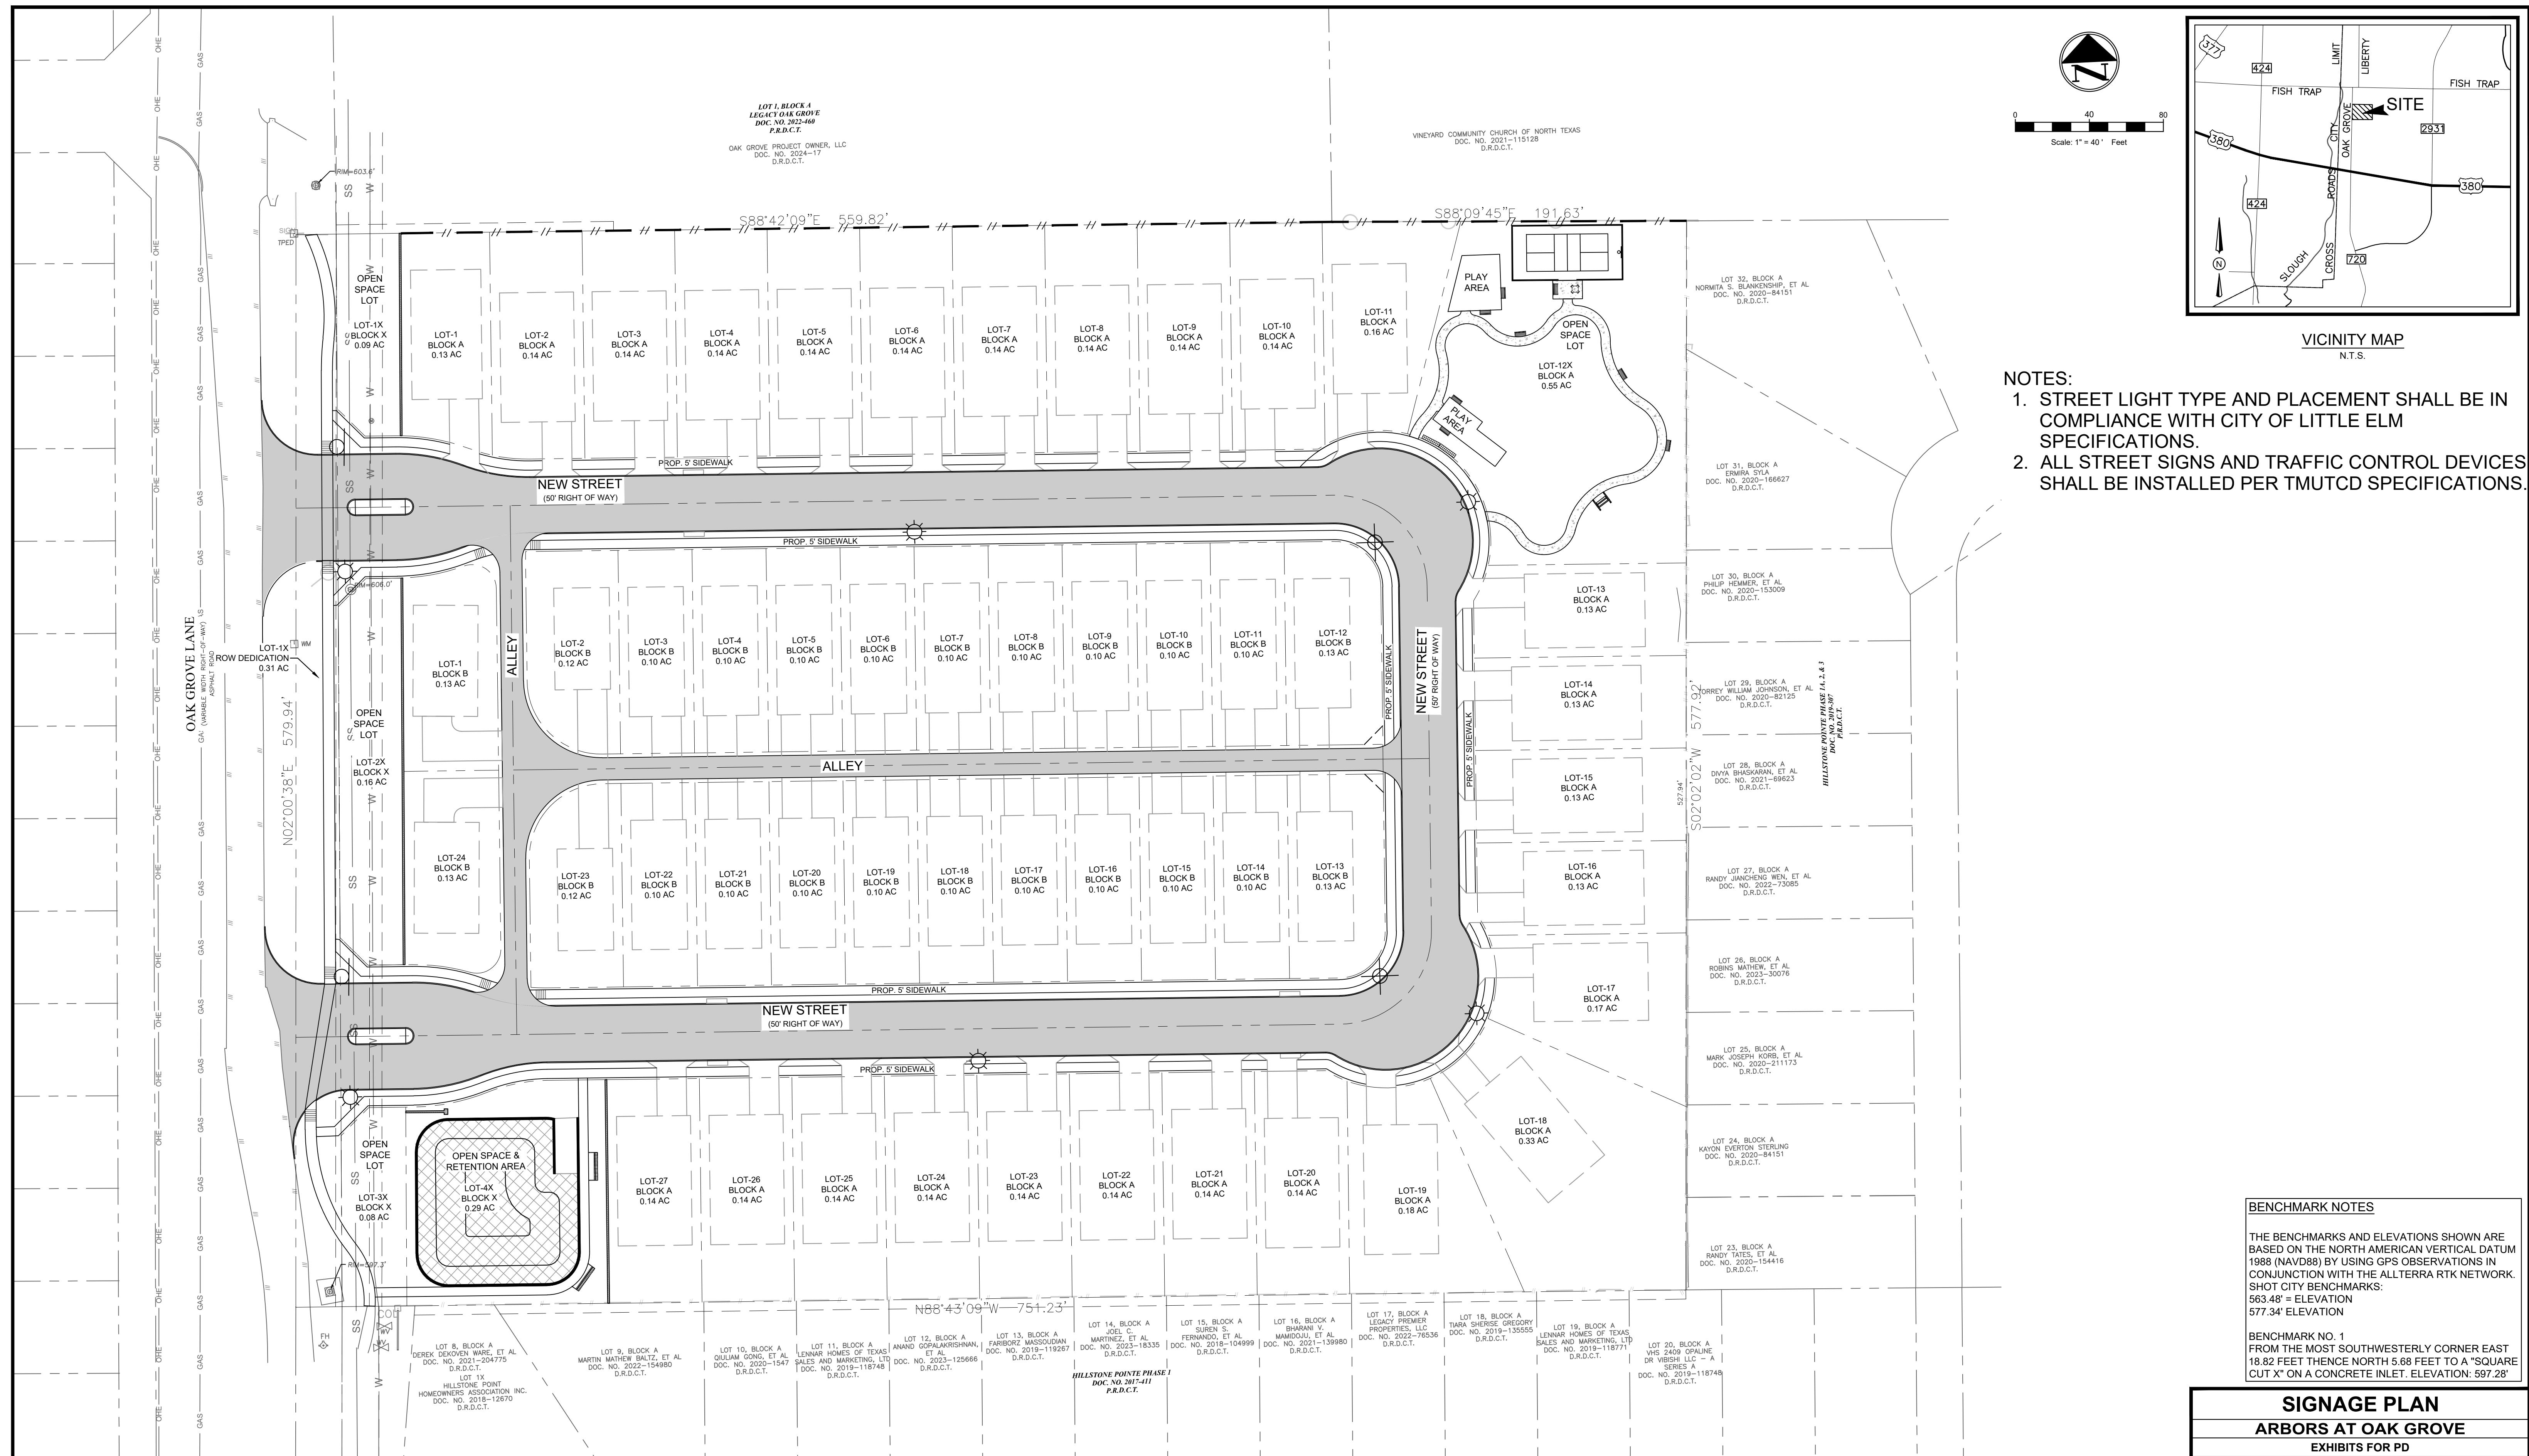

BENCHMARK NOTES


THE BENCHMARKS AND ELEVATIONS SHOWN ARE BASED ON THE NORTH AMERICAN VERTICAL DATUM 1988 (NAVD88) BY USING GPS OBSERVATIONS IN CONJUNCTION WITH THE ALLTERRA RTK NETWORK. SHOT CITY BENCHMARKS:
563.48' = ELEVATION
577.34' = ELEVATION

BENCHMARK NO. 1
FROM THE MOST SOUTHWESTERLY CORNER EAST
18.82 FEET THENCE NORTH 5.68 FEET TO A "SQUARE CUT X" ON A CONCRETE INLET. ELEVATION: 597.28'

SIGNAGE PLAN

ARBORS AT OAK GROVE

EXHIBITS FOR PD
OAK GROVE ROAD
TOWN OF LITTLE ELM
DENTON COUNTY, TEXAS 76227

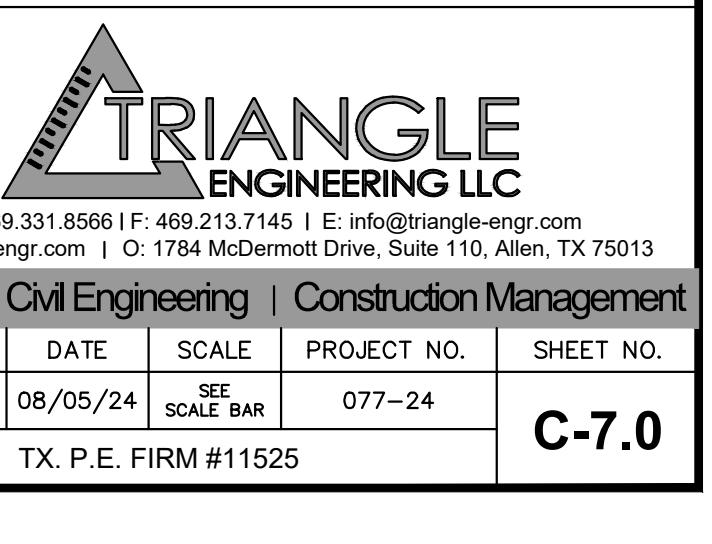

INSTALL: STREET NAME BLADES ONLY

INSTALL: STOP SIGN WITH STREET NAME BLADES
(UNLESS NOTED OTHERWISE)

STREET LIGHT

CAUTION- CONTRACTOR'S NOTE

THE CONTRACTOR SHALL LOCATE THE VERTICAL AND HORIZONTAL LOCATIONS OF ALL EXISTING UTILITIES IN THE AREA OF CONSTRUCTION. THE LOCATION OF EXISTING UTILITIES ARE SHOWN BASED ON BEST AVAILABLE INFORMATION AND SHALL NOT BE TAKEN AS EXACT OR COMPLETE. THE CONTRACTOR SHALL NOTIFY THE APPLICABLE UTILITY COMPANY AT LEAST 48 HOURS PRIOR TO BEGINNING EXCAVATION NEAR THEIR FACILITY.



NO.	DATE	DESCRIPTION	BY
1	08/05/24	1st ZONNING PD SUBMITTAL	KP
2	09/03/24	2ND ZONING PD SUBMITTAL	KP
3	12/19/24	3RD ZONING PD SUBMITTAL	KP
4	01/15/25	4TH ZONING PD SUBMITTAL	KP
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01/15/25


TX. P.E. FIRM #11525

C-7.0



RESIDENTIAL DEVELOPMENT

OAK GROVE LANE LITTLE ELM, TEXAS

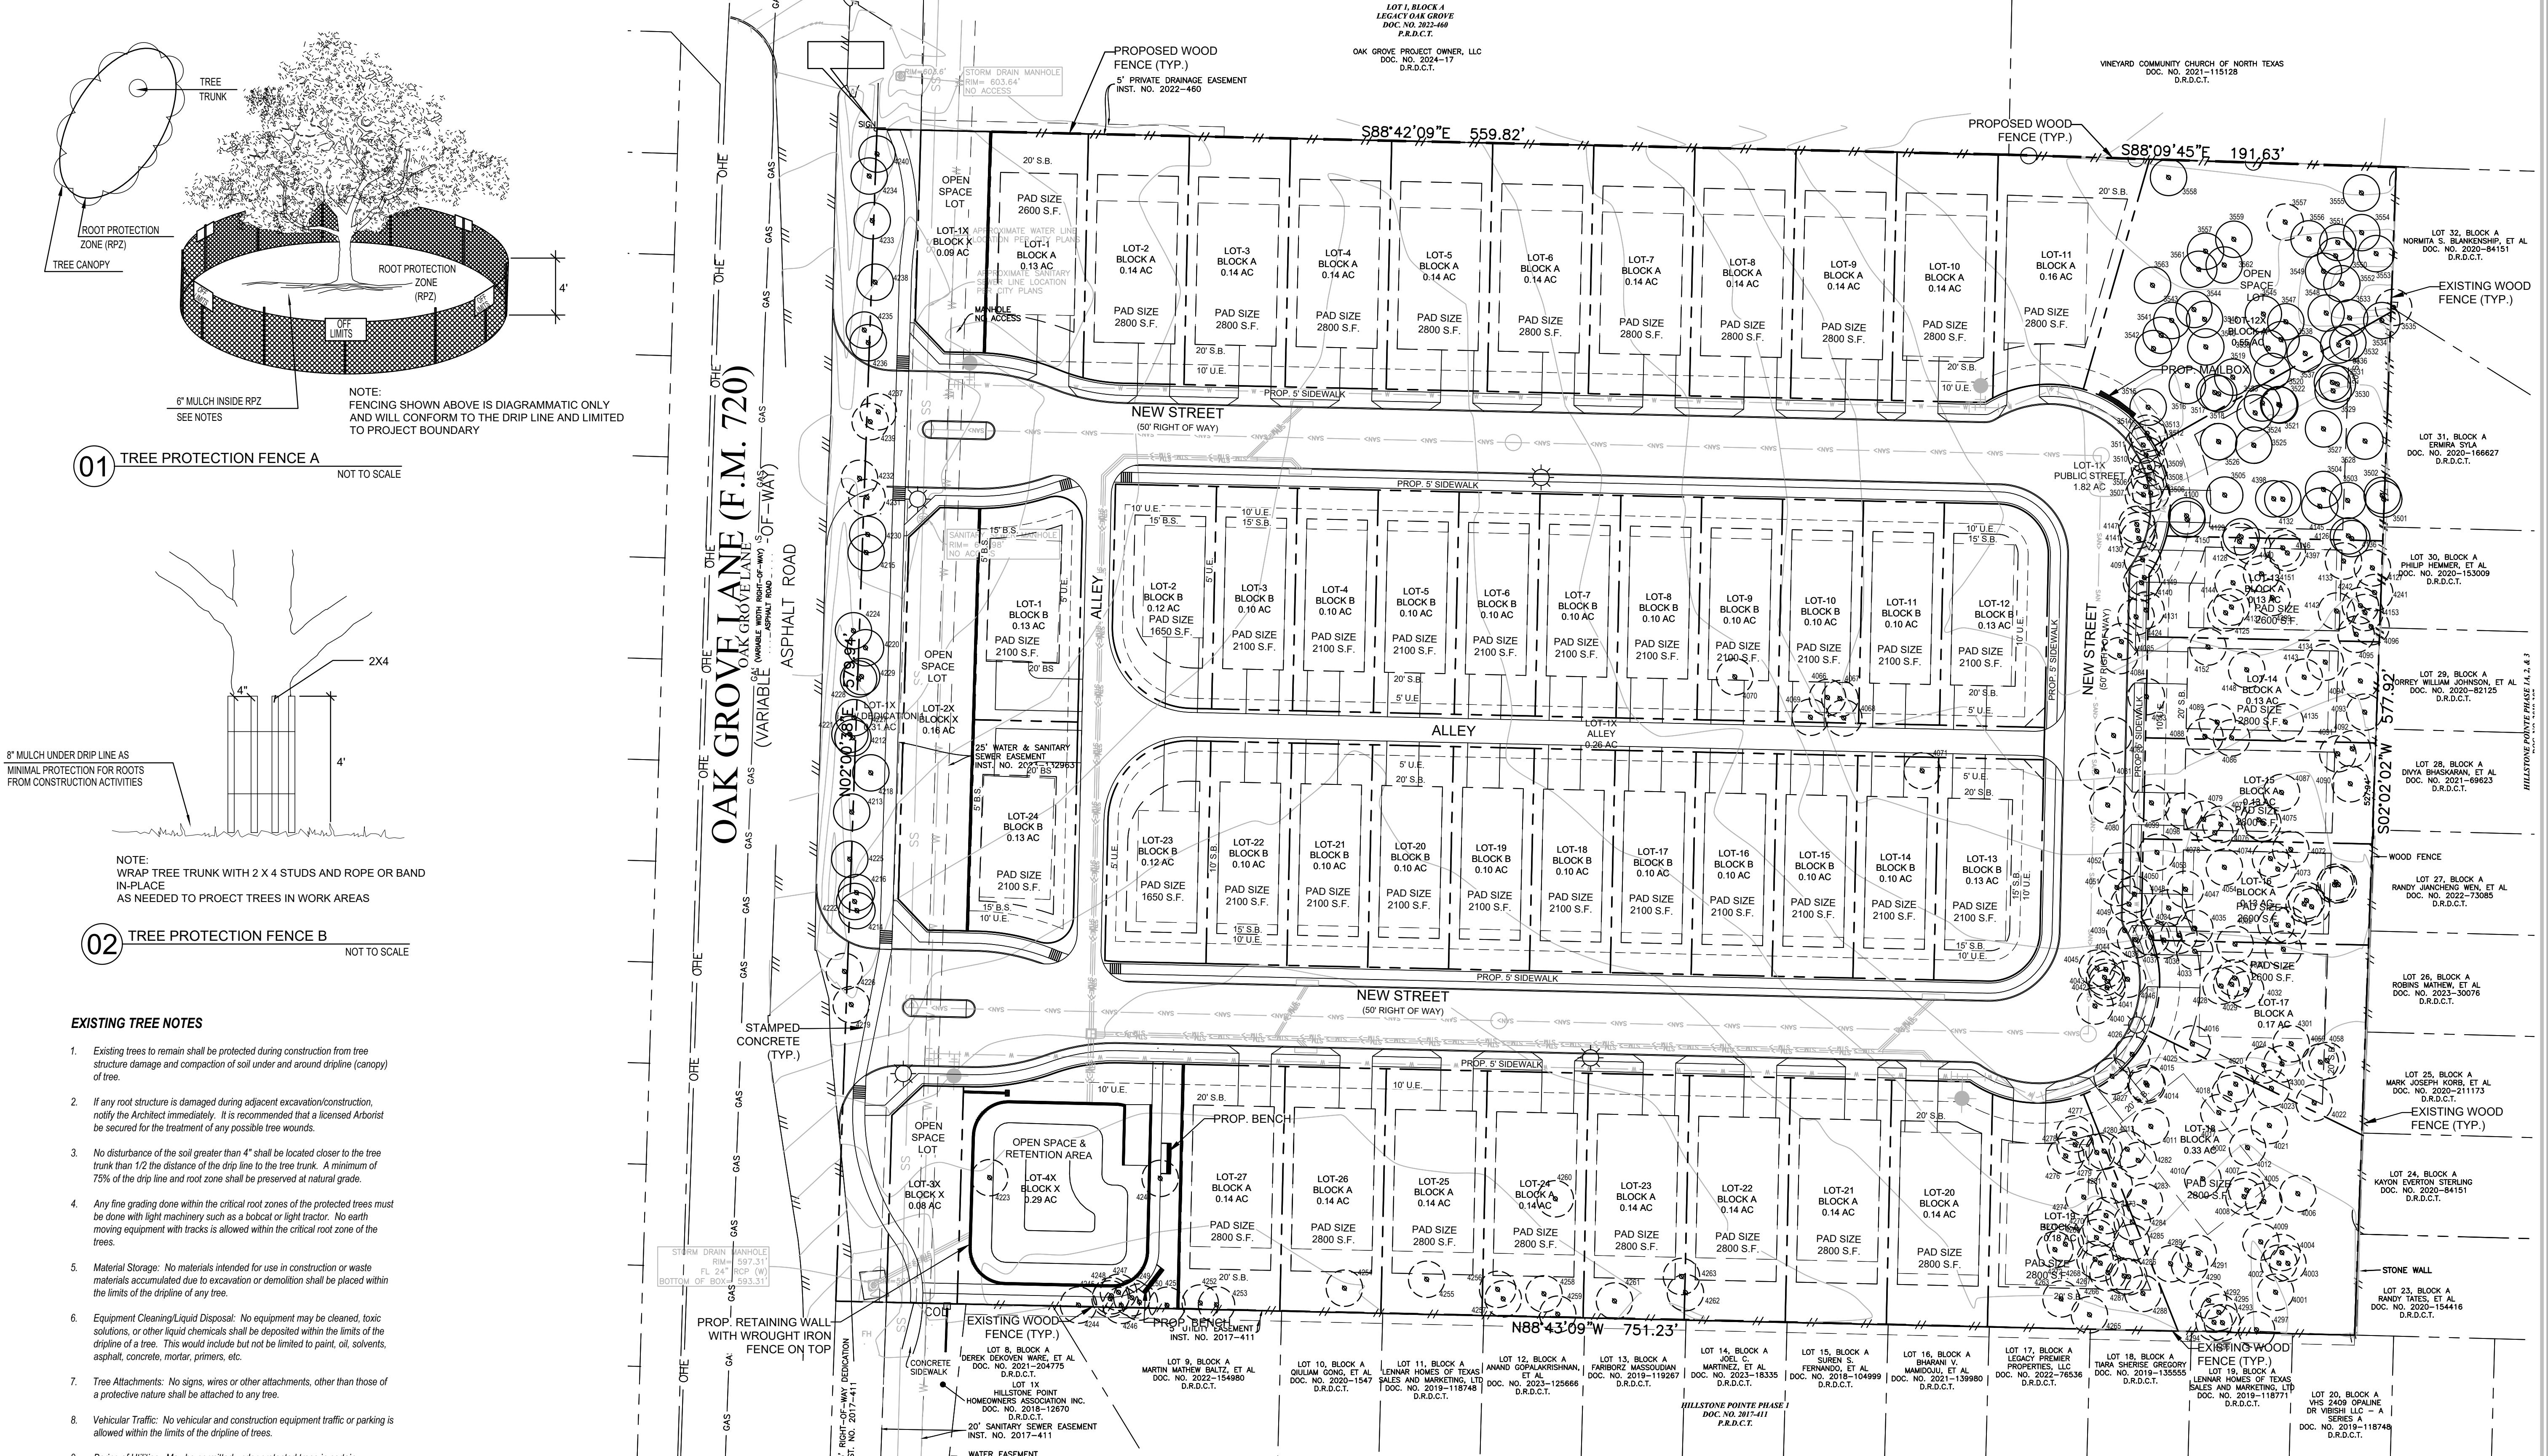

EXISTING TREE LEGEND

- EXISTING TREE TO REMAIN
- EXISTING TREE TO BE REMOVED
- TREE PROTECTION FENCING TO REMAIN DURING CONSTRUCTION REFER TO 01/L1.00

ISSUE:
FOR APPROVAL 08.05.2024
CITY COMMENTS 09.03.2024
CITY COMMENTS 09.23.2024
CITY COMMENTS 10.30.2024
CITY COMMENTS 12.13.2024

DATE:
12.13.2024

SHEET NAME:
EXISTING TREE PLAN

SHEET NUMBER:

L.1

RESIDENTIAL DEVELOPMENT

OAK GROVE LANE

LITTLE ELM, TEXAS

ISSUE:

FOR APPROVAL 08.05.2024
CITY COMMENTS 09.03.2024
CITY COMMENTS 09.23.2024
CITY COMMENTS 10.30.2024
CITY COMMENTS 12.13.2024
CITY COMMENTS 01.27.2025

DATE:

01.27.2025

SHEET NAME:

EXISTING TREE PLAN

SHEET NUMBER:

L.2






Tree Removal Worksheet																							
Tree ID No.	Species	Class	Caliper Size ↗	Mitigation Inches	Mitigation Fee	Status	Val of Remaining Tree	Tree ID No.	Species	Class	Caliper Size ↗	Mitigation Inches	Mitigation Fee	Status	Val of Remaining Tree	Tree ID No.	Species	Class	Caliper Size ↗	Mitigation Inches	Mitigation Fee	Status	Val of Remaining Tree
3501		1	7			Remain \$	846.66	4039		1	6	30 \$	622.04			4223		1	25	125 \$	10,799.22		
3502		1	6			Remain \$		4040		1	16	80 \$	4,423.36			4224		2	15			Remain \$	3,110.18
3503		1	7			Remain \$	846.66	4041		1	10	50 \$	1,727.88			4225		1	15			Remain \$	3,887.72
3504		1	7			Remain \$	846.66	4042		1	10	50 \$	1,727.88			4226		1	18	90 \$	5,598.32		
3505		1	6			Remain \$		4043		1	10	50 \$	1,727.88			4227		1	20			Remain \$	6,911.50
3506		1	8	40 \$	1,105.84			4044		1	7	35 \$	846.66			4228		1	30			Remain \$	15,550.88
3507		1	11	55 \$	2,090.73			4045		1	9	45 \$	1,399.58			4229		2	8			Remain \$	884.67
3508		1	7	35 \$	846.66			4046		2	10	40 \$	1,382.30			4230		1	12			Remain \$	2,488.14
3509		1	6	30 \$	622.04			4047		1	7	35 \$	846.66			4231		1	16	80 \$	4,423.36		
3510		1	6	30 \$	622.04			4048		1	7	35 \$	846.66			4232		1	19	95 \$	6,237.63		
3511		2	10	40 \$	1,382.30			4049		2	6	24 \$	497.63			4233		1	40			Remain \$	27,646.02
3512		1	12	60 \$	2,488.14			4050		2	6	24 \$	497.63			4234		1	22			Remain \$	8,362.92
3513		1	8	40 \$	1,105.84			4051		2	12	48 \$	1,990.51			4235		2	12			Remain \$	1,990.51
3514		1	8	40 \$	1,105.84			4052		1	26	130 \$	11,680.44			4236		1	28			Remain \$	13,546.55
3515		2	16			Remain \$	3,538.69	4053		2	8	32 \$	884.67			4237		1	14	70 \$	3,386.64		
3516		1	7			Remain \$	846.66	4054		2	8	32 \$	884.67			4238		1	30			Remain \$	15,550.88
3517		1	7			Remain \$	846.66	4055		2	8	32 \$	884.67			4239		1	19	95 \$	6,237.63		
3518		1	7			Remain \$	846.66	4056		2	8	32 \$	884.67			4240		1	36			Remain \$	22,393.27
3519		1	7			Remain \$	846.66	4057		1	20	100 \$	6,911.50			4241		2	6	24 \$	497.63		
3520		1	10			Remain \$	1,727.88	4058		1	14	70 \$	3,386.64			4242		2	6	24 \$	497.63		
3521		1	6			Remain \$		4059		1	8	40 \$	1,105.84			4243		1	36	180 \$	22,393.27		
3522		1	7			Remain \$	846.66	4060		1	6	30 \$	622.04			4244		2	6	24 \$	497.63		
3523		1	7			Remain \$	846.66	4061		1	9	45 \$	1,399.58			4245		2	18	72 \$	4,478.65		
3524		1	6			Remain \$		4062		2	9	36 \$	1,119.66			4246		2	6	24 \$	497.63		
3525		1	6			Remain \$	622.04	4063		1	10	50 \$	1,727.88			4247		2	10	40 \$	1,382.30		
3526		1	14			Remain \$	3,386.64	4064		2	10	40 \$	1,382.30			4248		2	6	24 \$	497.63		
3527		1	10			Remain \$	1,727.88	4065		1	7	35 \$	846.66			4249		1	16	80 \$	4,423.36		
3528		2	10			Remain \$	1,382.30	4066		3	6	18 \$	373.22			4250		2	6	24 \$	497.63		
3529		1	12			Remain \$	2,488.14	4067		3	6	18 \$	373.22			4251		2	12	48 \$	1,990.51		
3530		1	10			Remain \$	1,727.88	4068		3	24	72 \$	5,971.54			4252		1	10	50 \$	1,727.88		
3531		1	10			Remain \$	1,727.88	4069		1	32	160 \$	17,693.45			4253		2	18	72 \$	4,478.65		
3532		1	12			Remain \$	2,488.14	4070		1	48	240 \$	39,810.26			4254		4	7	14 \$	338.66		
3533		1	6			Remain \$		4071		3	15	45 \$	2,332.63			4255		2	6	24 \$	497.63		
3534		1	6			Remain \$	622.04	4072		1	8	40 \$	1,105.84			4256		2	6	24 \$	497.63		
3535		1	14			Remain \$	3,386.64	4073		2	8	32 \$	884.67			4257		2	6	24 \$	497.63		
3536		2	6			Remain \$	497.63	4074		2	10	40 \$	1,382.30			4258		2	6	24 \$	497.63		
3537		1	6			Remain \$		4075		2	6	24 \$	497.63			4259		2	6	24 \$	497.63		
3538		1	7			Remain \$	846.66	4076		2	7	28 \$	677.33			4260		1	32	160 \$	17,693.45		
3539		2	11			Remain \$	1,672.58	4077		1	14	70 \$	3,386.64			4261		2	7	28 \$	677.33		
3540		1	11			Remain \$		4078		1	6	30 \$	622.04			4262		2	10	40 \$	1,382.		

LANDSCAPE ARCHITECT
STUDIO GREEN SPOT, INC.
1782 W. McDERMOTT DR.
ALLEN, TEXAS 75013
(469) 369-4448
CHRIS@STUDIOPGREENSPOT.COM



RESIDENTIAL DEVELOPMENT

OAK GROVE LANE
LITTLE ELM, TEXAS

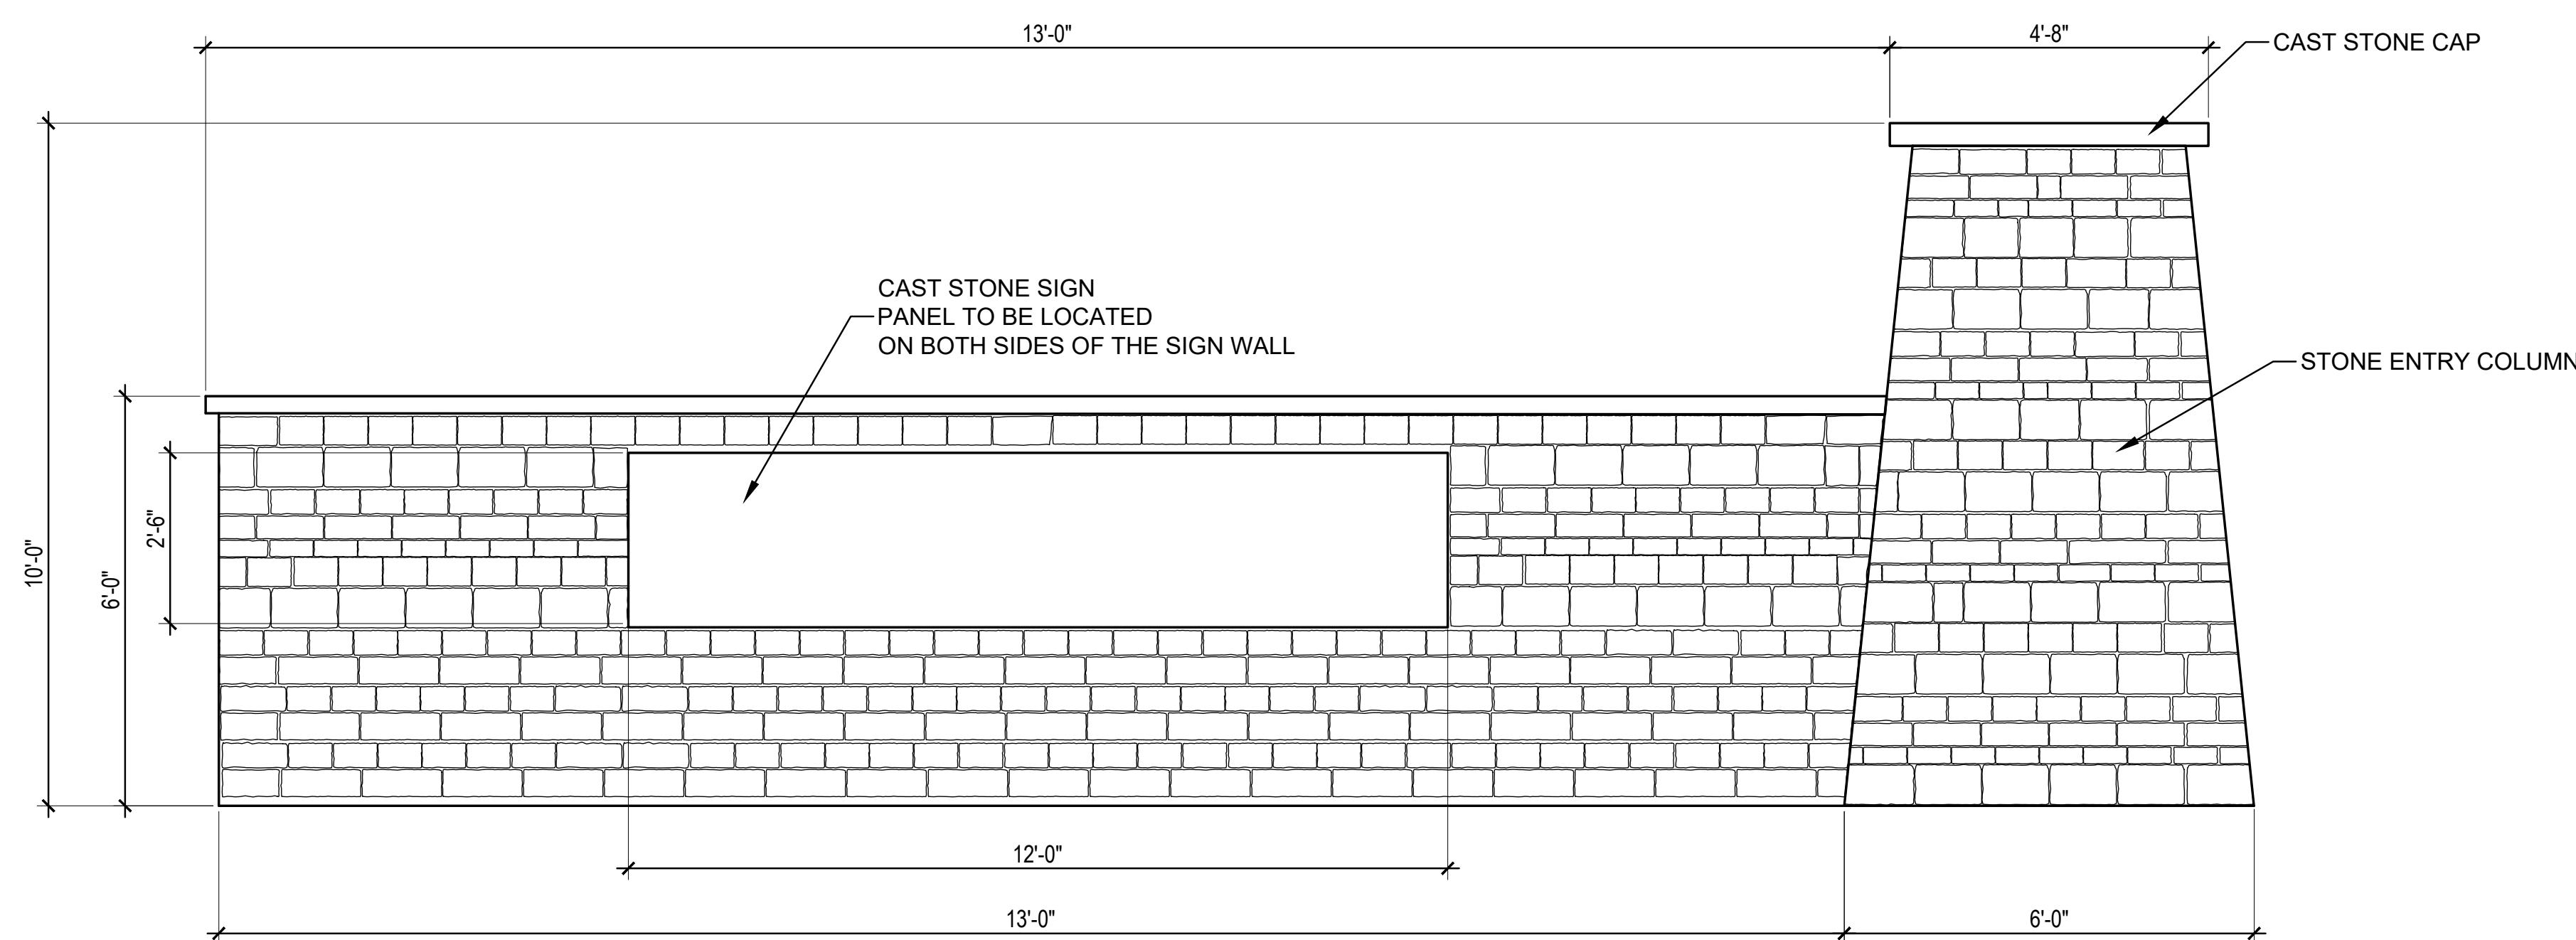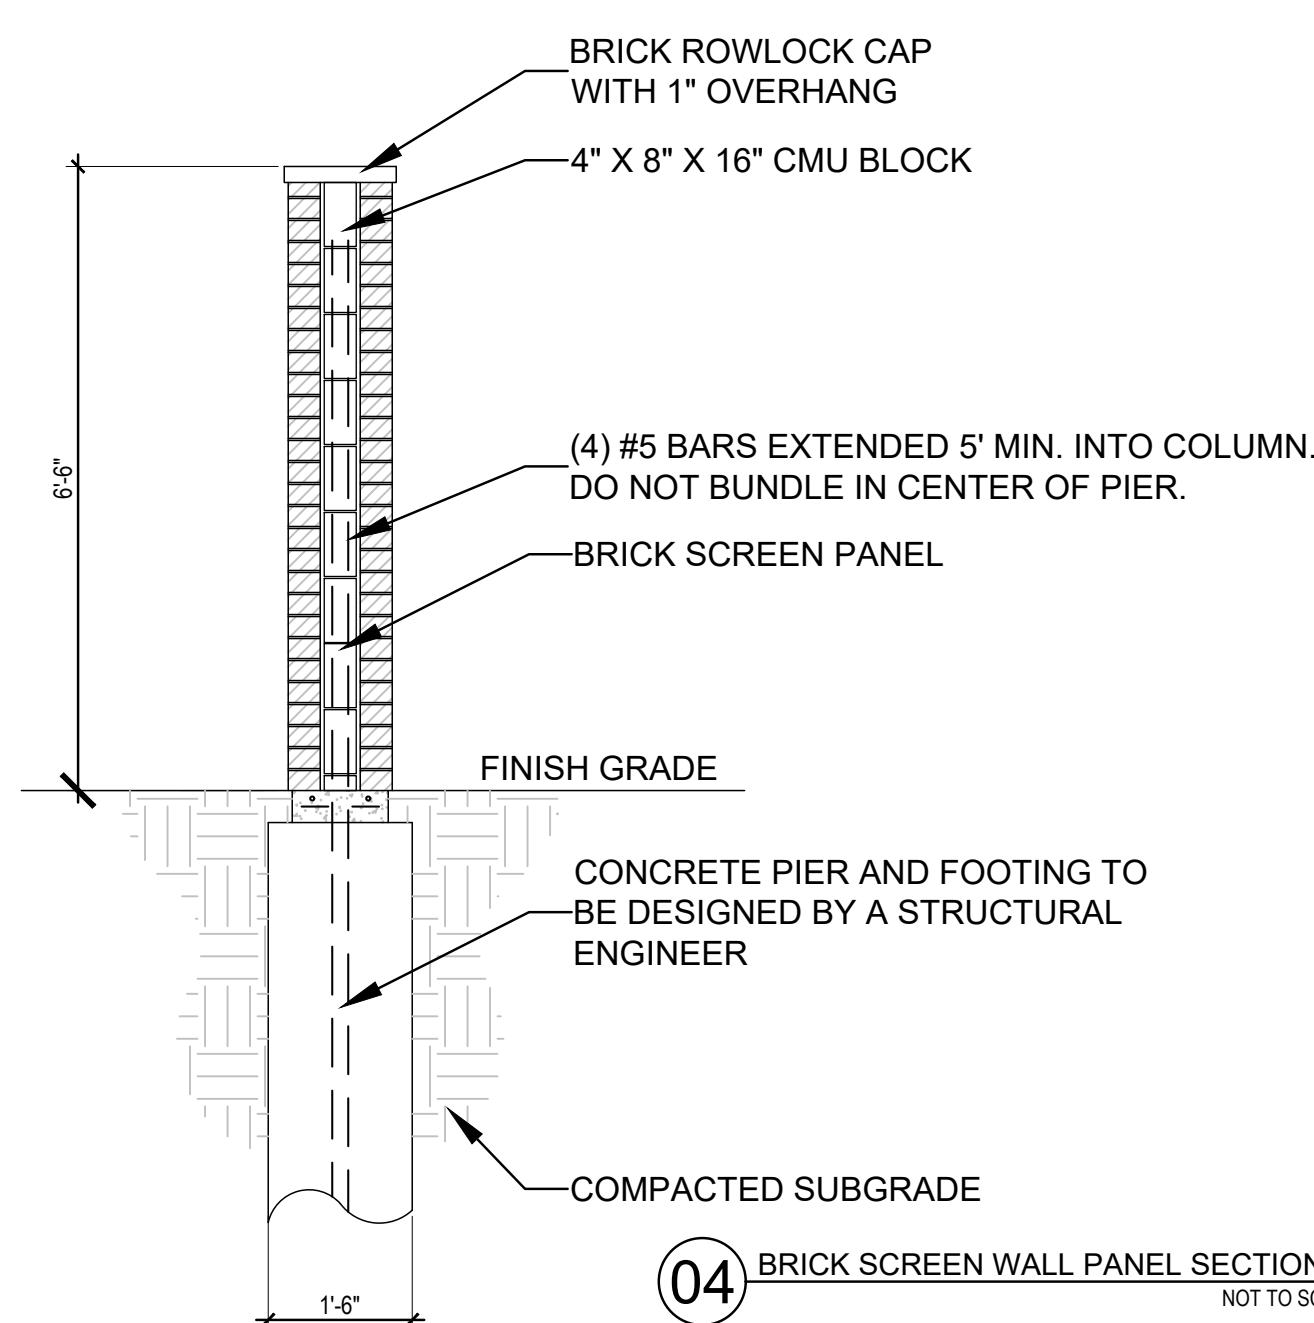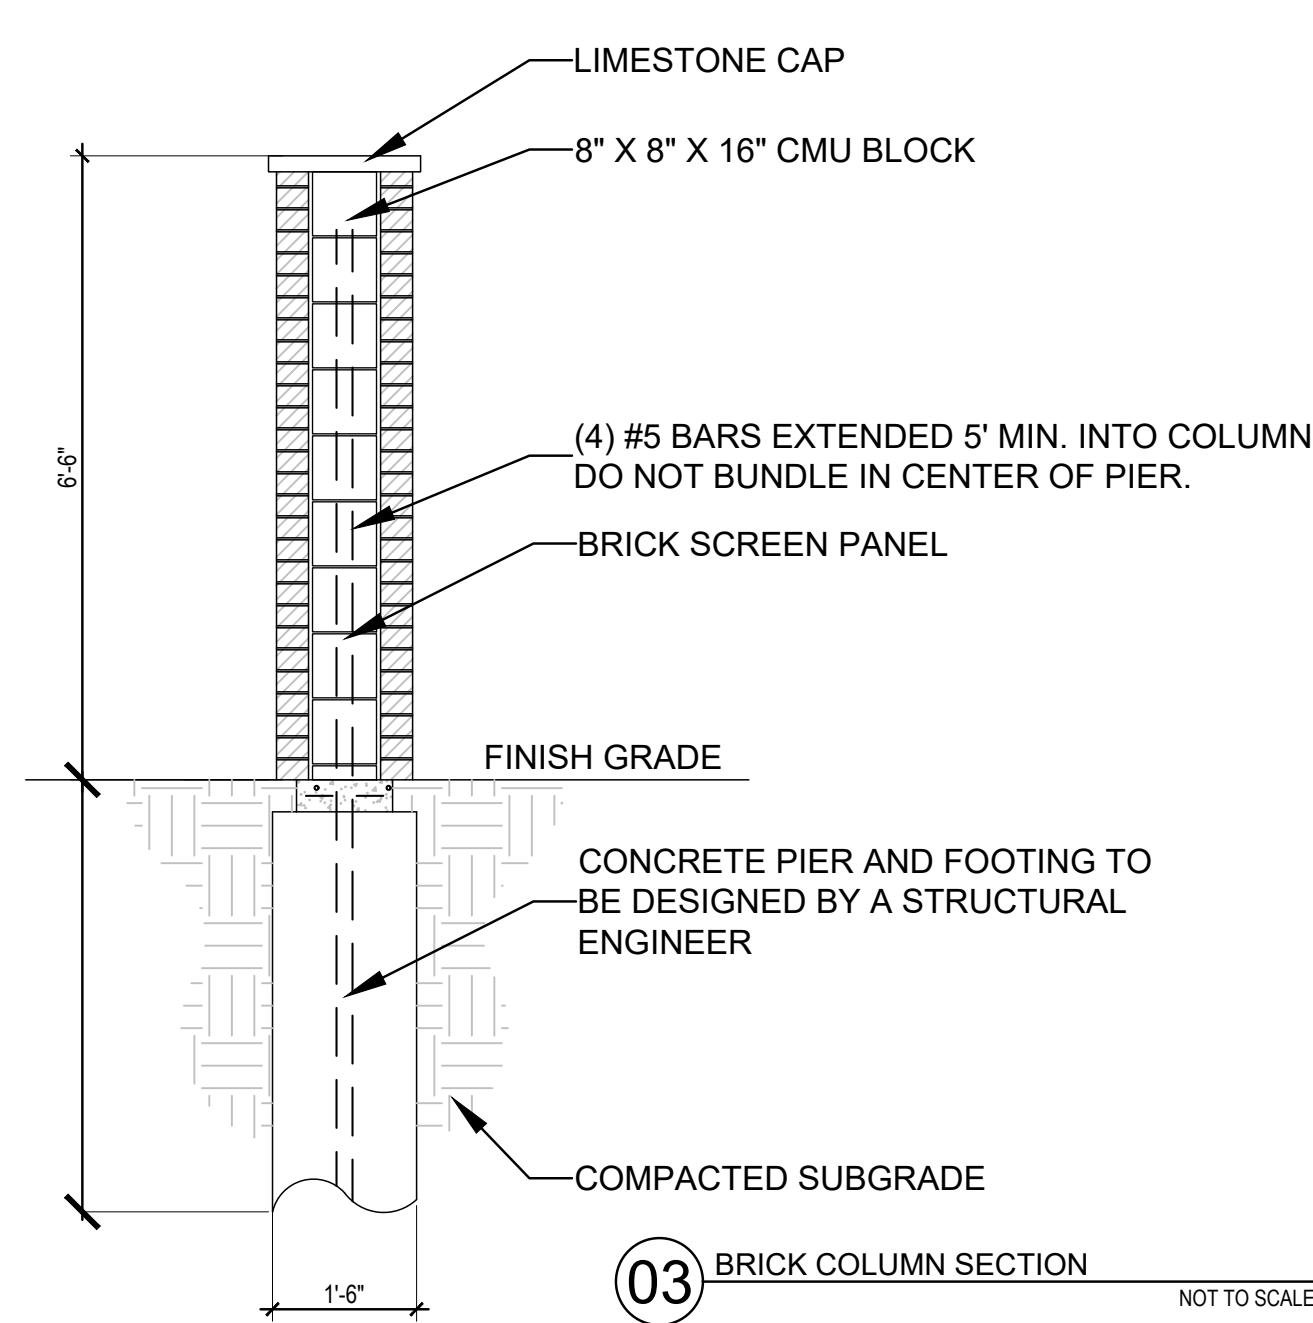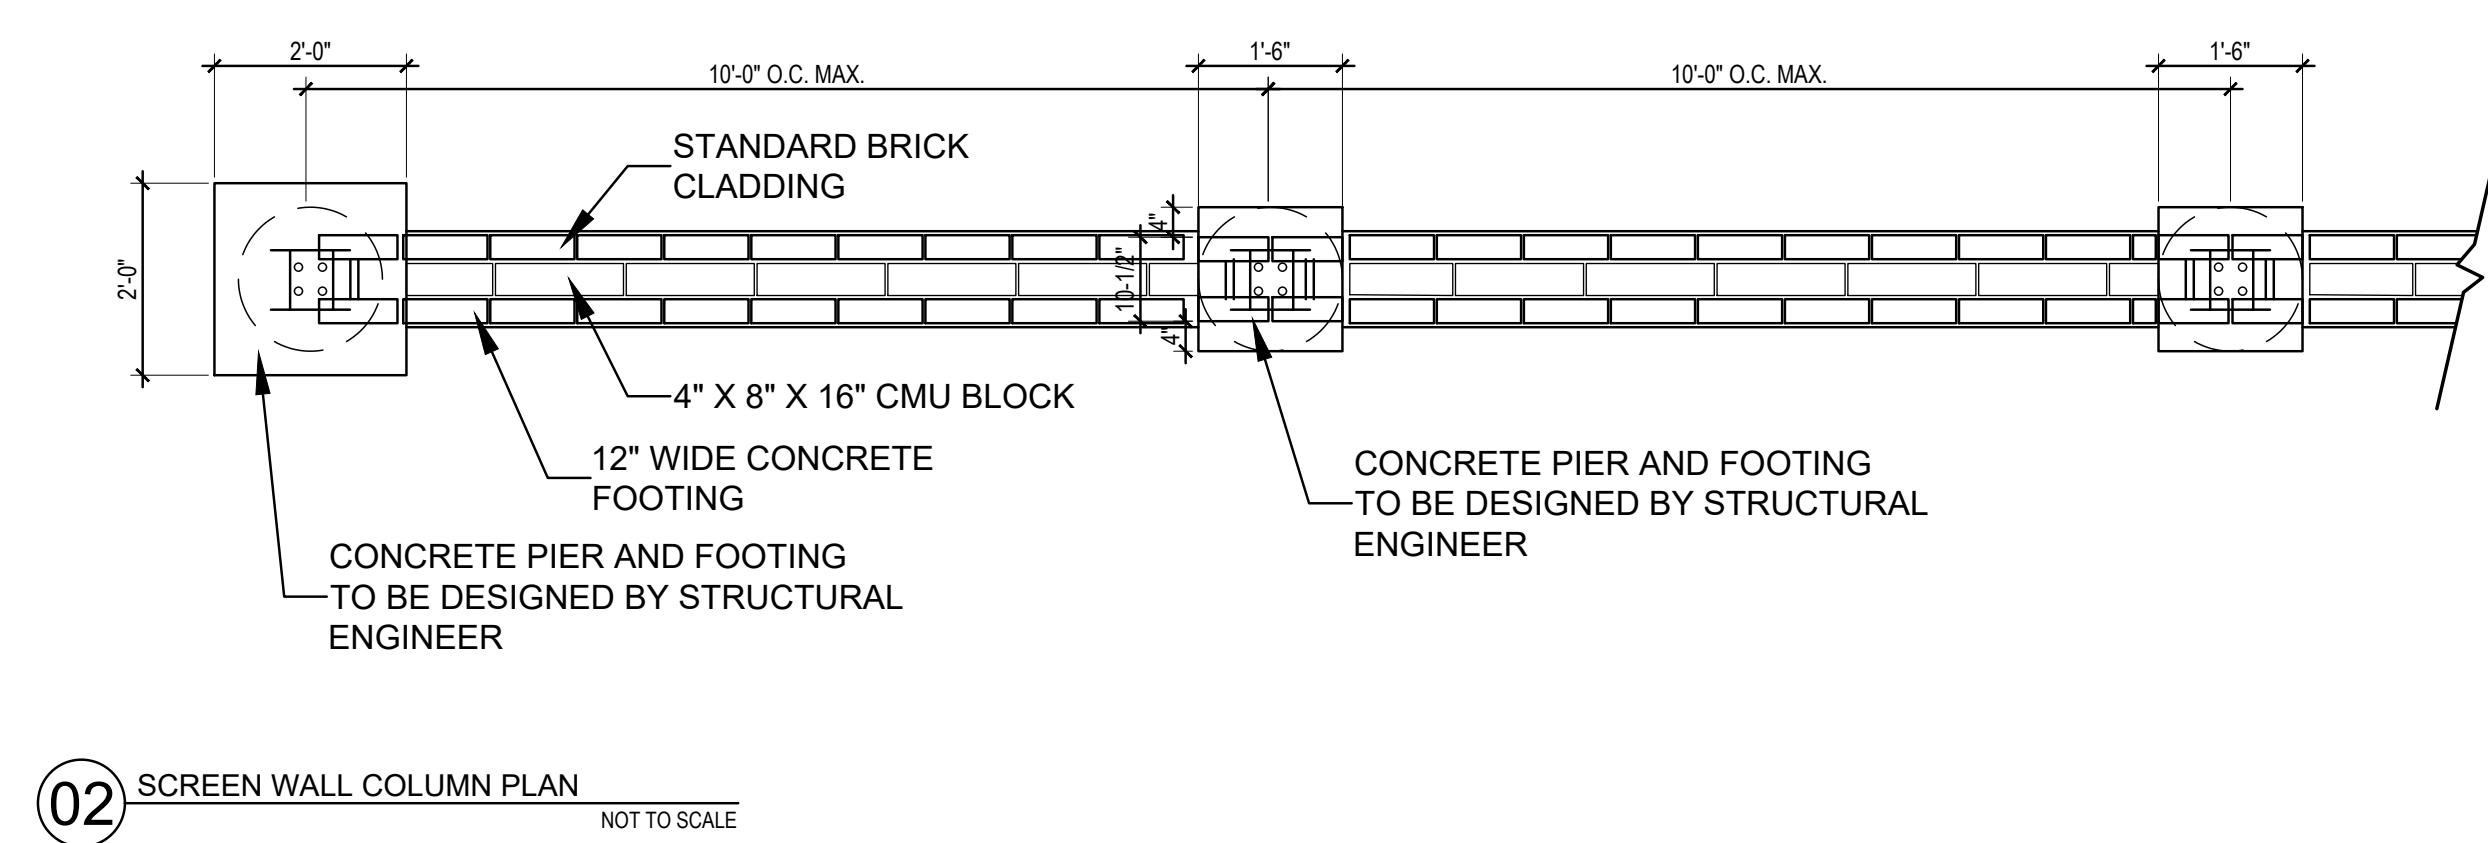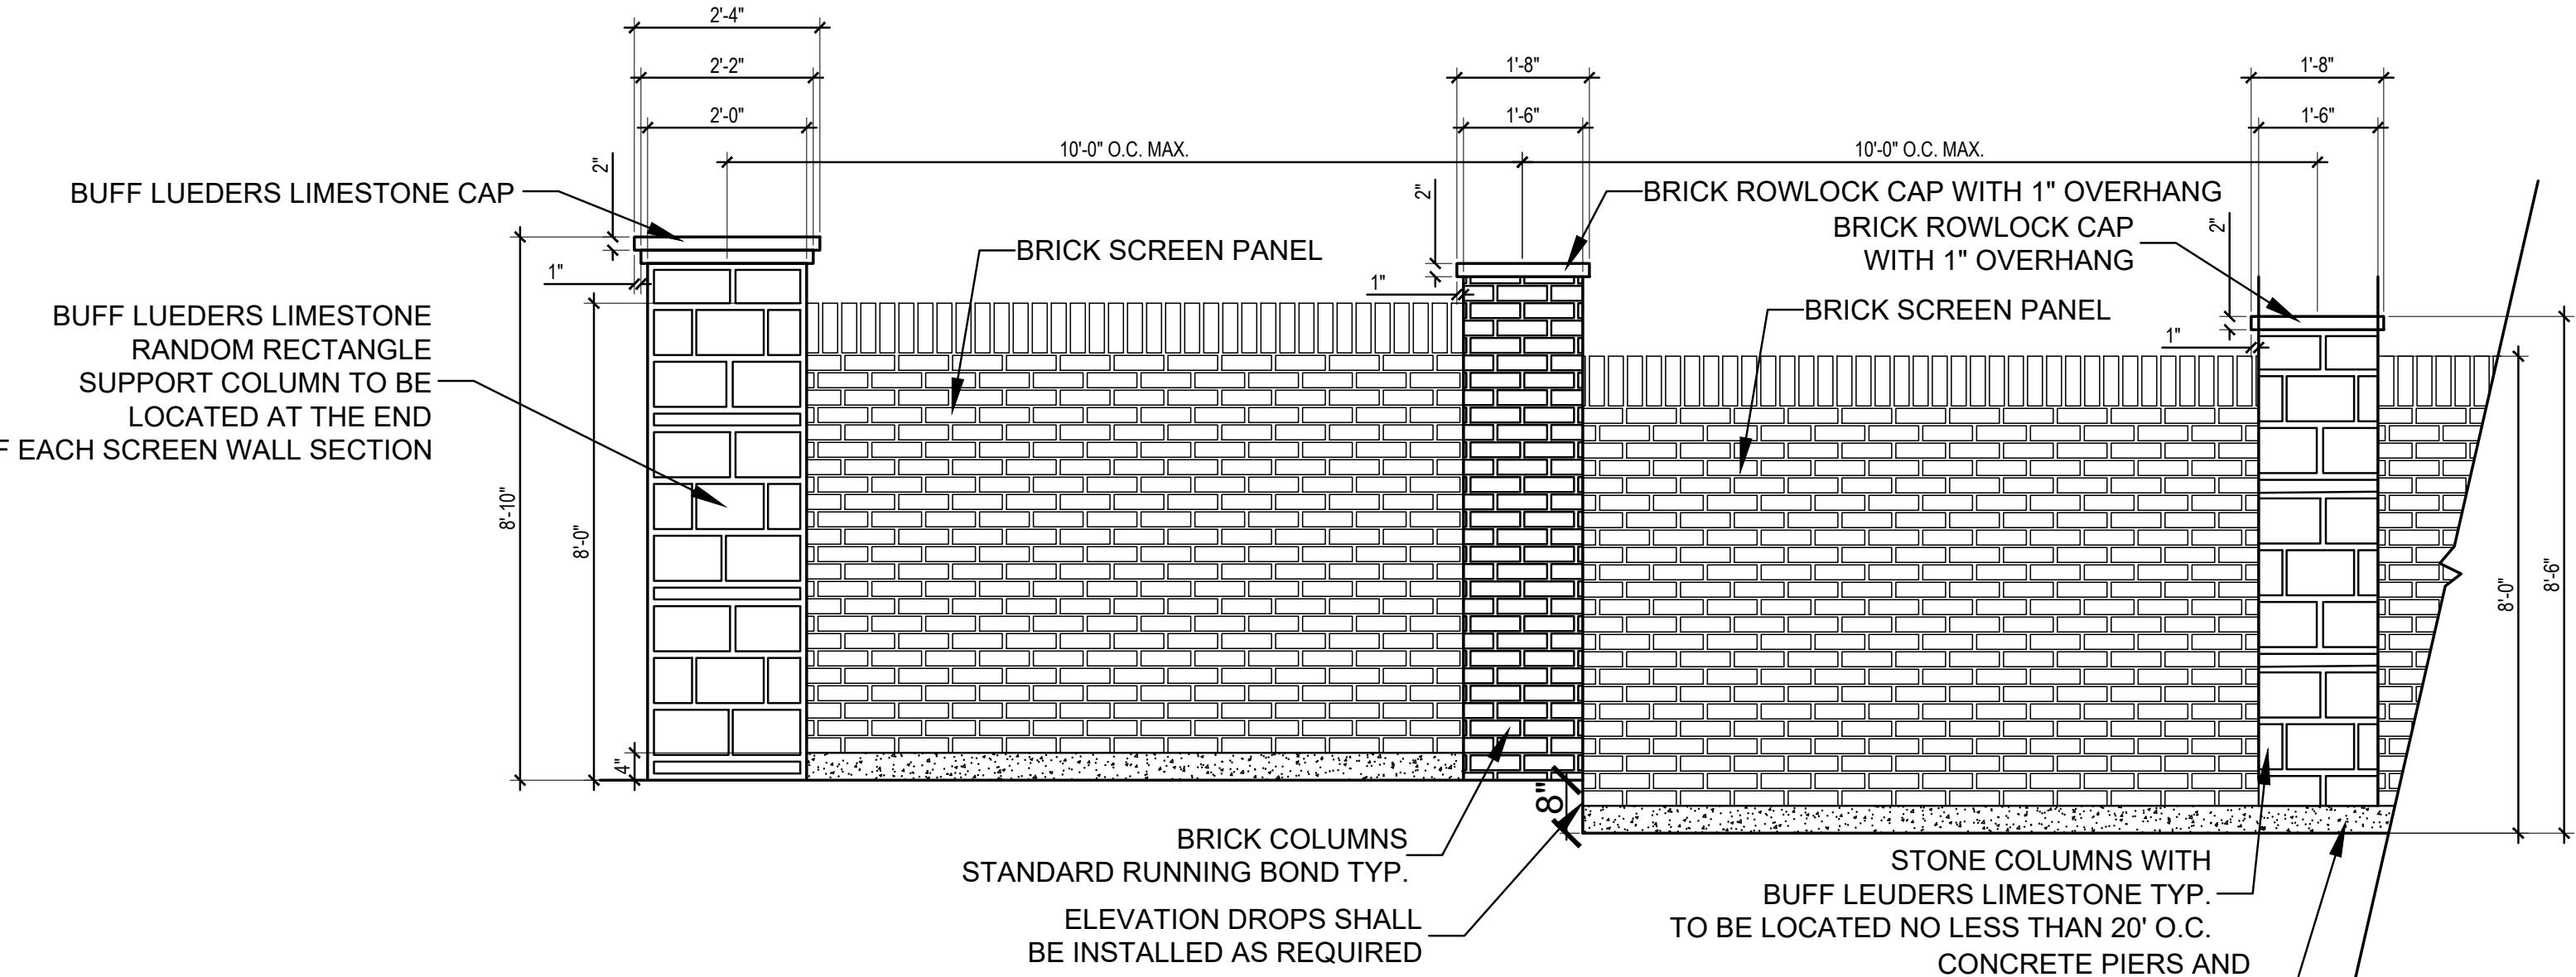

ISSUE:
FOR APPROVAL 08.05.2024
CITY COMMENTS 10.30.2024
CITY COMMENTS 01.15.2025

DATE:
01.27.2025


SHEET NAME:
WALL & FENCE DETAILS

SHEET NUMBER:

L.4

RESIDENTIAL DEVELOPMENT

OAK GROVE LANE
LITTLE ELM, TEXAS

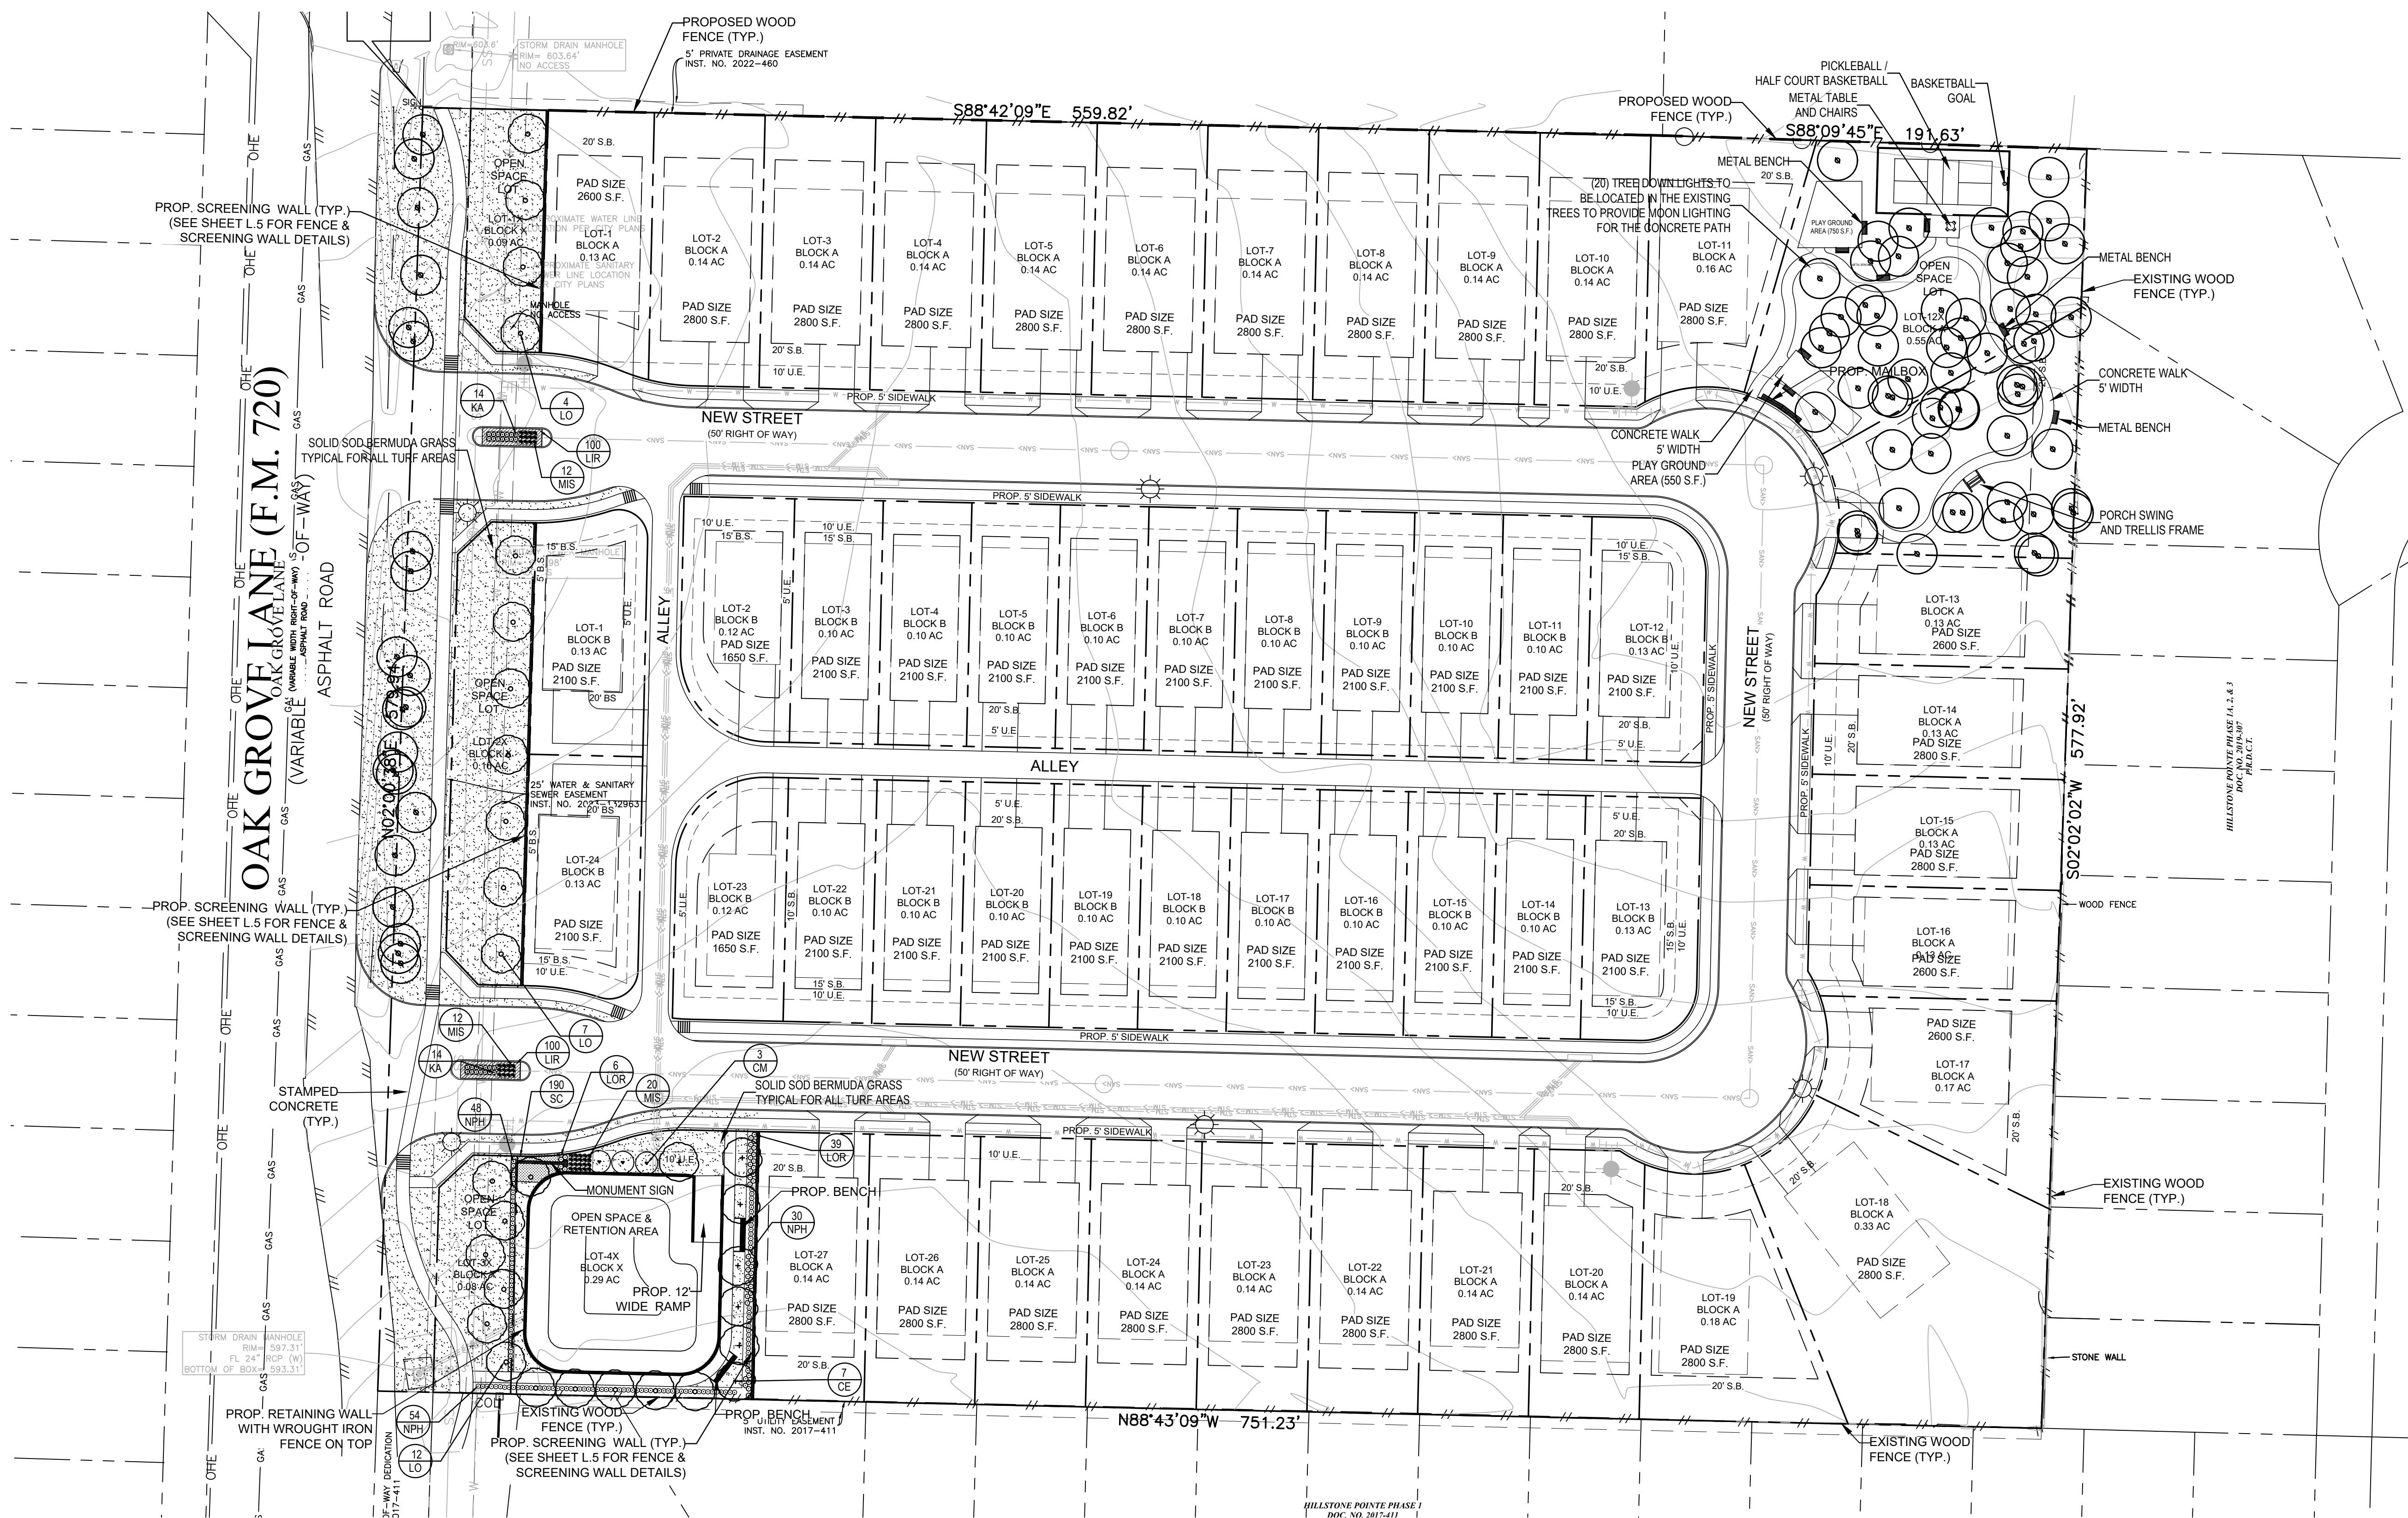

PLANT MATERIAL SCHEDULE					
TREES					
TYPE	QTY	COMMON NAME	BOTANICAL NAME	SIZE	REMARKS
CE	7	Cedar Elm	<i>Ulmus crassifolia</i>	3" cal.	container, 12' ht., 5' spread, 6' clear straight trunk
CM	3	Crepe Myrtle	<i>Lagerstroemia indica</i>	3" cal.	container, 3 or 5 trucks, tree form
LO	23	Live Oak	<i>Quercus virginiana</i>	3" cal.	container, 12' ht., 5' spread, 6' clear straight trunk
SHRUBS					
TYPE	QTY	COMMON NAME	BOTANICAL NAME	SIZE	REMARKS
KA	28	Kaleidoscope Abelia	<i>Abelia grandiflora 'Kaleidoscope'</i>	3 gal.	container grown, 18" ht., 18" spread
LOR	44	Loropetalum	<i>Loropetalum chinense</i>	3 gal.	container grown, 20" ht., 20" spread
MIS	44	Miscanthus	<i>Miscanthus sinensis</i>	3 gal.	container full, well rooted
NPH	133	Needlepoint Holly	<i>Ilex cornuta 'Needlepoint'</i>	3 gal.	container grown, 20" ht., 20" spread
GROUNDCOVERS					
TYPE	QTY	COMMON NAME	BOTANICAL NAME	SIZE	REMARKS
LIR	200	Super Blue Liriope	<i>Liriope muscari</i>	4" pots	container full, well rooted, 12" o.c.
SC	190	Seasonal Color	<i>Cynodon dactylon '419'</i>	4" pots	selection by owner, 12" o.c. solid sod refer to notes

NOTE: Plant list is an aid to bidders only. Contractor shall verify all quantities on plan. All heights and spreads are minimums. All plant material shall meet or exceed remarks as indicated. All trees to have straight trunks and be matching within varieties.

TOWN OF LITTLE ELM LANDSCAPE NOTES

- THE OWNER, TENANT AND THEIR AGENT, IF ANY SHALL BE JOINTLY AND SEVERELY RESPONSIBLE FOR THE MAINTENANCE OF ALL LANDSCAPING. ALL REQUIRED SHALL BE MAINTAINED IN A NEAT AND ORDERLY MANNER AT ALL TIMES. THIS SHALL INCLUDE MOWING, EDGING, PRUNING, AND FERTILIZING, WATERING, AND SUCH ACTIVITIES COMMON TO THE MAINTENANCE OF LANDSCAPING.
- LANDSCAPE AREAS SHALL BE KEPT FREE OF TRASH, LITTER, WEEDS AND OTHER SUCH ACTIVITIES COMMON TO MAINTENANCE OF LANDSCAPING.
- NO SUBSTITUTIONS FOR PLANT MATERIALS ARE ALLOWED WITHOUT WRITTEN APPROVAL BY THE DIRECTOR AND ACKNOWLEDGED BY AN APPROVAL STAMP ON THE LANDSCAPE PLAN.
- THE RIGHT-OF-WAY ADJACENT TO REQUIRED LANDSCAPE AREAS SHALL BE MAINTAINED BY THE ADJACENT PROPERTY OWNER IN THE SAME MANNER AS THE REQUIRED LANDSCAPE AREA. ALL DRIVEWAYS WILL MAINTAIN VISIBILITY AS APPROVED BY THE DIRECTOR. ALL PLANTINGS INTENDED FOR EROSION CONTROL WILL BE MAINTAINED BY THE TOWN WHICH REQUIRE RELOCATION TO PREVENT EROSION OR SLIPPAGE.
- ALL PLANT MATERIAL SHALL BE MAINTAINED IN A HEALTHY AND GROWING CONDITION AS IS APPROPRIATE FOR THE SEASON OF THE YEAR. PLANT MATERIAL WHICH DIE SHALL BE REPLACED WITH PLANT MATERIAL OF SIMILAR VARIETY AND SIZE, WITHIN 30 DAYS OR A DATE APPROVED BY THE DIRECTOR, BASED ON CURRENT SEASONS AND WEATHER CONDITIONS (E.G. DROUGHT OR FREEZE).
- WHEN POWER LINES ARE PRESENT, TREES SHALL NOT BE PLANTED UNDERNEATH AND SHOULD BE ORIENTED IN A MANNER TO AVOID CONFLICT. SUBSTITUTION OF PLANT MATERIAL IS NOT ALLOWED WITHOUT PRIOR WRITTEN AUTHORIZATION FROM THE DIRECTOR.
- ALL REQUIRED LANDSCAPE AREAS SHALL BE PROVIDED WITH AN AUTOMATIC UNDERGROUND IRRIGATION SYSTEM WITH RAIN AND FREEZE SENSORS AND EVAPOTRANSPIRATION (ET) WEATHER-BASED CONTROLLER AND SAID IRRIGATION SYSTEM SHALL BE DESIGNED BY A QUALIFIED PROFESSIONAL AND INSTALLED BY A LICENSED IRRIGATOR.
- ALL TREES ARE TO BE EQUIPPED WITH A BUBBLER IRRIGATION SYSTEM.
- REQUIRED LANDSCAPED OPEN AREA AND DISTURBED AREAS SHALL BE COMPLETELY COVERED WITH LIVING PLANT MATERIAL, PER THE LANDSCAPE ORDINANCE.
- ALL LANDSCAPING SHALL BE PLANNED AREAS THAT IS DEFINED BY EDGING, MULCH OR ANOTHER PRACTICE APPROVED BY THE TOWN.
- ALL STREETSCAPE FURNITURE (BENCHES, BOLLARDS, LAMPOST, TRASH RECEPTEACES, PATIO FURNITURE, BIKE RACKS, ETC.) SHALL BE A CHIP AND FLAKE RESISTANT METAL, DECORATIVE, AND GENERALLY BLACK "STORM CLOUD" IN COLOR.

ISSUE:
FOR APPROVAL 08.05.2024
CITY COMMENTS 09.03.2024
CITY COMMENTS 10.30.2024
CITY COMMENTS 01.15.2025

DATE:
01.27.2025

SHEET NAME:
LANDSCAPE PLAN

SHEET NUMBER:
L.5


02 LANDSCAPE PLAN
SCALE 1"=40'-0"
0 20 40 80

LANDSCAPE ARCHITECT
STUDIO GREEN SPOT, INC.
1782 W. McDERMOTT DR.
ALLEN, TEXAS 75013
(469) 369-4446
CHRIS@STUDIOGREENSPOT.COM



OAK GROVE LANE LITTLE ELM, TEXAS

RESIDENTIAL DEVELOPMENT

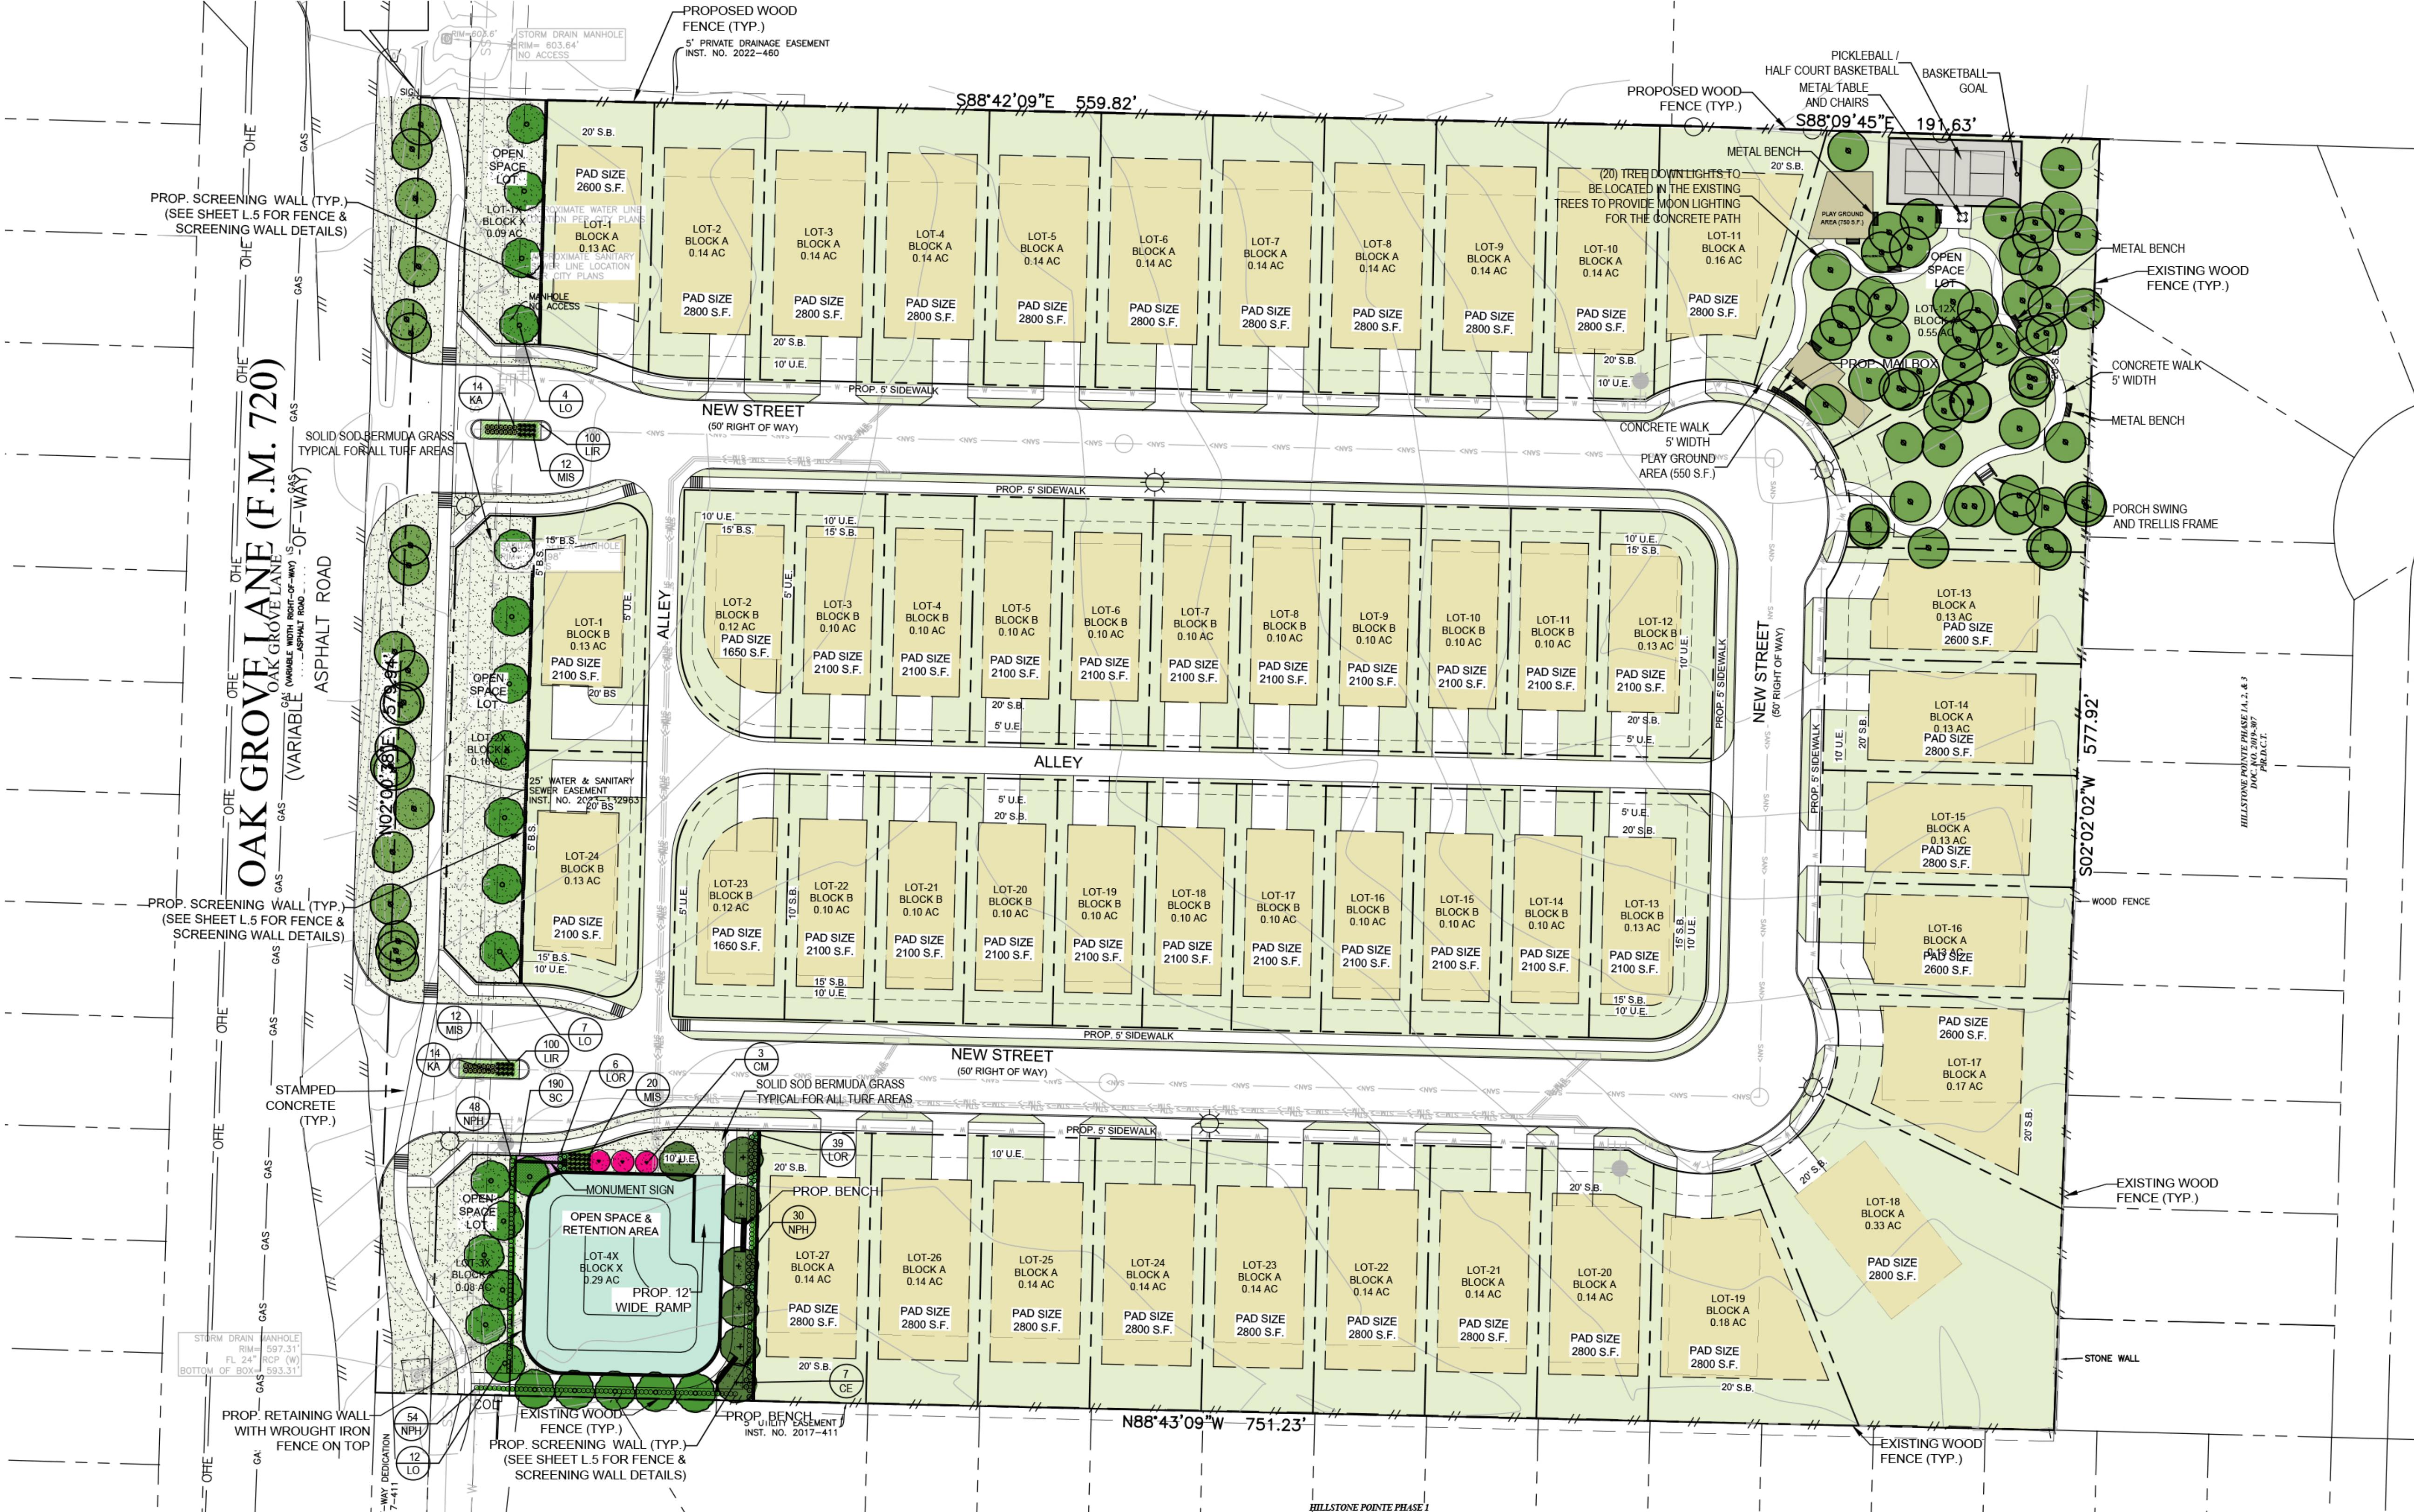

LANDSCAPE TABULATIONS

REQUIREMENTS FOR EACH LOT:

- 30'-49' foot lot, front or J-swing entry
- 1 large
- FRONT YARD
- 1 large
- BACKYARD
- 1 large/1 small
- SHRUBS
- 8

- 30'-49' foot lot, rear entry
- 1 large
- FRONT YARD
- 1 large
- BACKYARD
- 1 large
- SHRUBS
- 10

- 30'-49' foot lot, corner lot
- 1 large/1 small
- FRONT YARD
- 1 large
- BACKYARD
- 1 large
- SHRUBS
- 10

OPEN SPACE REQUIREMENTS:
(1) Tree Per 20'L.F. of the Detention Pond & Shrub Screening from public view of Pond. Some usable open space is to be provided. (benches, gazebos, etc.)
Detention Pond Area: 448'.

REQUIRED
(22) trees
shrub screening

PROVIDED
(22) trees
shrub screening

BENCHES

PLANT MATERIAL LEGEND



PLANT MATERIAL SCHEDULE

TREES					
TYPE	QTY	COMMON NAME	BOTANICAL NAME	SIZE	REMARKS
CE	7	Cedar Elm	<i>Ulmus crassifolia</i>	3" cal.	container, 12' ht., 5' spread, 6' clear straight trunk
CM	3	Crepe Myrtle	<i>Lagerstroemia indica</i>	3" cal.	container, 3 or 5 trucks, tree form
LO	23	Live Oak	<i>Quercus virginiana</i>	3" cal.	container, 12 ht., 5' spread, 6' clear straight trunk
SHRUBS					
TYPE	QTY	COMMON NAME	BOTANICAL NAME	SIZE	REMARKS
KA	28	Kaleidoscope Abelia	<i>Abelia grandiflora "Kaleidoscope"</i>	3 gal.	container grown, 18" ht., 18" spread
LOR	44	Loropetalum	<i>Loropetalum chinense</i>	3 gal.	container grown, 20 ht., 20" spread
MIS	44	Miscanthus	<i>Miscanthus sinensis</i>	3 gal.	container full, well rooted
NPH	133	Needlepoint Holly	<i>Ilex cornuta "Needlepoint"</i>	3 gal.	container grown, 20 ht., 20" spread
GROUNDCOVERS					
TYPE	QTY	COMMON NAME	BOTANICAL NAME	SIZE	REMARKS
LIR	200	Super Blue Liriope	<i>Liriope muscari</i>	4" pots	container full, well rooted, 12" o.c.
SC	190	Seasonal Color	<i>Cynodon dactylon '419'</i>	4" pots	selection by owner, 12" o.c. solid soil refer to notes

NOTE: Plant list is an aid to bidders only. Contractor shall verify all quantities on plan. All heights and spreads are minimums. All plant material shall meet or exceed remarks as indicated. All trees to have straight trunks and be matching within varieties.

TOWN OF LITTLE ELM LANDSCAPE NOTES

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LANDSCAPE NOTES

- CONTRACTOR SHALL VERIFY ALL EXISTING AND PROPOSED SITE ELEMENTS AND NOTIFY ARCHITECT OF ANY DISCREPANCIES. SURVEY DATA OF EXISTING CONDITIONS WAS SUPPLIED BY OTHERS.
- CONTRACTOR SHALL LOCATE ALL EXISTING UNDERGROUND UTILITIES AND NOTIFY ARCHITECT OF ANY CONFLICTS. CONTRACTOR SHALL EXERCISE CAUTION WHEN WORKING IN THE VICINITY OF UNDERGROUND UTILITIES.
- CONTRACTOR IS RESPONSIBLE FOR OBTAINING ALL REQUIRED LANDSCAPE AND IRRIGATION PERMITS.
- CONTRACTOR TO PROVIDE A MINIMUM 2% SLOPE AWAY FROM ALL STRUCTURES.
- ALL PLANTING BEDS AND LAWN AREAS TO BE SEPARATED BY STEEL EDGING. NO STEEL TO BE INSTALLED ADJACENT TO SIDEWALKS OR CURBS.
- ALL LANDSCAPE AREAS TO BE 100% IRRIGATED WITH AN UNDERGROUND AUTOMATIC IRRIGATION SYSTEM AND SHALL INCLUDE RAIN AND FREEZE SENSORS.
- ALL LAWN AREAS TO BE SOLID SOUD BERMUDAGRASS, UNLESS OTHERWISE NOTED ON THE DRAWINGS.

LANDSCAPE ARCHITECT
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02 LANDSCAPE PLAN
SCALE 1"-40'-0"
L.5

ISSUE:
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L.5



RESIDENTIAL DEVELOPMENT

OAK GROVE LANE LITTLE ELM, TEXAS

SECTION 02900 - LANDSCAPE

PART 1 - GENERAL

1.1 REFERENCED DOCUMENTS

Refer to bidding requirements, special provisions, and schedules for additional requirements.

1.2 DESCRIPTION OF WORK

Work included: Furnish all supervision, labor, materials, services, equipment and appliances required to complete the work covered in conjunction with the landscaping covered in these specifications and landscaping plans, including:

1. Planting (trees, shrubs, and grass)
2. Bed preparation and fertilization
3. Notification of sources
4. Water and Maintenance until final acceptance
5. Guarantee

1.3 REFERENCE STANDARDS

- A. American Standard for Nursery Stock published by American Association of Nurserymen: 27 October 1980, Edition; by American National Standards Institute, Inc. (Z50.1) – plant material.
 - B. American Joint Committee on Horticultural Nomenclature: 1942 Edition of Standardized Plant Names.
 - C. Texas Association of Nurserymen, Grades and Standards.
 - D. Hortis Third, 1976 - Cornell University
- 1.4 NOTIFICATION OF SOURCES AND SUBMITTALS**
- A. The Contractor shall, within ten (10) days following acceptance of bid, notify the Architect/Owner of the sources of plant materials and bed preparation required for the project.
 - B. Samples: Provide representative quantities of sandy loam soil, mulch, bed mix material, gravel, and crushed stone. Samples shall be approved by Architect before use on project.
 - C. Product Data: Submit complete product data and specifications on all other specified materials.
 - D. Submit three representative samples of each variety of ornamental trees, shrubs, and groundcover plants for Architect's approval. When approved, tag, install, and maintain as representative samples for final installed plant materials.
 - E. File Certificates of Inspection of plant material by state, county, and federal authorities with Architect, if required.
 - F. Soil Analysis: Provide sandy loam soil analysis if requested by the Architect.

PART 3 - EXECUTION

3.1 BED PREPARATION & FERTILIZATION

- A. Landscape Contractor to inspect all existing conditions and report any deficiencies to the Owner.
- B. All planting areas shall be conditioned as follows:
 1. Prepare new planting beds by scraping away existing grass and weeds as necessary. Till existing soil to a depth of six (6") inches prior to placing compost and fertilizer. Apply organic fertilizer as per manufacturers recommendations. Add six (6") inches of compost and one (1") depth of six (6") inches of the topsoil. Apply organic fertilizer such as Sustane or Green Sense at the rate of twenty (20) pounds per one thousand (1,000) square feet.
 2. All planting areas shall receive a two (2") layer of specified mulch.
 3. Backfill for tree pits shall be as follows: Use existing top soil on site use imported topsoil as needed) free from large clumps, rocks, debris, caliche, subsoils, etc., placed in nine (9") inch layers and watered in thoroughly.
- C. Grass Areas:
 1. Areas to be Solid Sod Bermudagrass. Blocks of sod should be laid joint to joint, (staggered joints) after fertilizing the ground first. Roll grass areas to achieve a smooth, even surface. The joints between the blocks of sod should be filled with topsoil and leveled off. Sod should be planted within 24 hours of delivery.
 2. Areas to be Hydromulch Common Bermudagrass: Hydromulch with bermudagrass seed at a rate of two (2) pounds per one thousand (1,000) square feet. Use a 4' x 8' batter board against the bed area.

3.2 INSTALLATION

- A. Maintenance of plant materials shall begin immediately after each plant is delivered to the site and shall continue until all construction has been satisfactorily accomplished.
- B. Plant materials shall be delivered to the site only after the beds are prepared and area ready for planting. All shipments of nursery materials shall be thoroughly protected from strong winds and sun. All plants shall be planted at once, after delivery to the site, to be well protected against the possibility of drying by wind and sun. Balls of earth of B & B plants shall be kept covered with soil or other acceptable material. All plants remain the property of the Contractor until final acceptance.
- C. Position the trees and shrubs in their intended location as per plan.
- D. Notify the Landscape Architect for inspection and approval of all positioning of plant materials.
- E. Excavate pits with vertical sides and horizontal bottom. Tree pits shall be large enough to permit handling and planting without injury to balls of earth or roots and shall be of such depth that, when planted and settled, the crown of the plant shall bear the same relationship to the finish grade as it did to soil surface in original place of growth.

JOB CONDITIONS

- A. General Contractor to complete the following punch list: Prior to Landscape Contractor initiating any portion of landscape installation, General Contractor shall leave planting bed areas three (3") inches below finish grade of sidewalks, drives and curbs as shown on the drawings. All lawn areas to receive solid sod shall be left one (1") inch below the finish grade of sidewalks, drives, and curbs. All construction debris shall be removed prior to Landscape Contractor beginning any work.
 - B. General Contractor shall provide topsoil as described in Section 02200 - Earthwork.
 - C. Storage of materials and equipment at the job site will be at the risk of the Landscape Contractor. The Owner cannot be held responsible for theft or damage.
- 1.6 MAINTENANCE AND GUARANTEE**
- A. Maintenance:
 1. The Landscape Contractor will be held responsible for the maintenance of all work from the time of planting until final acceptance by the Owner. No trees, shrubs, groundcover or grass will be accepted unless they show a healthy growth and satisfactory foliage conditions.
 2. Maintenance shall include watering of trees and plants, cultivation, weeding, spraying, edging, pruning of trees, mowing of grass, cleaning up and all other work necessary of maintenance.
 3. A written notice requesting final inspection and acceptance should be submitted to the Owner at least seven (7) days prior to completion. An on-site inspection by Owner and Landscape Contractor will be completed prior to written acceptance.
 4. After final acceptance of installation, the Landscape Contractor will not be required to do any of the above listed work.
 - B. Guarantee:
 1. Trees shall be guaranteed for a twelve (12) month period after acceptance. Shrubs and groundcover shall be guaranteed for twelve (12) months. The Contractor shall replace all dead material as soon as weather permits and upon notification of the Owner. Plants, including trees, which have partially died so that shape, size, or symmetry has been damaged, shall be considered subject to replacement. In such cases, the opinion of the Owner shall be final.
 - a. Plants used for replacement shall be the same size and kind as those originally planted and shall be planted as originally specified. All work, including materials, labor and equipment used in replacements shall carry a twelve (12) month guarantee. Any damage, including rutts in lawns or bed areas incurred as a result of making replacements shall be immediately repaired.
 - b. At the direction of the Owner, plants may be replaced at the start of the next year's planting season. In such cases, dead plants shall be removed from the site and replaced immediately.
 - c. When plant replacements are made, plants, soil mix, fertilizer and mulch are to be utilized as originally specified and inspected for full compliance with Contract requirements. All replacements are to be included under "Work" of this section.
- 1.7 QUALITY ASSURANCE**
- A. General: Comply with applicable Federal, State, County and Local regulations governing landscape materials and work
 - B. Personnel: Employ only experienced personnel who are familiar with the required work. Provide full time supervision by a qualified foreman acceptable to Landscape Architect.
 - C. Selection of Plant Material:
 1. Work in concert with suppliers immediately upon obtaining notice of contract acceptance to select and book materials. Develop a program of maintenance (pruning and fertilization) which will insure the purchased materials will meet and/or exceed project specifications.
 2. Landscape Architect will provide a key identifying each tree location on site. Written verification will be required to document material selection, source and delivery schedule to site.
 3. Owner and/or Architect shall inspect all plant materials when reasonable at place of growth or compliance with requirements for genus, species, cultivar/variety, size and quality.
 4. Owner and/or Architect retains the right to further inspect all plant material upon arrival at the site and during installation for size and condition of root balls, limbs, branching habit, insects, injuries, and latent defects.
 5. Owner and/or Architect may reject unsatisfactory or defective material at any time during the process of work. Remove rejected materials from the site immediately. Plants damaged in transit or at job site shall be rejected.
- 1.8 PRODUCT DELIVERY, STORAGE AND HANDLING**
- A. Preparation:
 1. Balled and Burlapped (B&B) Plants: Dig and prepare shipment in a manner that will not damage roots, branches, shape, and future development.
 2. Container Grown Plants: Deliver plants in rigid container to hold ball shape and protect root mass.

2.2 SOIL PREPARATION MATERIALS

- A. Sandy Loam:
 1. Fertile, fertile, dark, loamy soil, free of clay lumps, subsoil, stones and other extraneous material and reasonably free of weeds and foreign grasses. Loam containing Dallisgrass or Nutgrass shall be rejected.
 2. Physical properties as follows:

Clay	- between 7-27 percent
Silt	- between 15-25 percent
Sand	- less than 52 percent
 3. Organic matter shall be 3%-10% of total dry weight.
 4. If requested, provide a certified soil analysis conducted by an approved soil testing laboratory verifying that sandy loam meets the above requirements.

- B. Organic Material: Compost with a mixture of 80% vegetative matter and 20% animal waste. Ingredients should be a mix of coarse and fine textured material.

- C. Premixed Bedding Soil as supplied by Vital Earth Resources, Gladewater, Texas; Professional Bedding Soil as supplied by Living Earth Technology, Dallas, Texas or Acid Gro Municipal Mix as supplied by Soil Building Systems, Dallas, Texas or approved equal.

- D. Sharp Sand: Sharp sand must be free of seeds, soil particles and weeds.

- E. Mulch: Double Shredded Hardwood Mulch, partially decomposed, dark brown. Living Earth Technologies or approved equal.


- F. Organic Fertilizer: Fertilaid, Sustane, or Green Sense or equal as recommended for required applications. Fertilizer shall be delivered to the site in original unopened containers, each bearing the manufacturer's guaranteed statement of analysis.

- A. Commercial Fertilizer: 10-20-10 or similar analysis. Nitrogen source to be a minimum 50% slow release organic Nitrogen (SCU or UF) with a minimum 8% sulphur and 4% iron, plus micronutrients.

- B. Peat: Commercial sphagnum peat moss or partially decomposed shredded pine bark or other approved organic material.

2.3 MISCELLANEOUS MATERIALS

- A. Steel Edging: Shall be Ryerson "Estate Curbing", 1/8" x 4" with stakes 4' on center.
- B. Staking Material for Shade Trees:
 1. Post: Studded T-Post #1 Armco with anchor plate; 6'-0" length; paint green.
 2. Wire: 12 gauge, single strand, galvanized wire.
 3. Rubber hose: 2 ply, fiber reinforced hose, minimum 1/8 inch inside diameter. Color: Black.
- C. Gravel: Washed native pea gravel, graded 1 in. to 1-1/2 in.
- D. Filter Fabric: Mirafi 140N by Celanese Fibers Marketing Company, available at Loftland Co., (214) 631-5250 or approved equal.

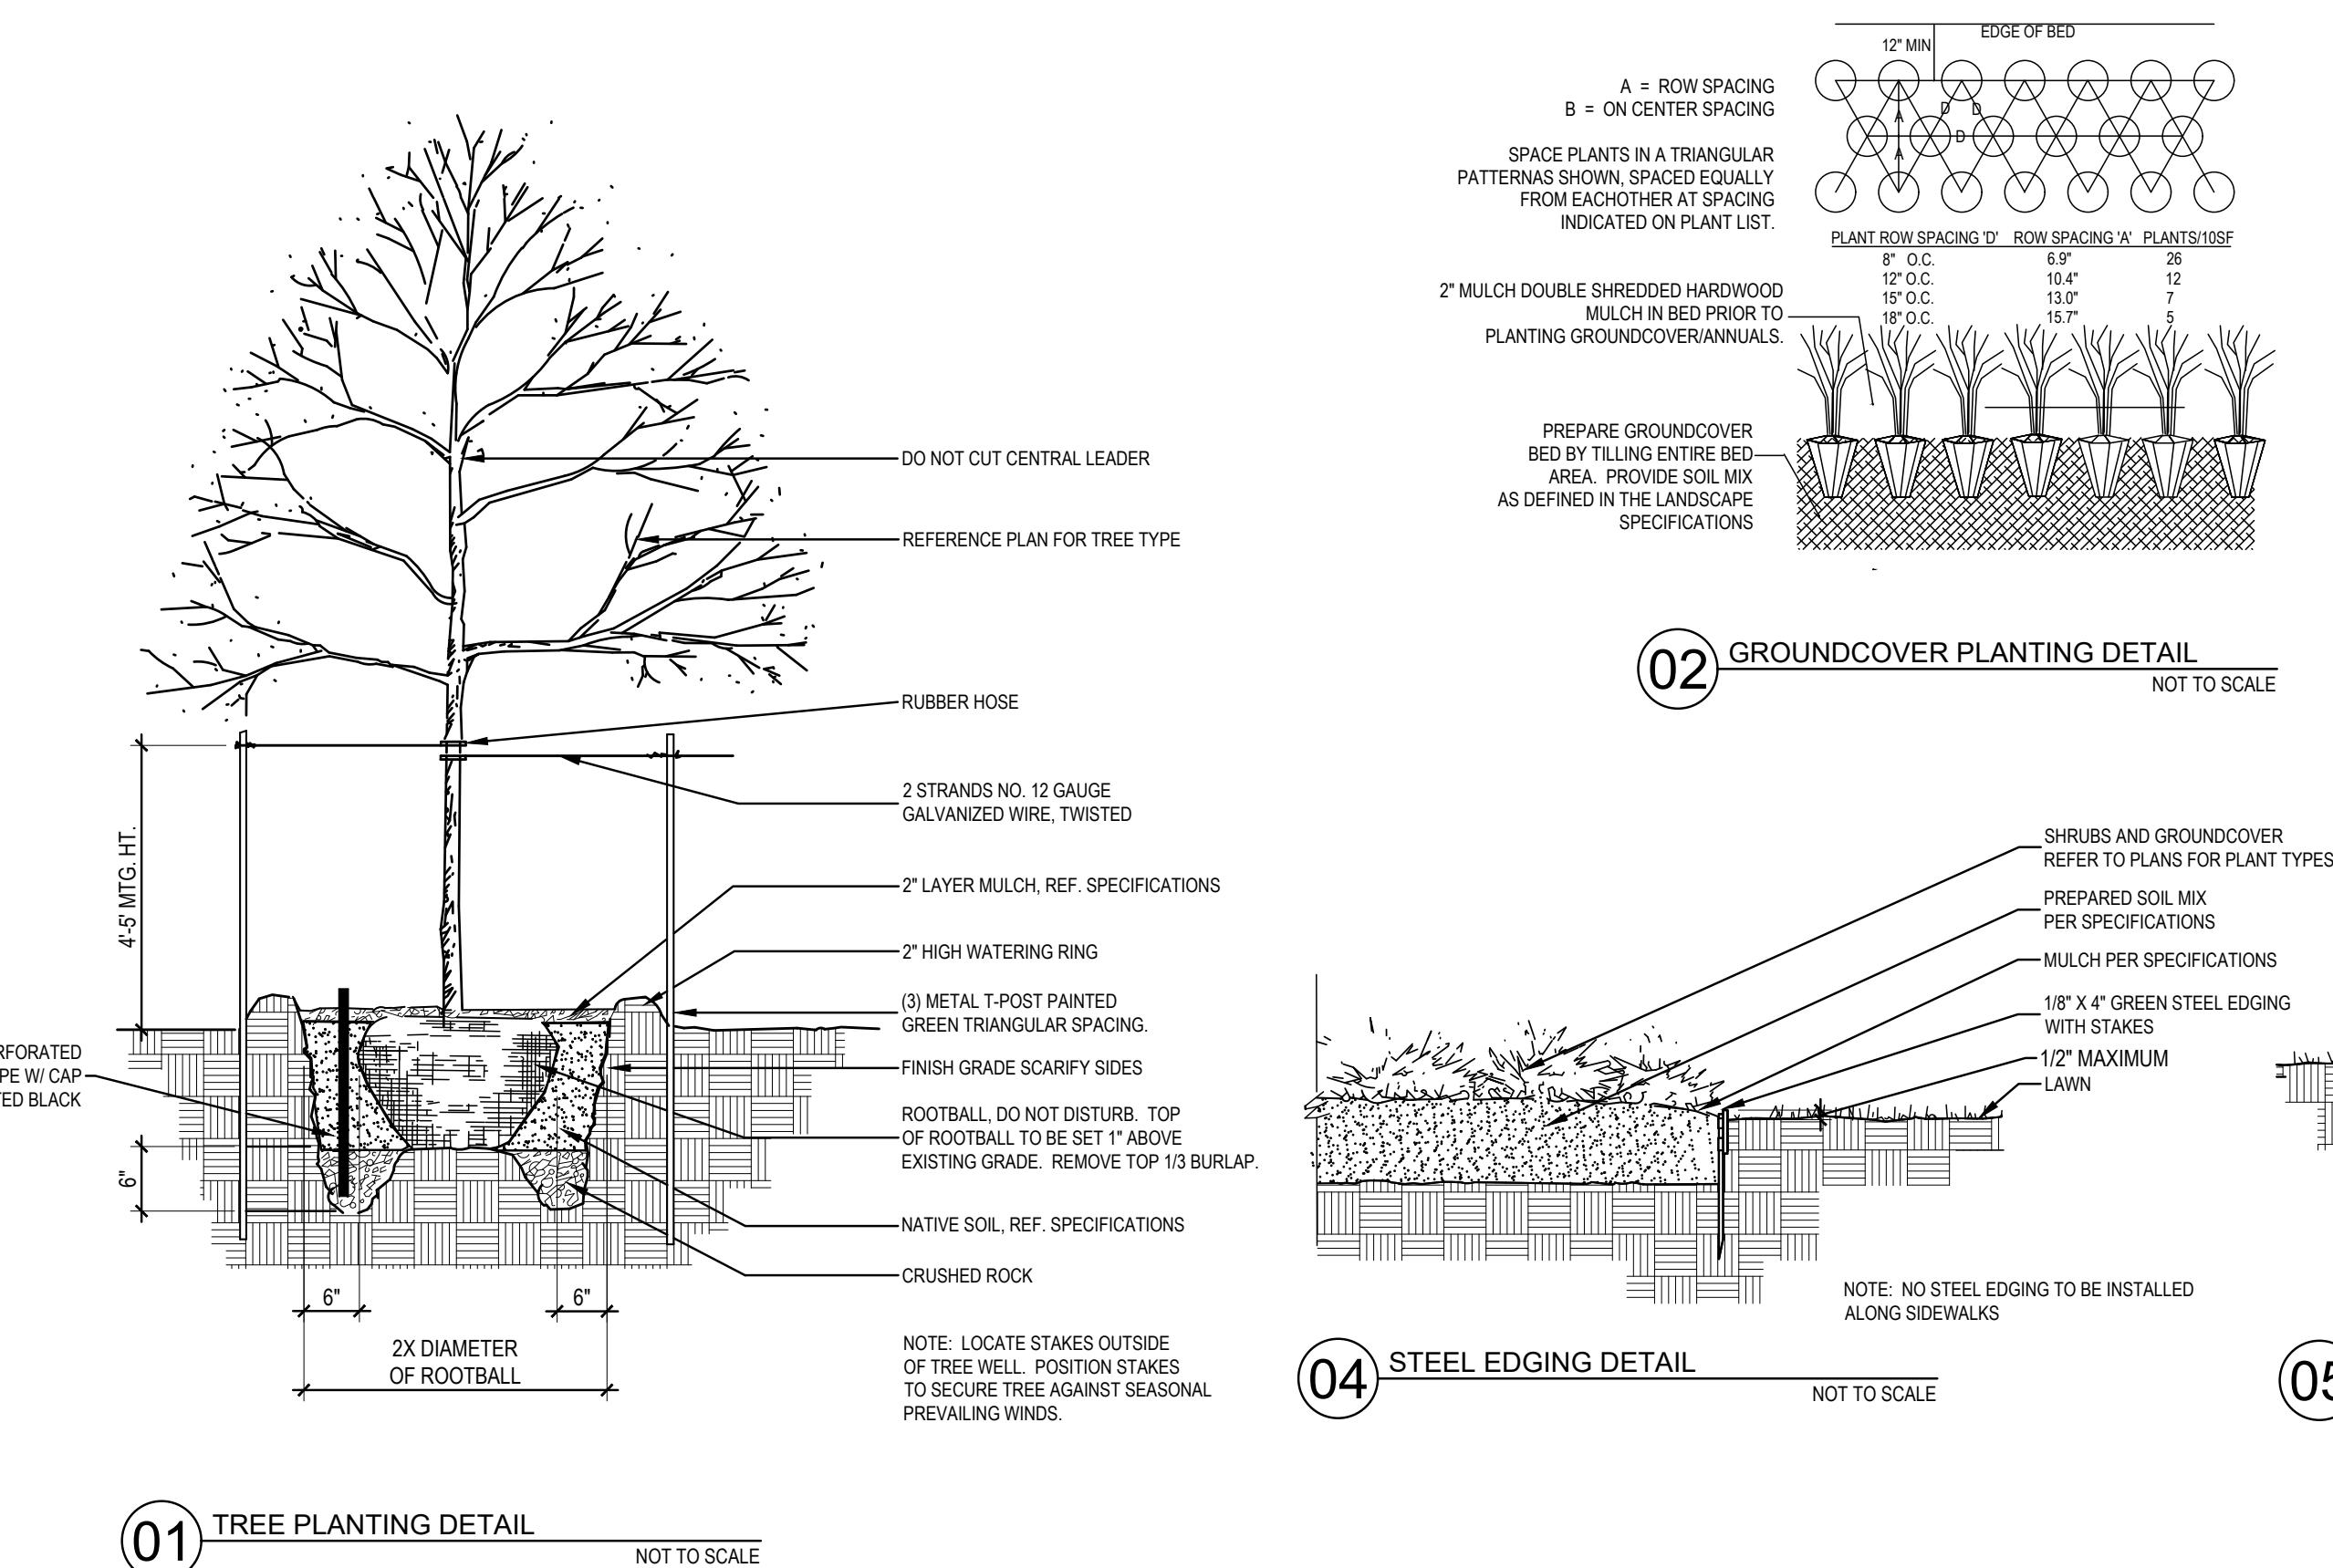

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LANDSCAPE SPECIFICATIONS

SHEET NUMBER:



Plan 60699ND

European House Plan with Vaulted Great Room - 2661 Sq Ft

2,661

Heated S.F.

4-5

Beds

3.5 - 4.5

Baths

1

Floors

3

Car Garage

















Photo courtesy of:



















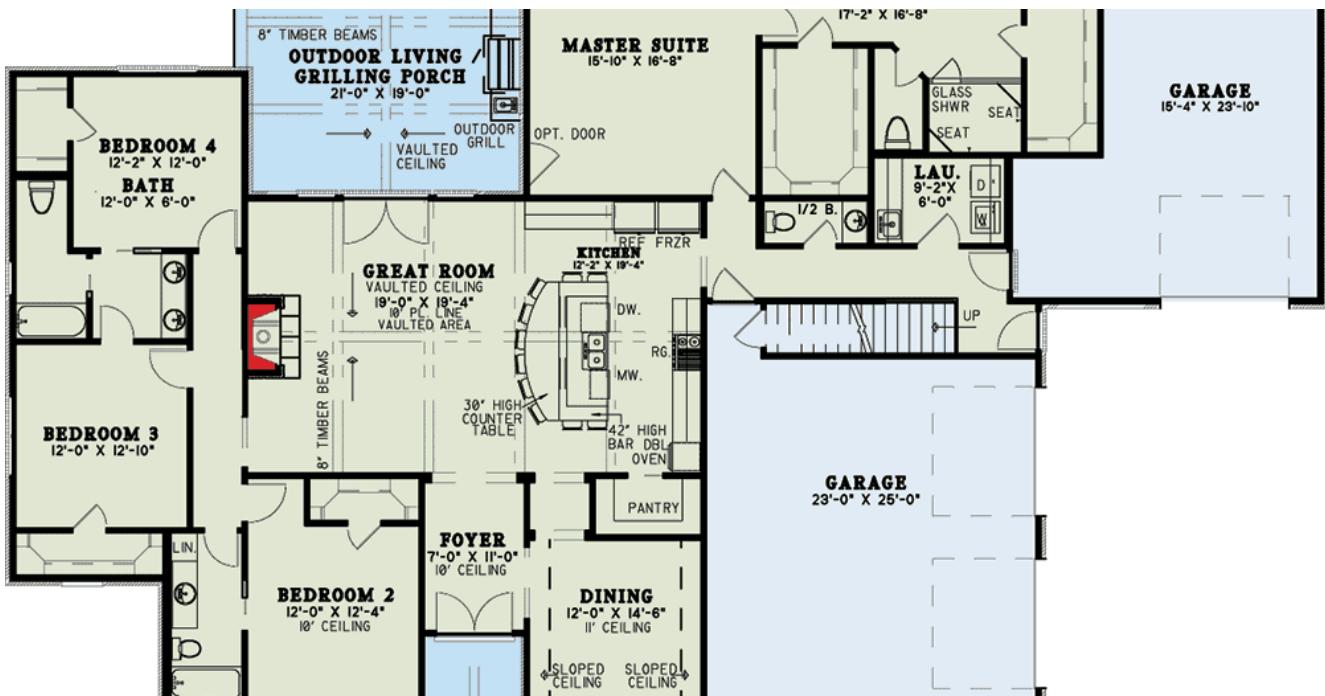

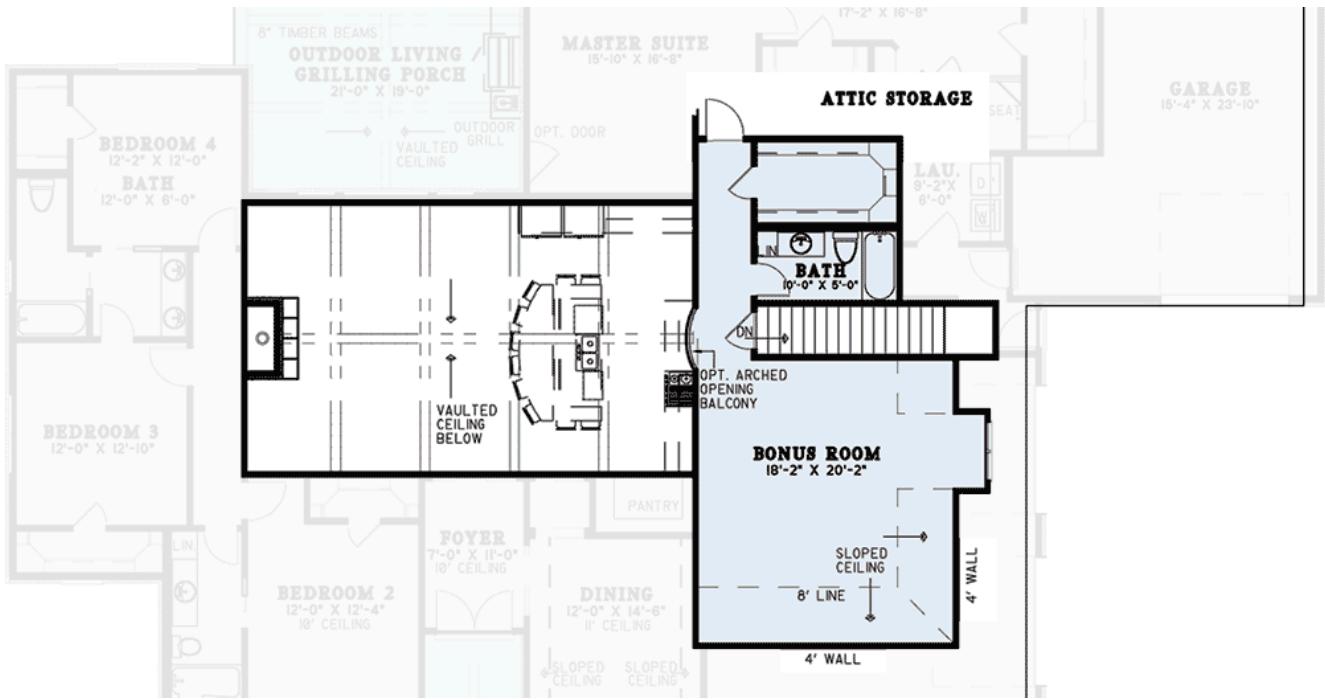

Plan 60699ND
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European House Plan with Vaulted Great Room - 2661 Sq Ft

2,661

Heated S.F.

4-5

Beds

3.5 - 4.5

Baths

1


Floors

3

Car Garage

Floor Plan

Main Level

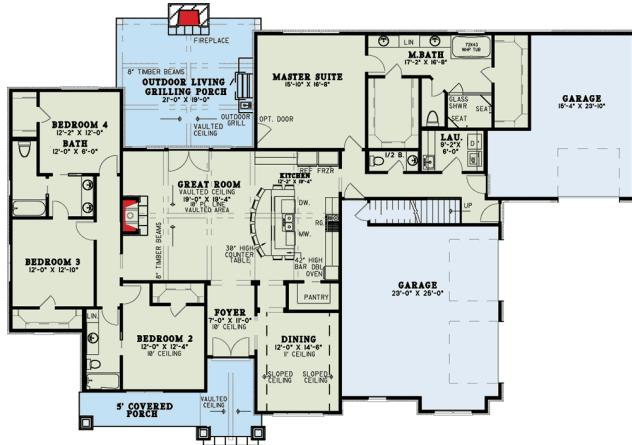

2nd Floor



Plan Details

Square Footage Breakdown

Total:	2,661 sq. ft.
1st Floor:	2,661 sq. ft.

Dimensions

Width:	91' 6"
Depth:	61' 3"
Max ridge height:	33' 0"

Beds/Baths

Bedrooms:	4 or 5
Full bathrooms:	3 or 4
Half bathrooms:	1

Garage

Type:	Attached
Area:	1092 sq. ft.
Count:	3 Cars
Entry Location:	Front, Side

Foundation Type

Standard Foundations:	Slab, Crawl
Optional Foundations:	Basement, Daylight, Walkout

Exterior Walls

Standard Type(s):	2x4
Optional Type(s):	2x6

Ceiling Heights

Floor / Height:	First Floor / 9' 0"	Second Floor / 8' 0"
-----------------	----------------------------	-----------------------------

Roof

Primary Pitch:	12 on 12
Framing Type:	Stick

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Plan 60699ND
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Plan 51750HZ

4 Bed Craftsman with Open Concept Living Space and Bonus Room

2,329

Heated S.F.

4-5

Beds

2.5 - 3.5

Baths

1-2

Floors

2

Car Garage














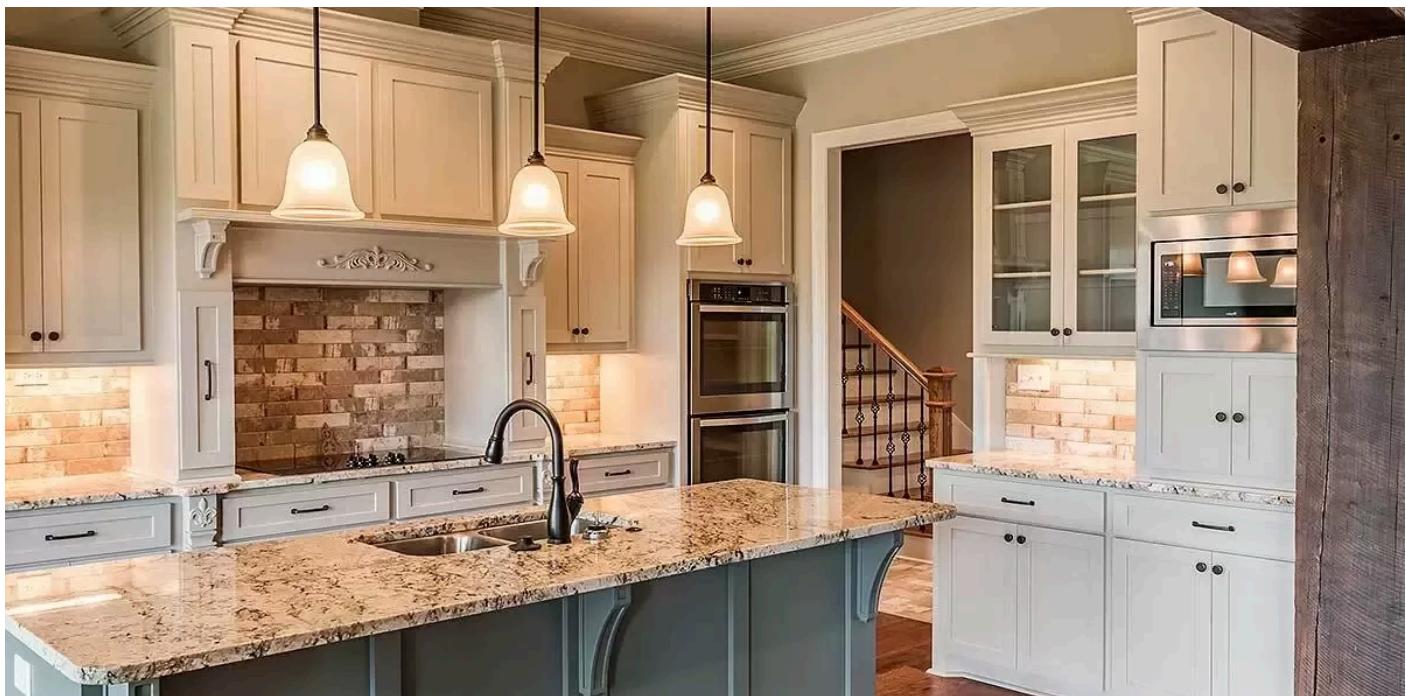
















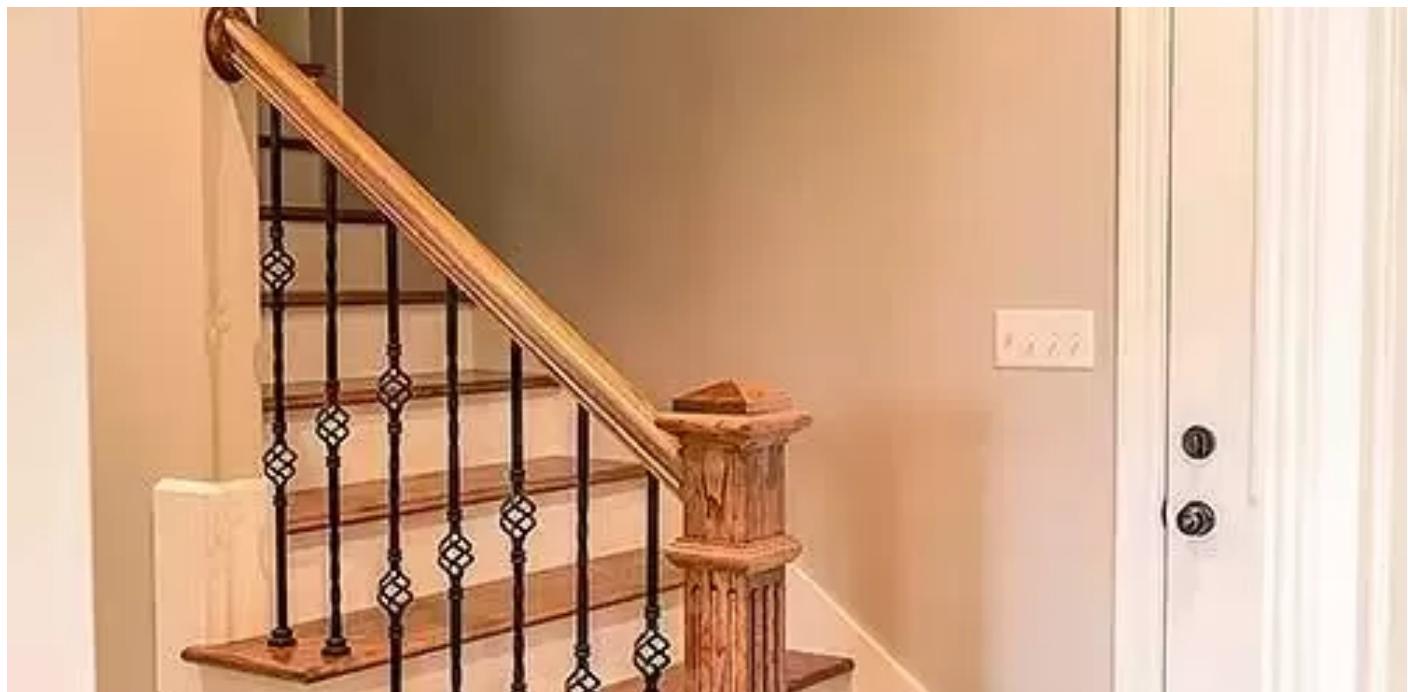







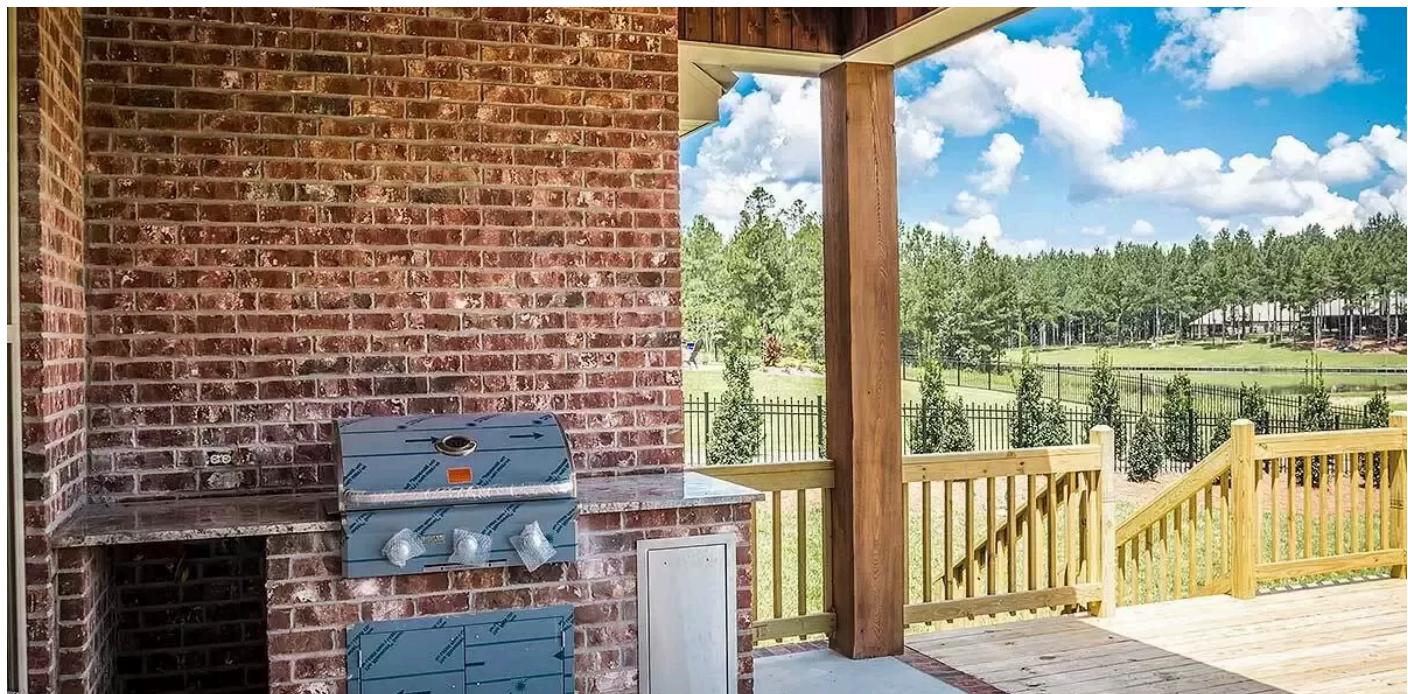

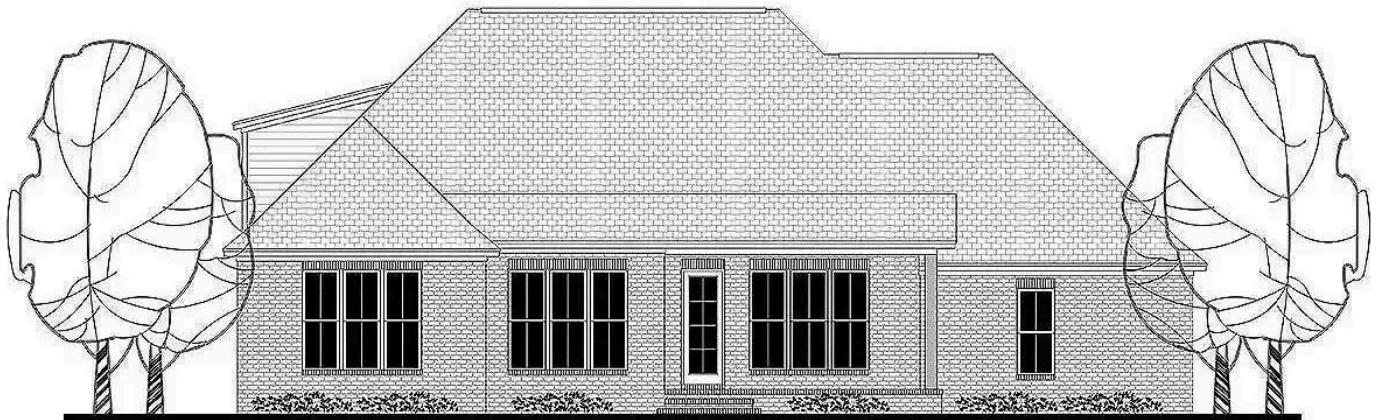

REAR ELEVATION

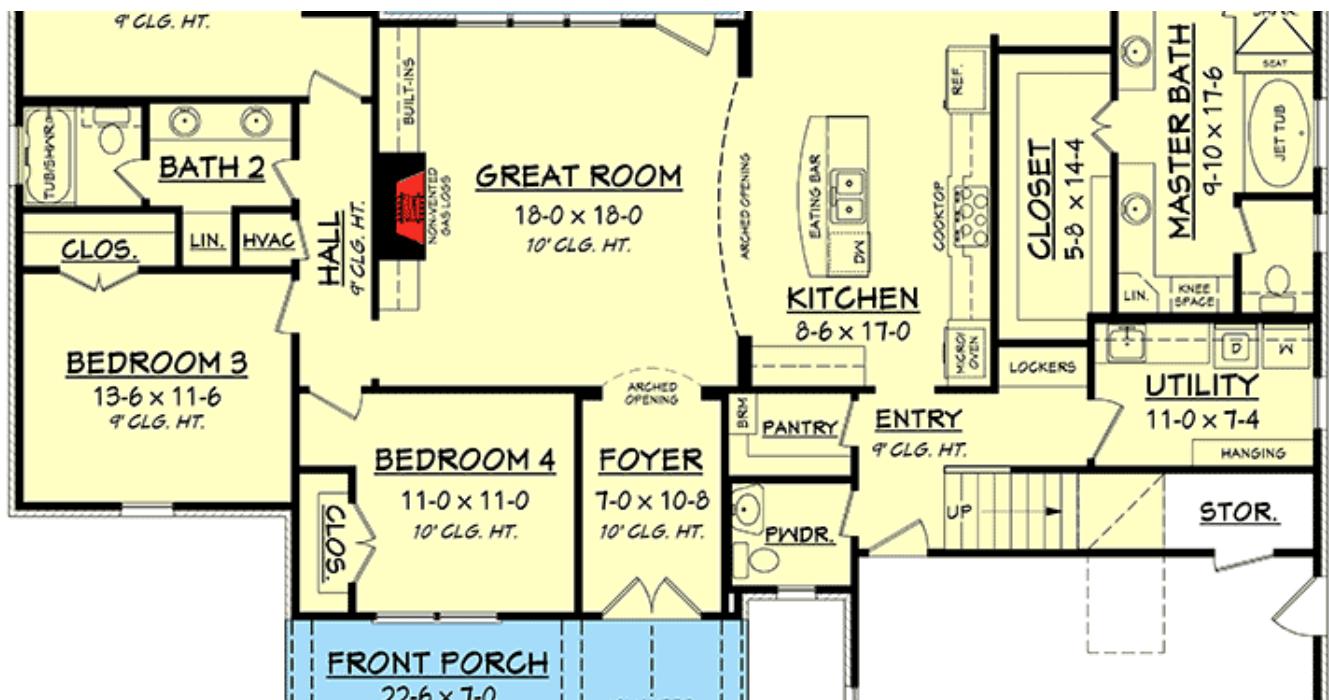

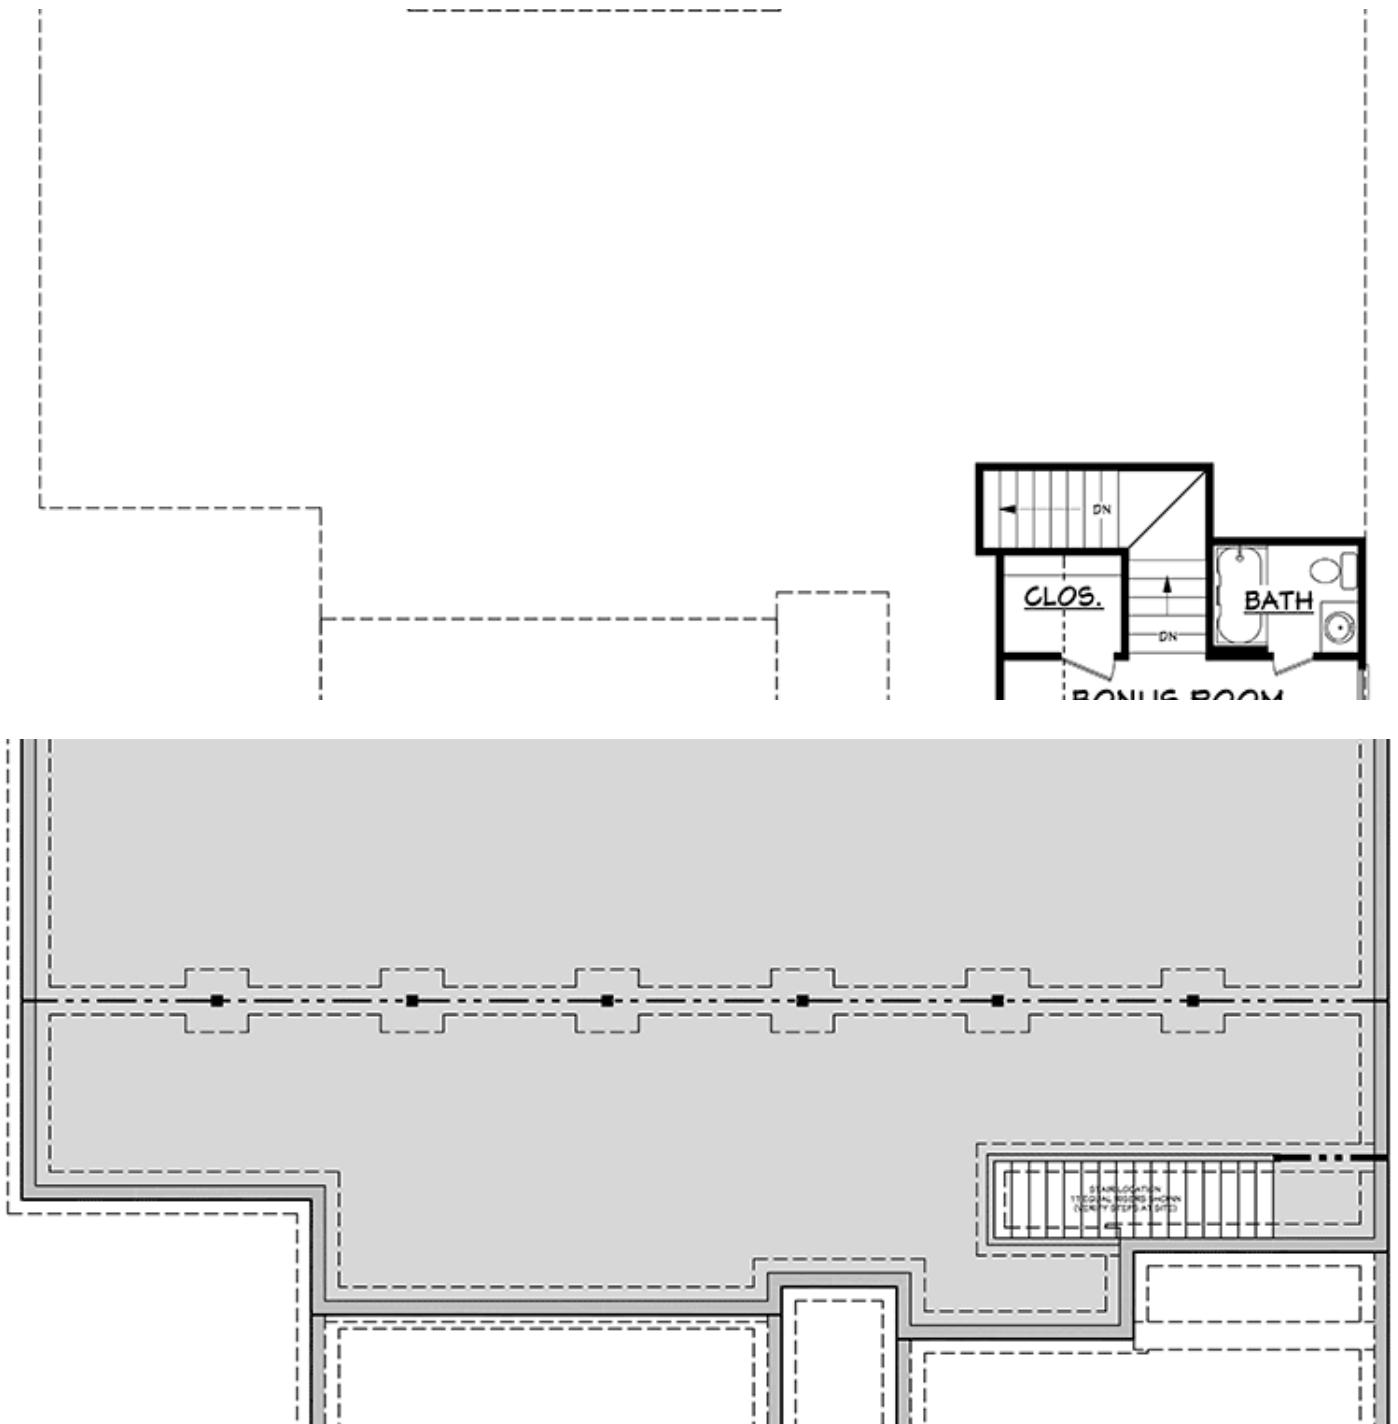

Plan 51750HZ
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4 Bed Craftsman with Open Concept Living Space and Bonus Room

2,329

Heated S.F.

4-5

Beds

2.5 - 3.5

Baths

1-2

Floors

2

Car Garage

Plan Details

Square Footage Breakdown

Total:	2,329 sq. ft.
1st Floor:	2,329 sq. ft.

Dimensions

Width:	65' 4"
Depth:	67' 8"

Beds/Baths

Bedrooms:	4 or 5
Full bathrooms:	2 or 3
Half bathrooms:	1

Garage

Type:	Attached
Area:	559 sq. ft.
Count:	2 Cars
Entry Location:	Front

Foundation Type

Standard Foundations:	Crawl, Slab
Optional Foundations:	Basement, Walkout

Exterior Walls

Standard Type(s):	2x4
Optional Type(s):	2x6

Ceiling Heights

Floor / Height:	Lower Level / 9' 4"	First Floor / 9' 0"	Second Floor / 8' 0"

Roof

Primary Pitch:	12 on 12
Secondary Pitch:	10 on 12
Framing Type:	Stick

Build Gallery

See and hear from existing customers with real photos, videos, and reviews.

House Plan 51750HZ comes to life in Indiana

18**Photos**

(/house-plans/4-bed-craftsman-with-open-concept-living-space-and-bonus-room-51750hz/client_photo_albums/519)

Plan 51750HZ
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