

**LAMPERT ARCHITECTS**

420 Summit Avenue  
St. Paul, MN 55102  
Phone: 763.755.1211 Fax: 763.757.2849  
lampert@lampert-arch.com

ARCHITECT CERTIFICATION:  
I HEREBY CERTIFY THAT THIS PLAN, SPECIFICATION OR REPORT WAS PREPARED BY ME OR UNDER MY DIRECT SUPERVISION AND THAT I AM A DULY LICENSED ARCHITECT UNDER THE LAWS OF THE STATE OF MINNESOTA.

*Leonard Lampert*  
SIGNATURE

LEONARD LAMPERT  
PRINT NAME

13669  
LICENSE NO.

12/29/20  
DATE

DATE

**BUNKER LAKE INDUSTRIAL PARK BUILDING #4**  
Ramsey, Minnesota

Copyright 2020 Leonard Lampert Architects Inc.

Project Designer: JAMES B

Drawn By: JRB

Checked By: LL

Revisions

5/30/19	PRELIMINARY
2/5/20	FINAL REVIEW
12/29/20	ISSUE FOR PERMIT


**BUILDING ELEVATIONS**

Sheet Number


**A5**

Project No. 180510-1


Filename: BUNKER LAKE INDUSTRIAL PARK BUILDING #4\BUNKER LAKE #4-A5

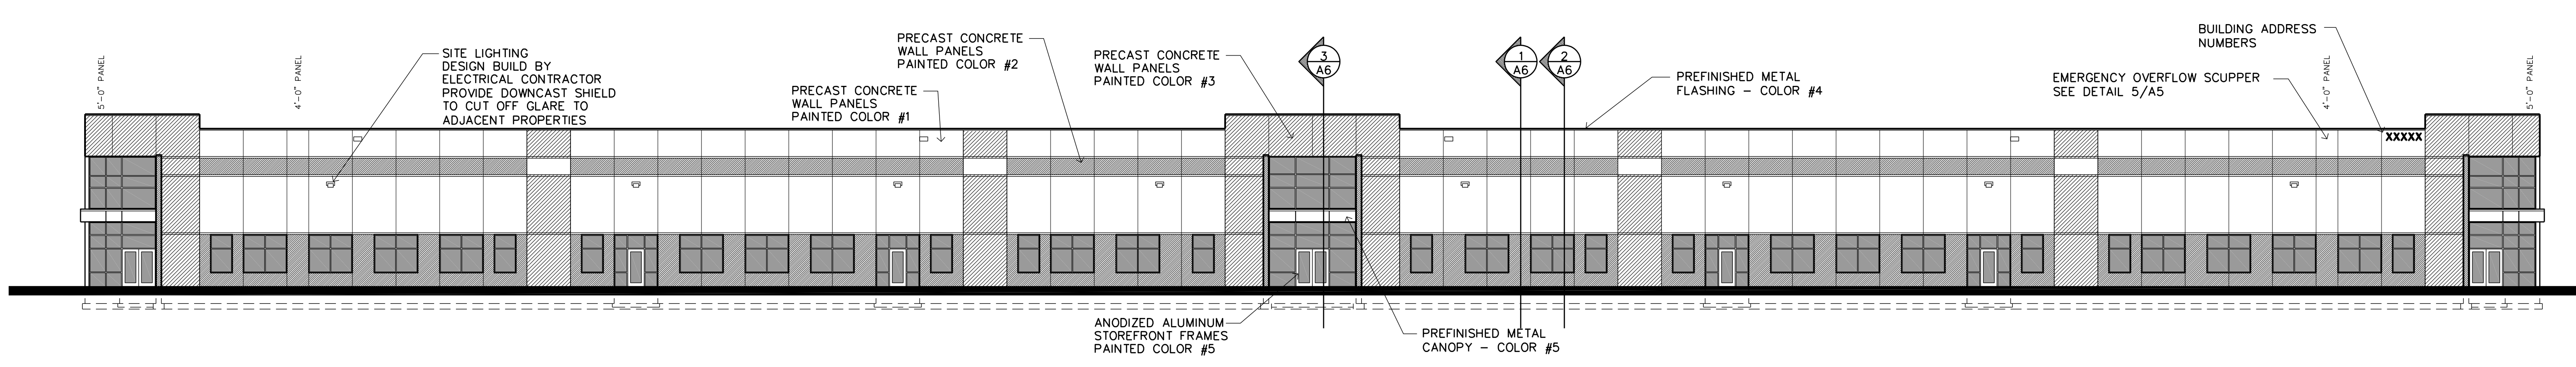


**1 NORTH ELEVATION**  
SCALE: 1/16" = 1'-0"

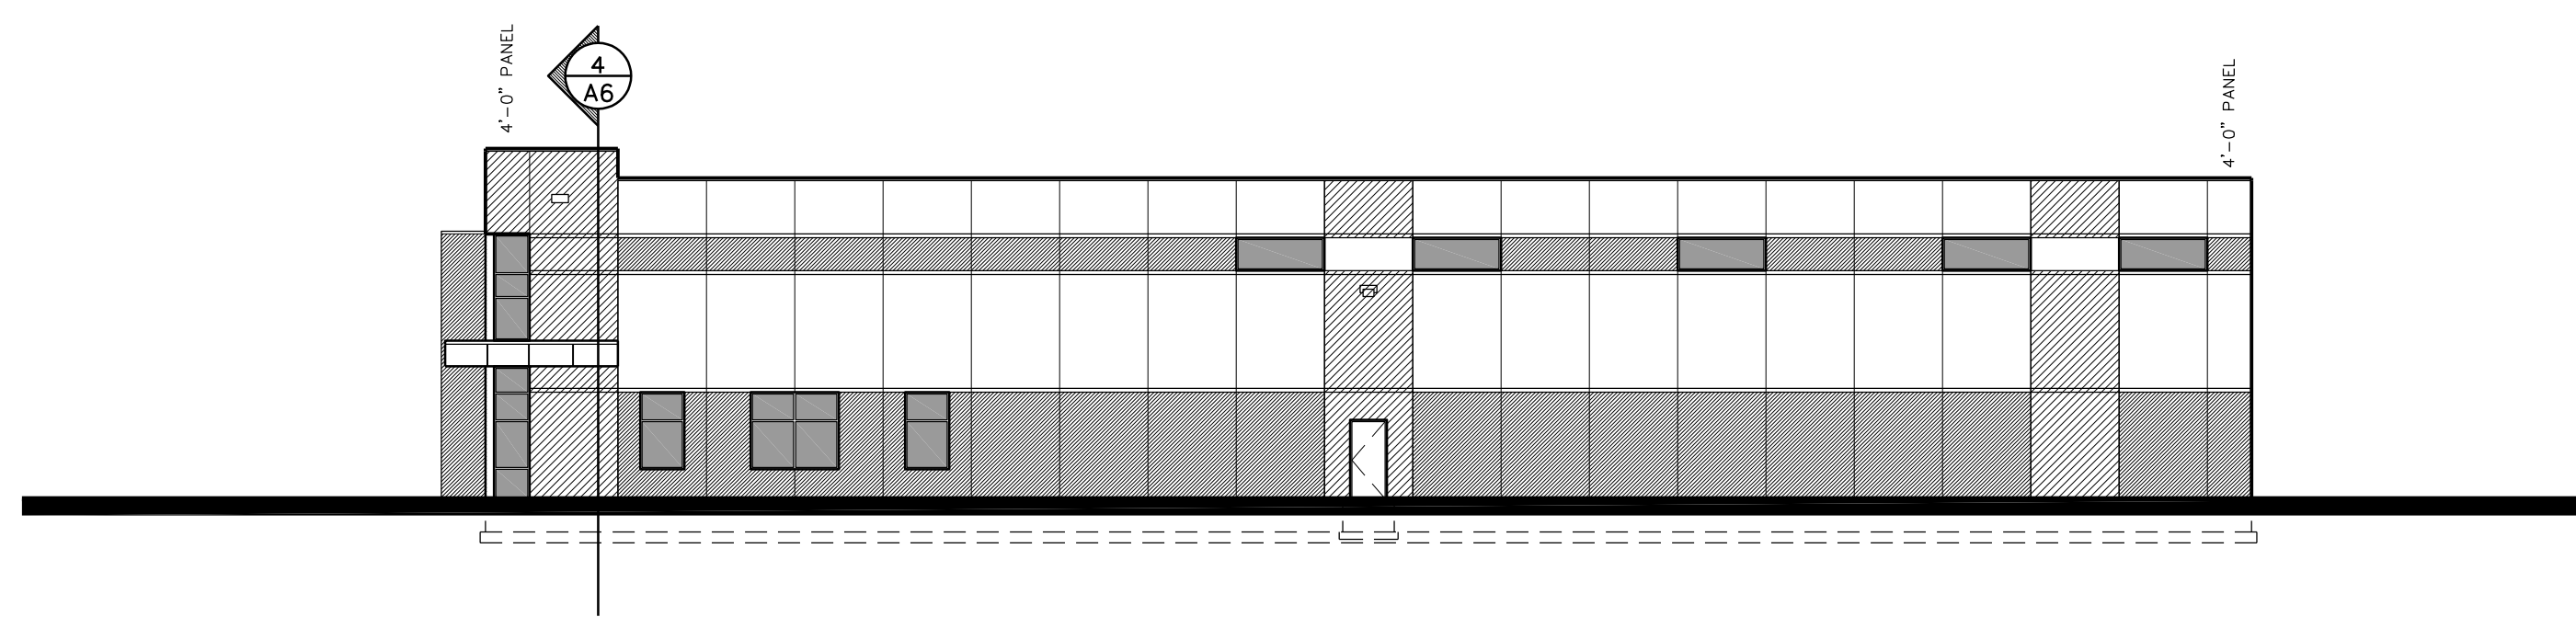


**2 WEST ELEVATION**  
SCALE: 1/16" = 1'-0"

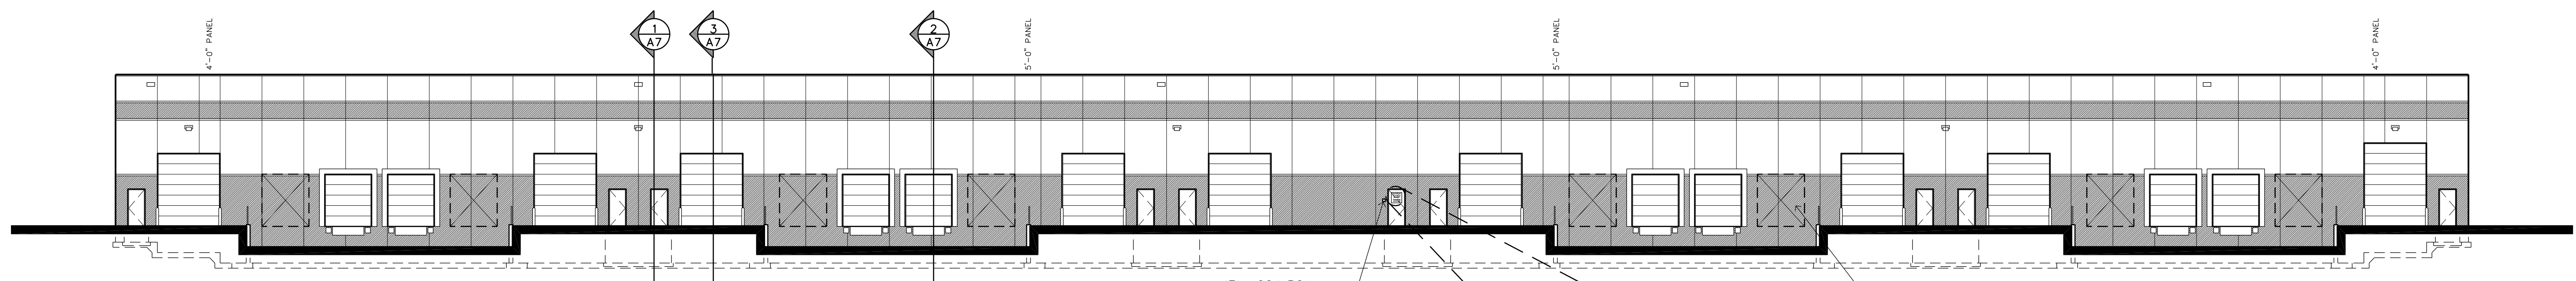

**3 SOUTH ELEVATION**  
SCALE: 1/16" = 1'-0"

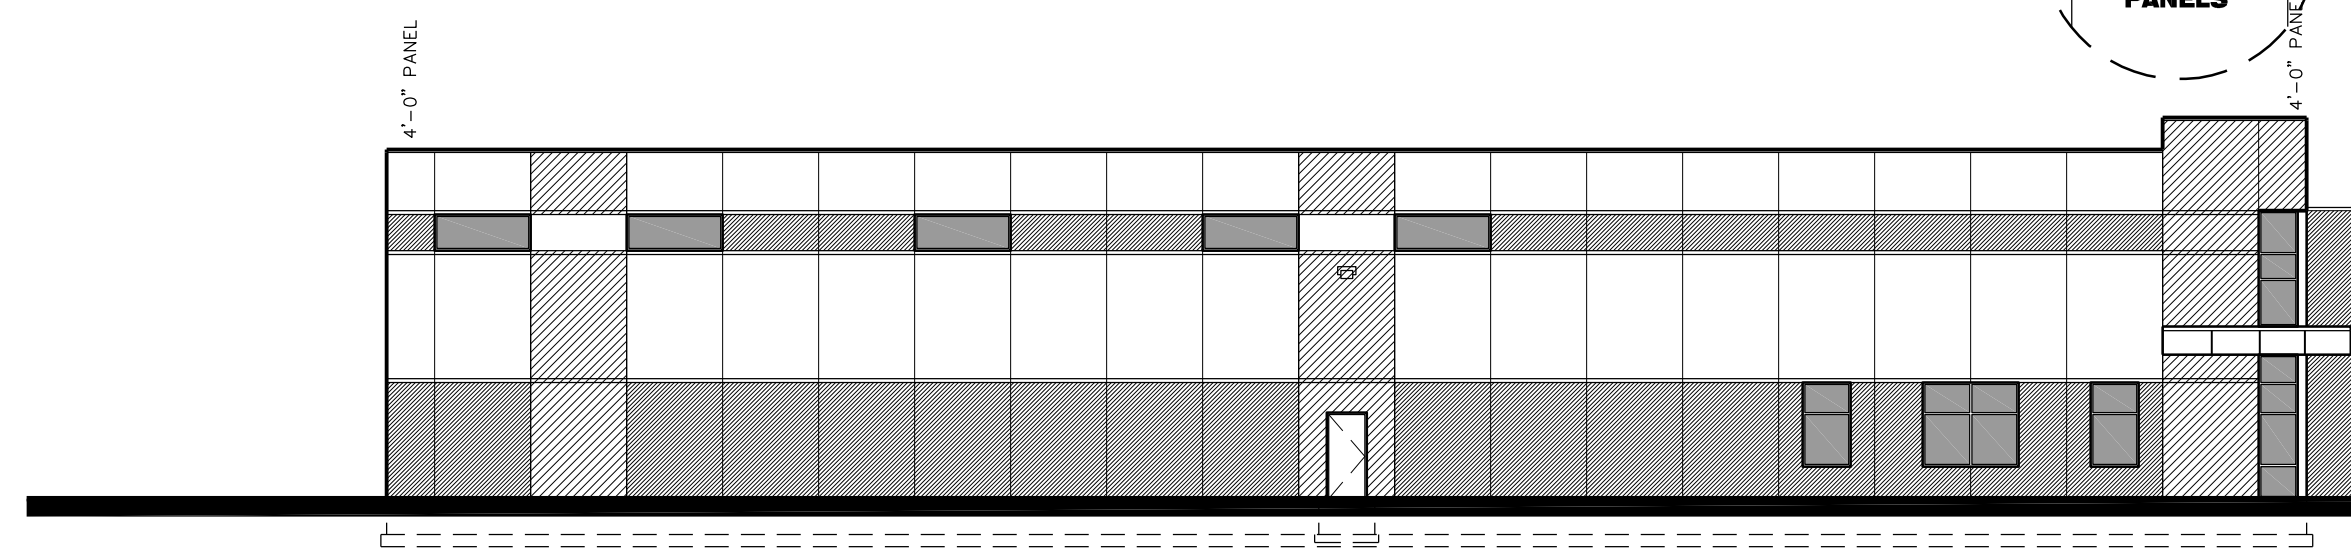

**4 EAST ELEVATION**  
SCALE: 1/16" = 1'-0"

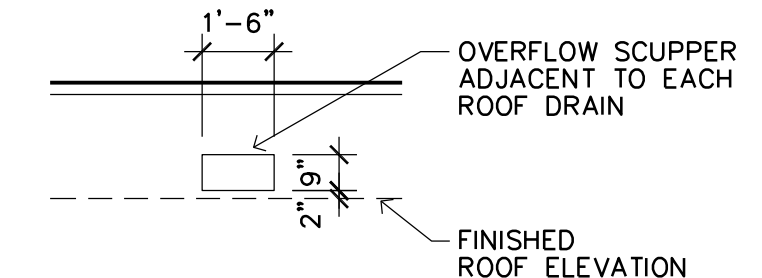

NOTE: OVERFLOW SCUPPER IS SIZED TO BE 3X THE AREA OF THE MAXIMUM VERTICAL LEADER SIZE ASSUMED TO BE 8" DIAMETER. VERIFY WITH THE PLUMBING DESIGNER AND INT'L PLUMBING CODE

**5 OVERFLOW SCUPPER DETAIL**  
SCALE: 1/4" = 1'-0"

TOP OF PRECAST (ENTRY)  
EL. = 131'-6"  
TOP OF PRECAST (TYP)  
EL. = 128'-10"

FINISHED FLOOR  
EL. = 100'-0"  
TOP OF FOOTING  
EL. = 97'-0"