

LAMPERT ARCHITECTS

420 Summit Avenue
St. Paul, MN 55102
Phone: 763.755.1211 Fax: 763.757.2849
lampert@lampert-arch.com

ARCHITECT CERTIFICATION:
I HEREBY CERTIFY THAT THIS PLAN, SPECIFICATION OR REPORT WAS PREPARED BY ME OR UNDER MY DIRECT SUPERVISION AND THAT I AM A DULY LICENSED ARCHITECT UNDER THE LAWS OF THE STATE OF MINNESOTA.

Signature: Leonard Lampert
PRINT NAME: LEONARD LAMPERT
13669
LICENSE NO.
2/6/23
DATE

BUNKER LAKE INDUSTRIAL PARK
BUILDING #5
Ramsey, Minnesota

Copyright 2023
Leonard Lampert Architects Inc.

Project Designer: JAMES B

Drawn By: JRB

Checked By: LL

Revisions

12/20/22 PRELIMINARY

1/10/23 FINAL REVIEW

2/6/23 ISSUE FOR PERMIT

BUILDING ELEVATIONS


Sheet Number

A4


Project No. 220506-1

TOP OF PRECAST (ENTRY)
EL. = 136'-0"
TOP OF PRECAST (TYP)
EL. = 133'-0"
CLEAR HEIGHT
EL. = 128'-0"


FINISHED FLOOR
EL. = 100'-0"
TOP OF FOOTING
EL. = 97'-0"

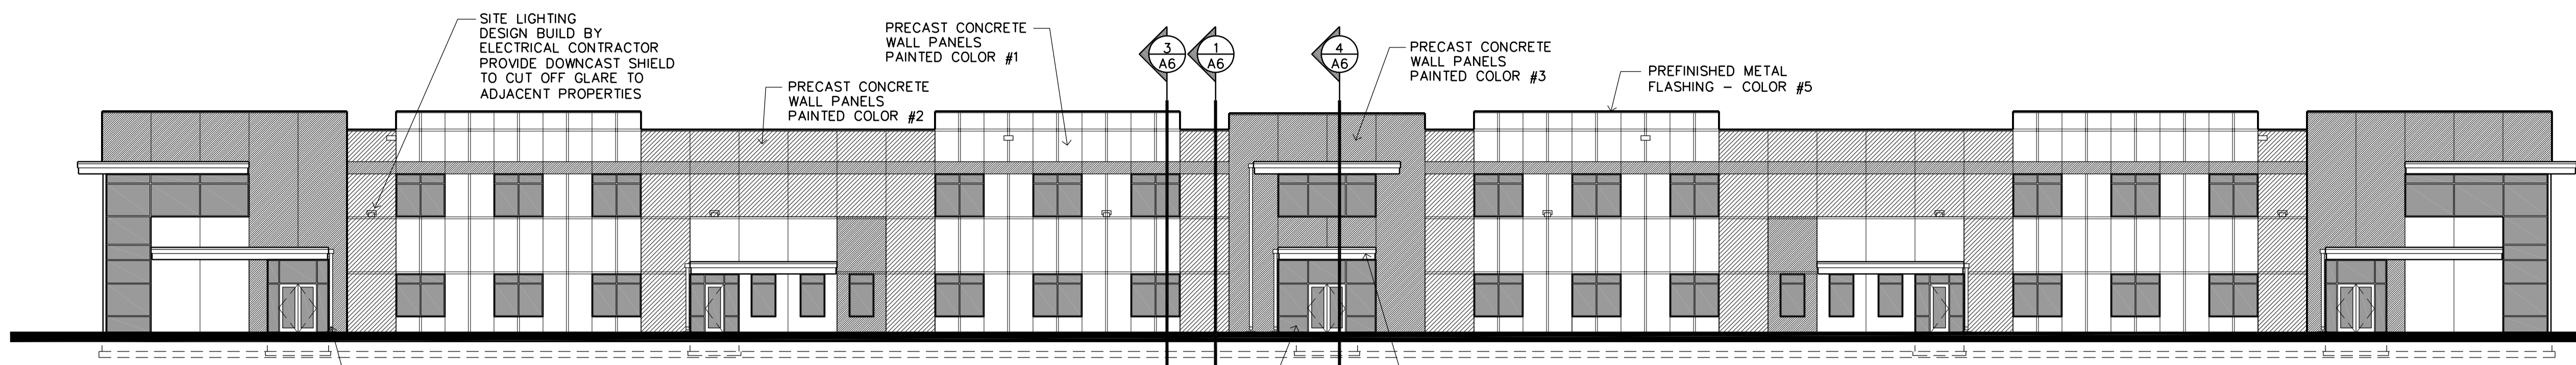


1 EAST ELEVATION
A4 SCALE: 1/16" = 1'-0"

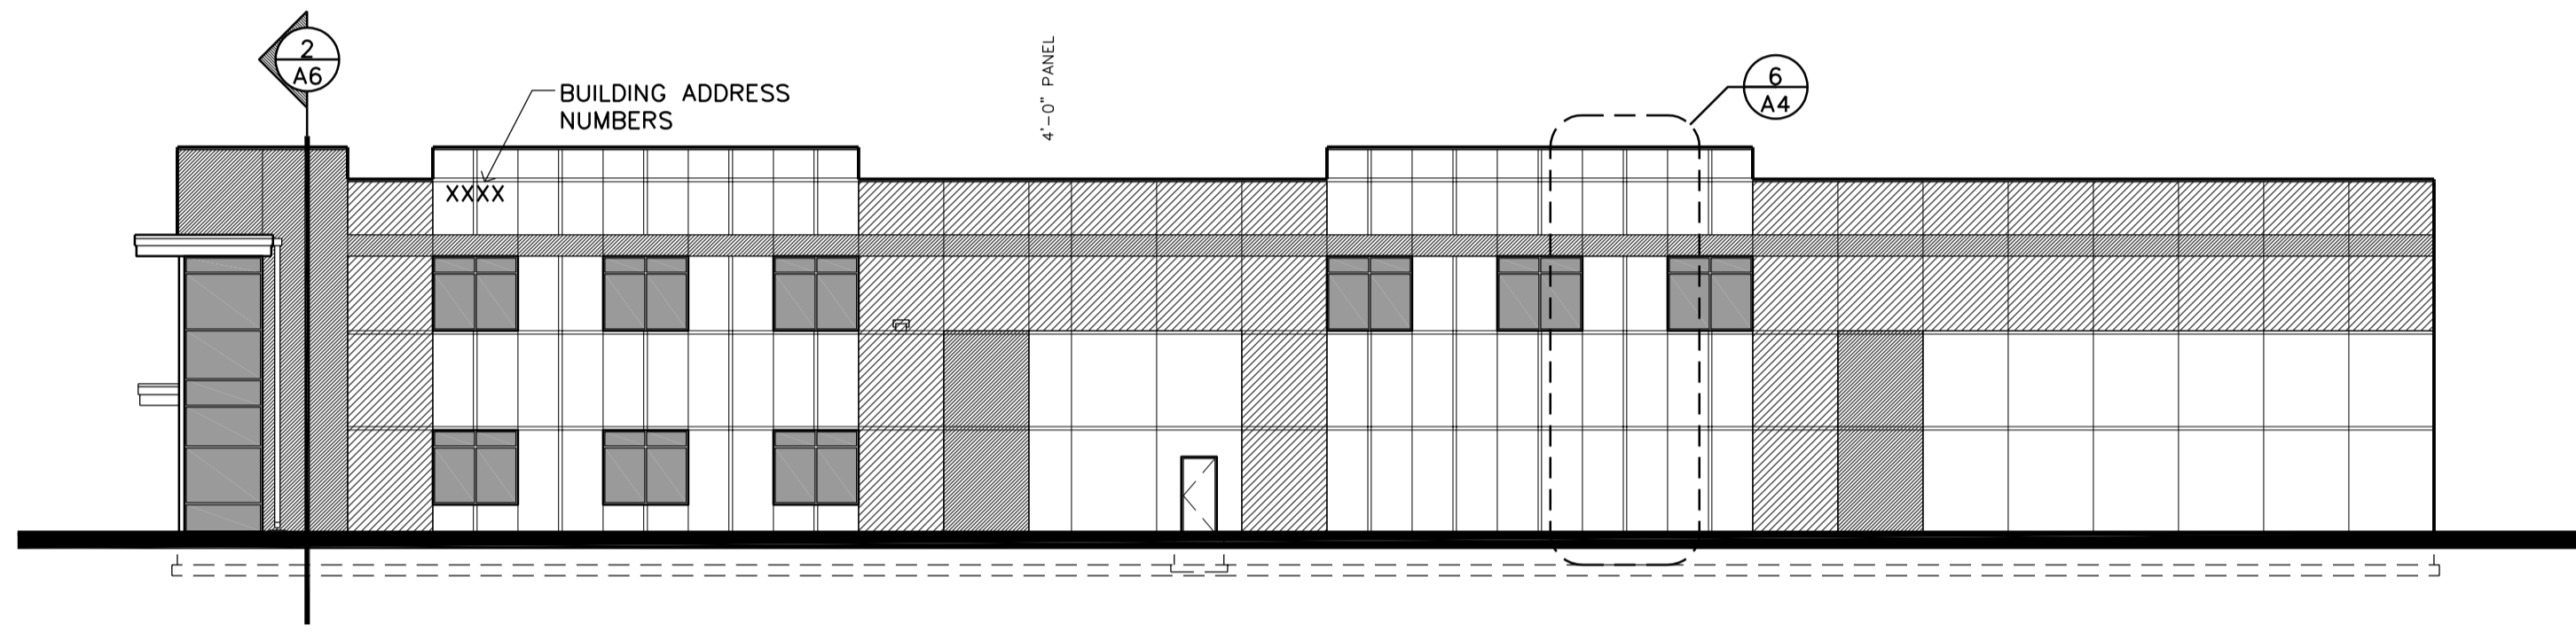


2 NORTH ELEVATION
A4 SCALE: 1/16" = 1'-0"

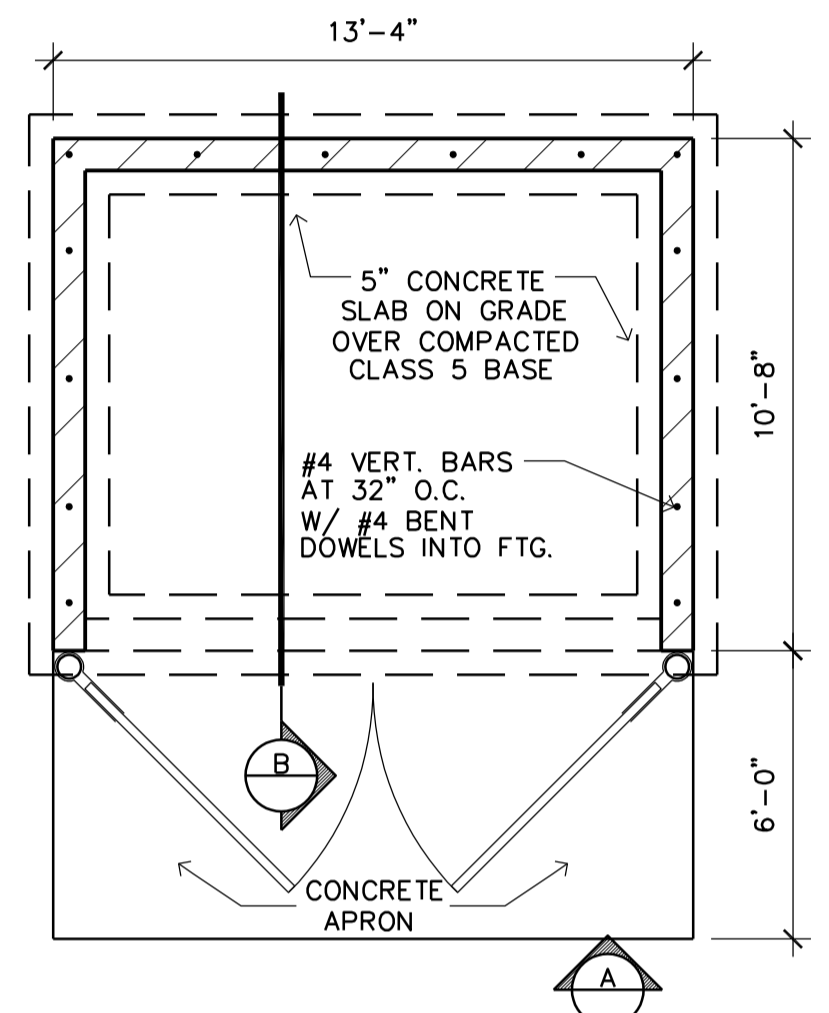


7 TRASH ENCLOSURE
A4 SCALE: 1/4" = 1'-0"

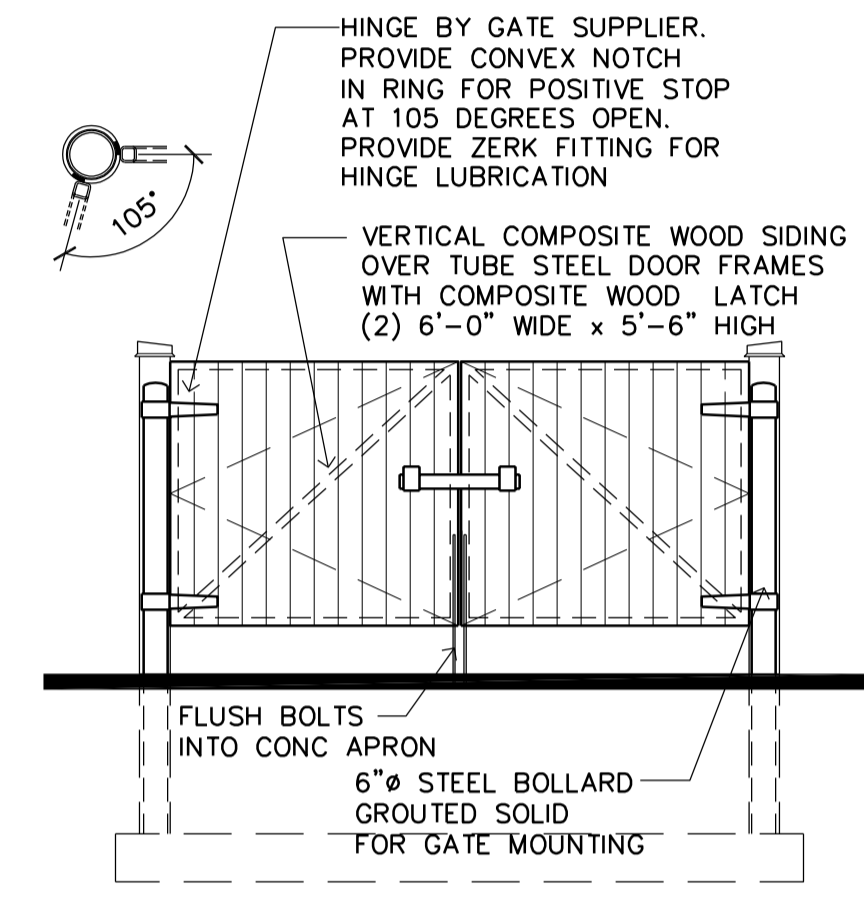


ELEVATION 'A'

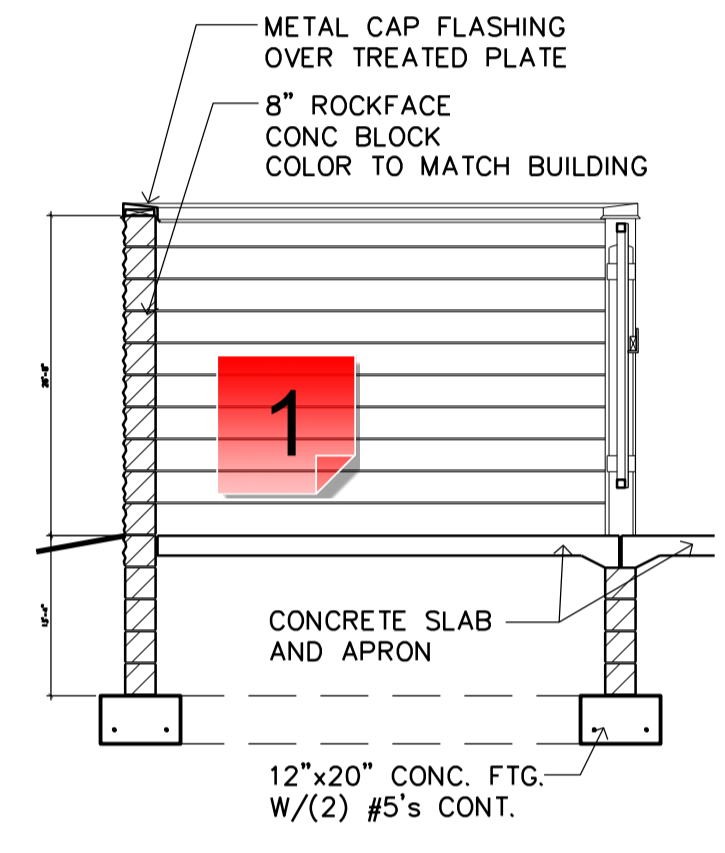


SECTION 'B'

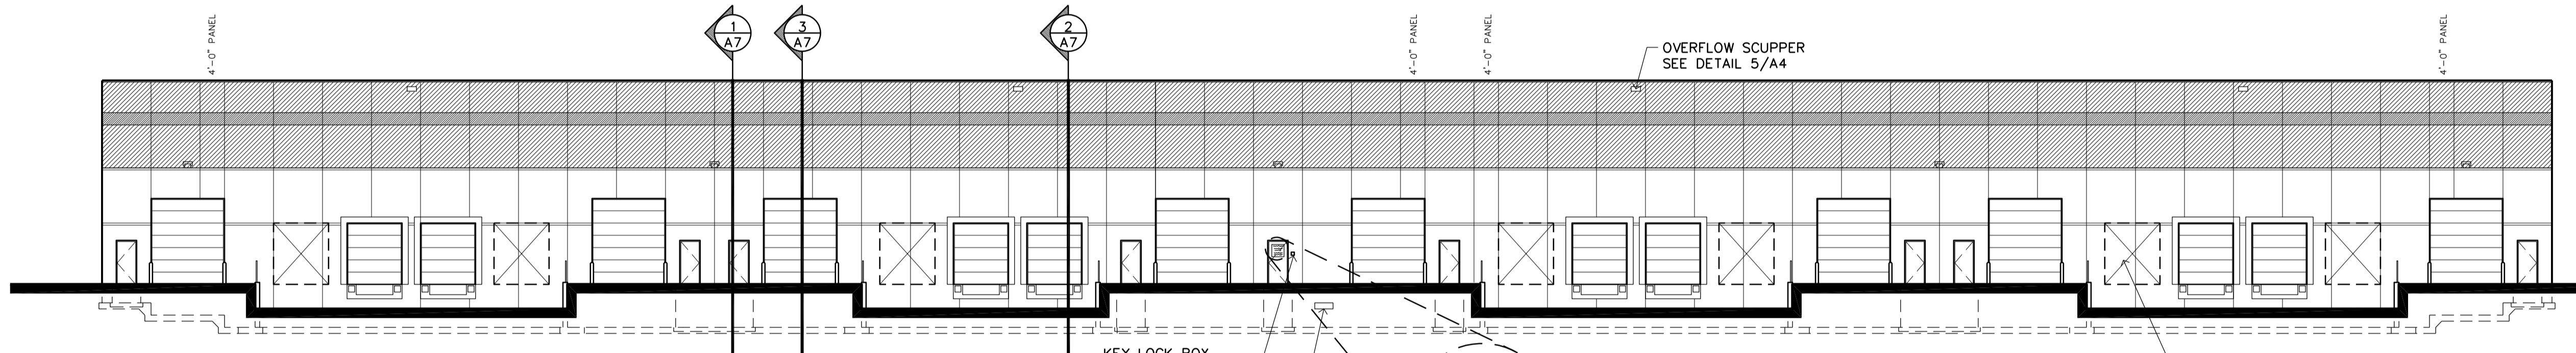


3 WEST ELEVATION
A4 SCALE: 1/16" = 1'-0"

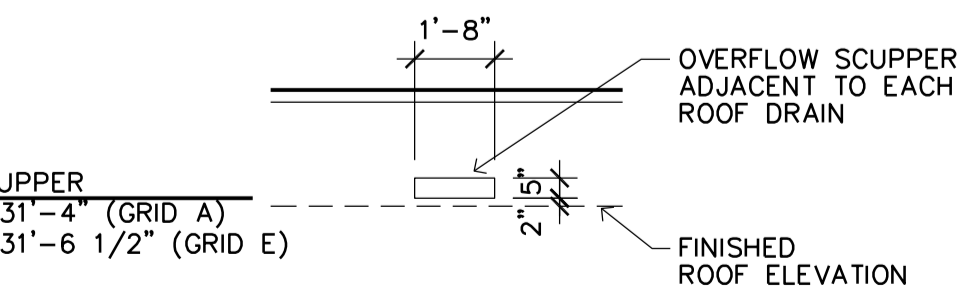

5 OVERFLOW SCUPPER DETAIL
A4 SCALE: 1/4" = 1'-0"

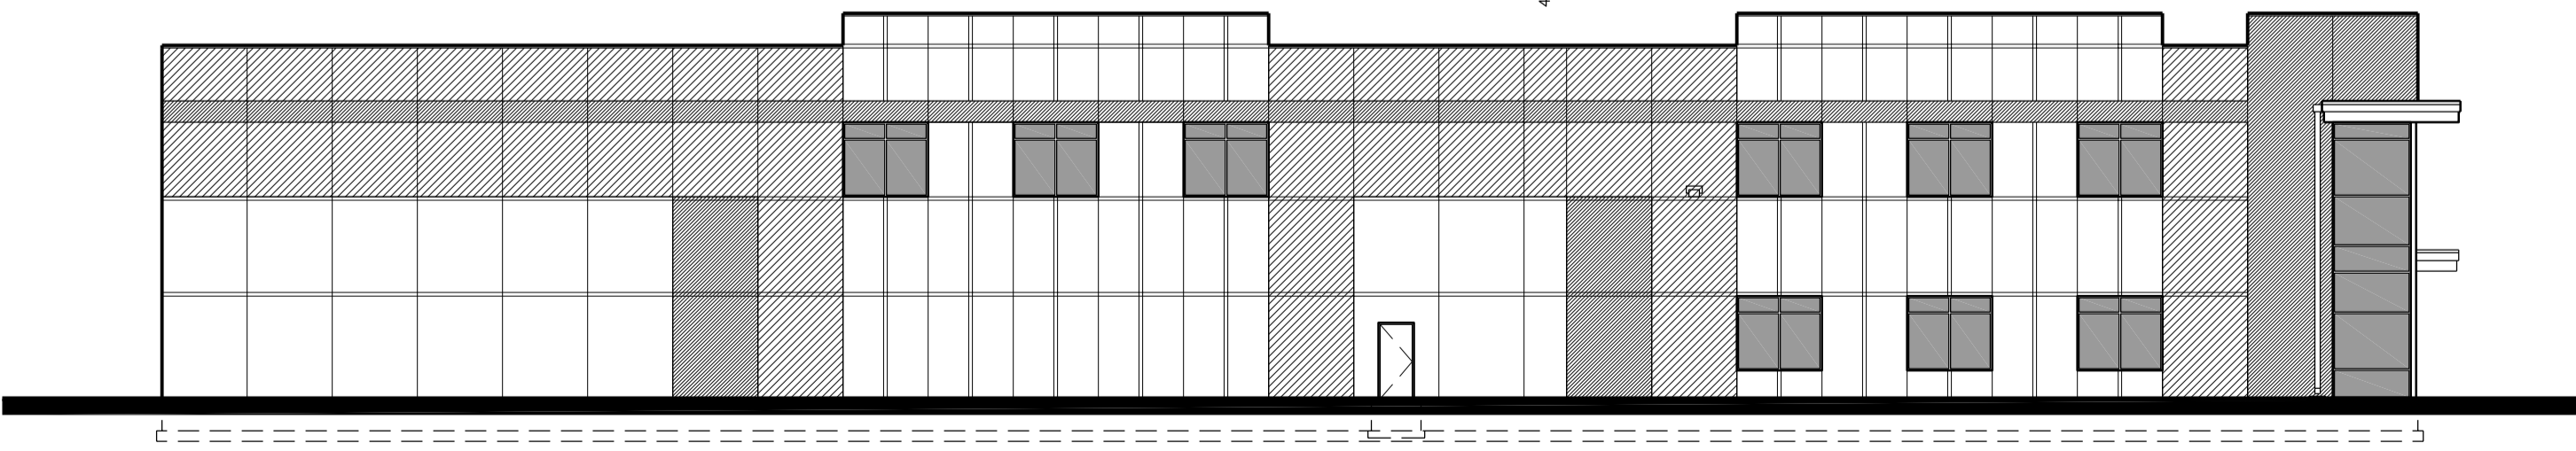

4 SOUTH ELEVATION
A4 SCALE: 1/16" = 1'-0"

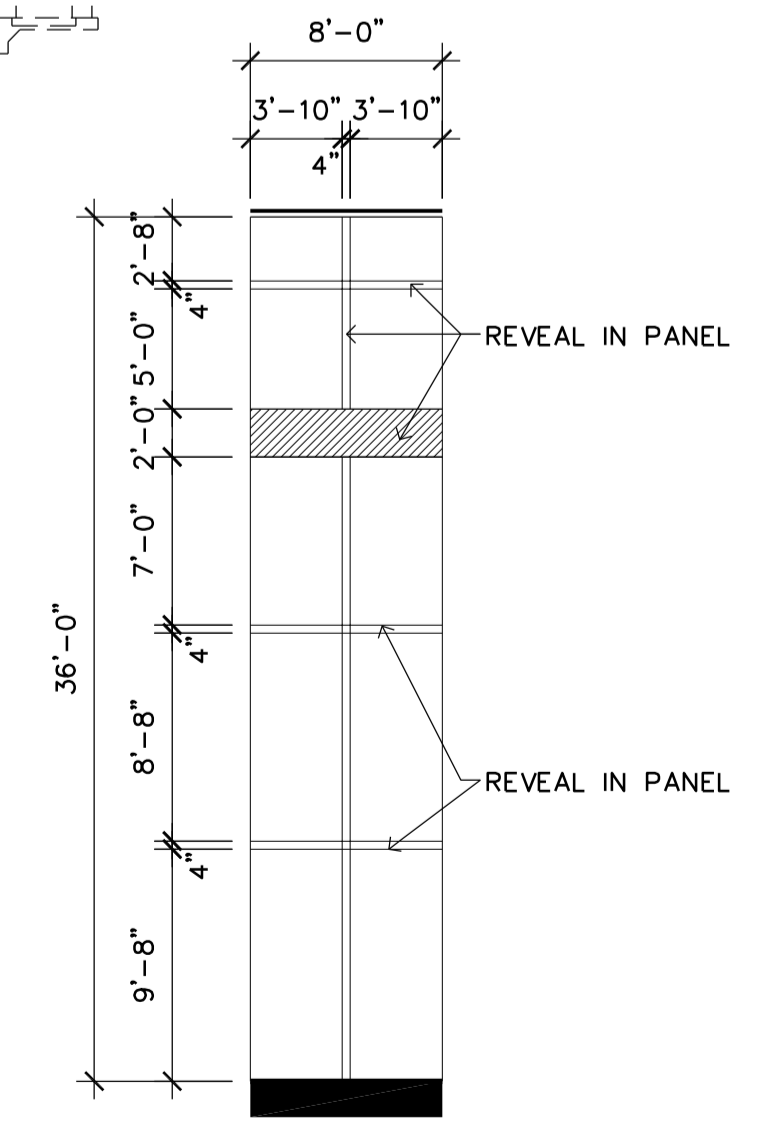

6 PRECAST PANEL DETAIL
A4 SCALE: 1/8" = 1'-0"

NOTE: OVERFLOW SCUPPER IS SIZED ACCORDING TO IBC 1502.2.3 LEADER SIZE ASSUMED TO BE 8" DIAMETER. VERIFY WITH THE PLUMBING DESIGNER AND INT'L PLUMBING CODE

Filename: BUNKER LAKE INDUSTRIAL PARK\BUILDING #5\BUNKER LAKE #5-A4

1 - Material?

Created by: Chris Anderson
On: 05/16/2023 11:36 AM

What is this material?

----- 0 Replies -----