

GENERAL NOTES

DO NOT SCALE DRAWINGS. ANY CONFLICTS OR MISSING INFORMATION SHOULD BE BROUGHT TO THE ATTENTION OF THE BUILDER AND/OR DESIGNER. THIS PROJECT WAS DESIGNED IN ACCORDANCE WITH THE 2020 MINNESOTA RESIDENTIAL CODE, 2020 MINNESOTA ENERGY CODE AND 2020 MEC RE: STRUCTURAL FOR ALL LOADS AND HEADER SIZES

INTERIOR CONSTRUCTION

WALLS:
ALL ANGLED WALLS ARE 45° U.N.O.
PROVIDE 5/8" TYPE "X" GYPSUM BOARD AT ALL USABLE AREAS UNDERNEATH STAIRS
BARTOP TOP PLATE TO BE @ 34 1/2" A.F.F.
CEILING:
CATHEDRAL CEILING BEAM TO BE FURRED OUT TO 6" WIDE
DOORS:
ALL SHEETROCK ARCHES (SRA) AS FOLLOWS:
BOT OF ARCH @ 82" A.F.F. WITH TOP OF ARCH @ 92" A.F.F.
INTERIOR DOORS TO BE TWO PANEL COLONIAL INTERIOR PASSAGE DOORS
HEADER HEIGHT FOR GARAGE OHD TO BE @ 85 1/4"
HEADER HEIGHT FOR GARAGE ENTRY DOOR TO BE @ 81 1/2"
DOOR CONNECTING GARAGE AND HOUSE TO BE SELF CLOSING 1 3/8" THICK STEEL, INSULATED, 20 MINUTE FIRE RATED, GASKET AND SEALED PER LOCAL CODES
SRO (SHEET ROCK OPENINGS) AND SRA (SHEETROCK ARCHES):
REFER TO FLOOR PLANS FOR ALL SRO AND SRA WIDTHS
ALL SRO AND SRA HEIGHTS TO BE 12" BELOW SPECIFIED CEILING
WINDOWS: R1C310
PROVIDE 1/2" ADDITIONAL ROUGH OPENING HEIGHT AT ALL WINDOWS
DEFINITION OF WINDOW TAG EXAMPLED: 3050 SH DL @ 6'-8" HEADER HEIGHT = 36" X 60" SINGLE HUNG DIVIDED LITE @ 6'-8" A.F.F.
LIGHTING:
VANITY FIXTURES TO BE MOUNTED @ 87" A.F.F. TO THE CENTERLINE
COACH LIGHTS TO BE MOUNTED 5'-10" A.F.F. TO THE CENTERLINE
CABINETS:
KITCHEN AND UTILITY CABINETS, COUNTERTOP @ 36"
BATHROOM CABINETS, COUNTERTOP @ 34"
PROVIDE CROWN MOULDING AS SPECIFIED @ KITCHEN WALL CABINETS
GARAGE:
PROVIDE 5/8" TYPE "X" GYPSUM BOARD ON ALL WALLS AND CEILING.
SLOPE FLOOR, FULL WIDTH, 1% FROM REAR WALL TO OHD, U.N.O.
STAIRS: R1C311.5
STAIR WIDTH SHALL BE NO LESS THAN 36"
ALL RISERS TO BE 7 3/4" MAX AND MAY NOT VARY MORE THAN 3/8" IN HEIGHT
ALL TREADS TO BE NO LESS THAN 10"
HANDRAIL SHALL BE PROVIDED ON AT LEAST ONE SIDE OF EACH CONTINUOUS RUN OF TREADS OR FLIGHT WITH FOUR OR MORE RISERS AT NO LESS THAN 34" OR MORE THAN 38" A.F.F.
EXTERIOR CONSTRUCTION
STONE VENEER:
THIN SET STONE, VENEER OR PANELIZED REPLICA STONE, STACK NATURALLY AND CONFORM WITH ALL STANDARD INDUSTRY PRACTICES AND ALL APPLICABLE IRC CODES
WALLS:
ALL EXTERIOR WALLS TO BE 2X6 STUDS, UNLESS NOTED OTHERWISE
PORCHES:
ALL PORCHES AND PATIO SOFFITS TO BE VINYL AND MATCH SOFFIT MATERIAL AT EAVES
ROOFS:
TERMINATION OF FASCIA AT GABLES WILL BE HELD 1 INCH OFF THE SHINGLES
EXIT DOORS:
INSTALL "Z" FLASHING OVER ALL EXPOSED EXTERIOR DOORS
ADDRESS BLOCK:
SHALL BE MOUNTED IN STONE WAINSCOT WITH TOP OF 36" A.F.F.
EXTEIOR TRIM:
ALL WINDOW AND DOOR TRIM TO BE 45 DEGREE MITER
SOFFITS:
SOFFITS AT ALL GABLES TO BE 12" VINYL
SOFFITS AT ALL HIPS TO BE 12" VINYL

CODE INFORMATION

CONSTRUCTION TYPE: 5B
OCCUPANCY: R3, U (garage)
2020 MINNESOTA RESIDENTIAL CODE
2020 MINNESOTA ENERGY CODE
2020 NEC

CONSULTANTS

DESIGNER
NASH AND ASSOCIATES ARCHITECTS
8003 118th AVE NE
KIRKLAND, WA 98033
PHONE: (425) 242-7490

STRUCTURAL ENGINEER
HANSON GROUP
3407 KILMER LANE N, SUITE #4
PLYMOUTH, MN 55441
PHONE: (612) 708-3572



AFTON PLAN

FLOOR AREAS

MAIN	636
UPPER	860
TOTAL	1496
GARAGE	403
COVERED	
PORCH	40

CAMDEN PLAN

FLOOR AREAS

MAIN	748
UPPER	1001
TOTAL	1749
GARAGE	404
COVERED	
PORCH	22

HAYES PLAN

FLOOR AREAS

MAIN	883
UPPER	1189
TOTAL	2072
GARAGE	401
COVERED	
PORCH	24

SHEET INDEX

C	- COVER SHEET
A1	- SLAB FOUNDATION (2)
A2	- MAIN FLOOR PLAN (2)
A3	- UPPER FLOOR PLAN (2)
A4	- FRONT AND REAR ELEVATION (2)
A5	- SIDE ELEVATIONS
A6	- ROOF PLAN
A7	- BUILDING SECTION
A8	- PARTY WALL DETAIL
A9	- ELECTRICAL PLAN (MAIN)
A10	- ELECTRICAL PLAN (UPPER)



5 UNIT BUILDING (CHP)



2850 CUTTERS
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ANOKA, MN 55303

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RIVENICK VILLAGE
5 UNIT BUILDING
RAMSEY, MINNESOTA


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permit:
revisions:
03-06-24
04-30-24
04-23-25

drawn by: MNJ
checked by:

SHEET


C

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ONE HOUR RATED PARTY WALL
D1
A-B

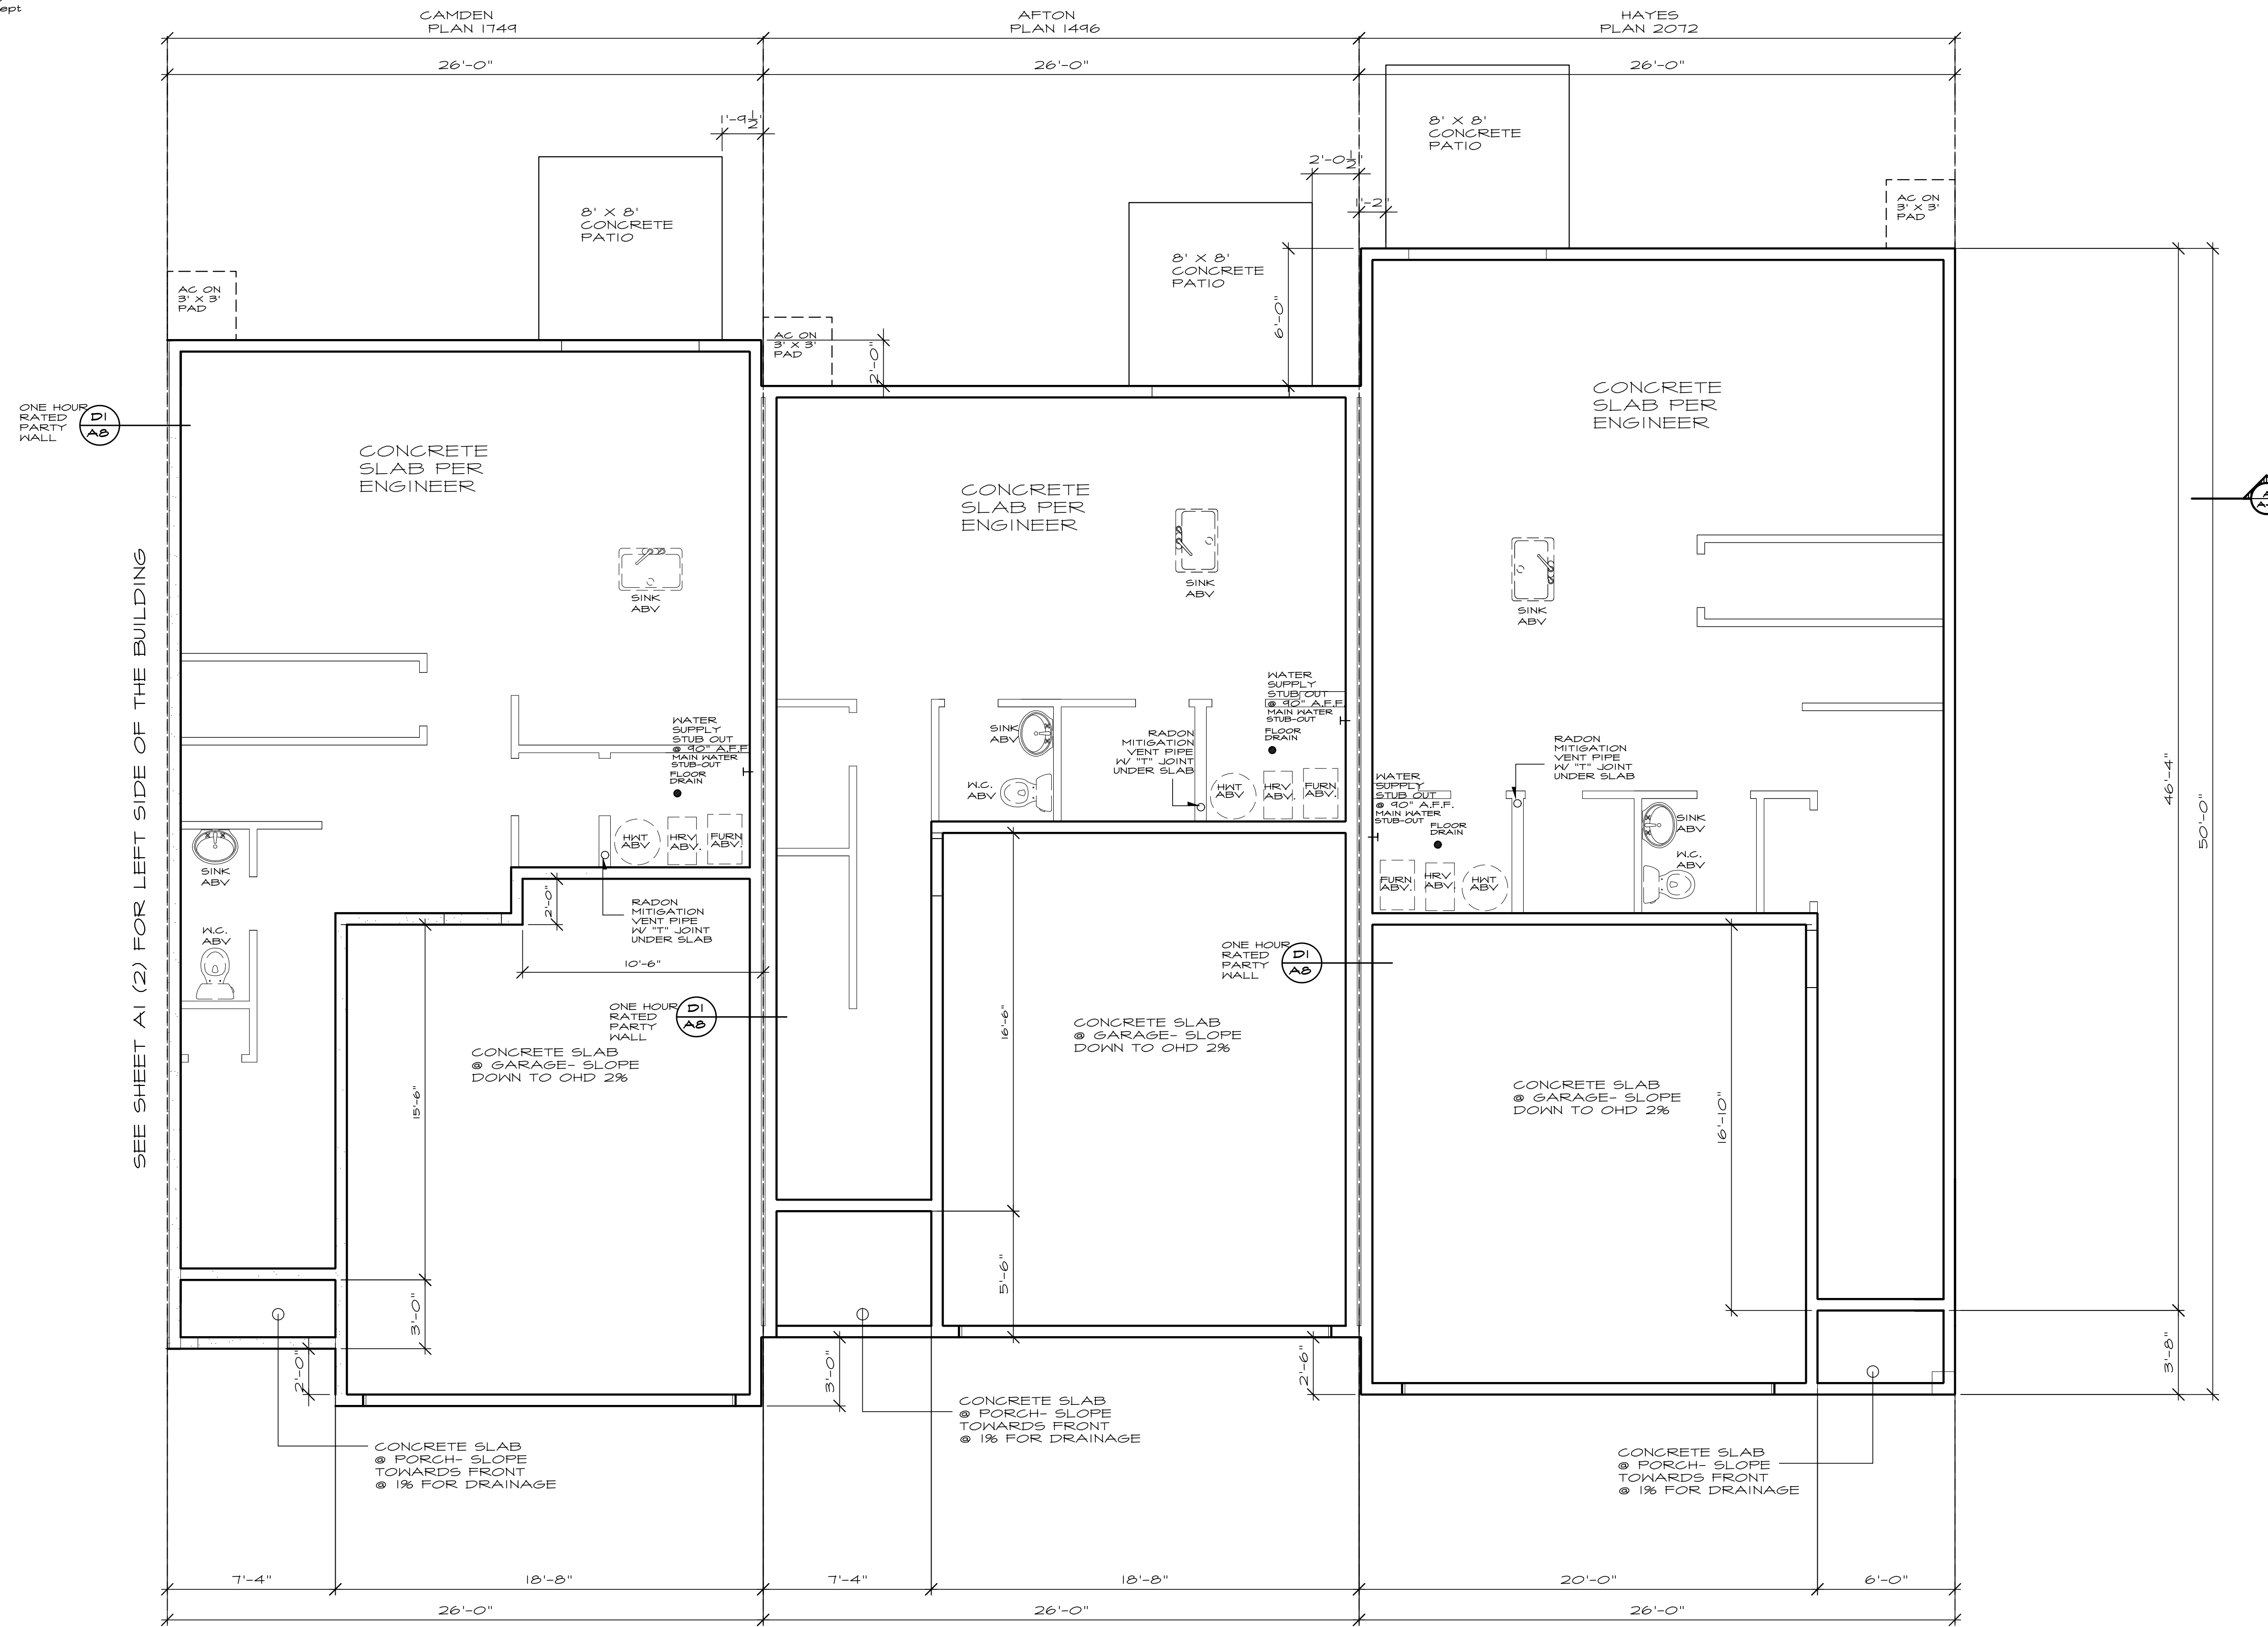SEE SHEET A1 (2) FOR LEFT SIDE OF THE BUILDING



SLAB FOUNDATION
SEE GENERAL NOTES
SCALE: 1/4" = 1'-0"

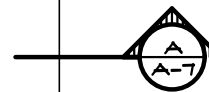

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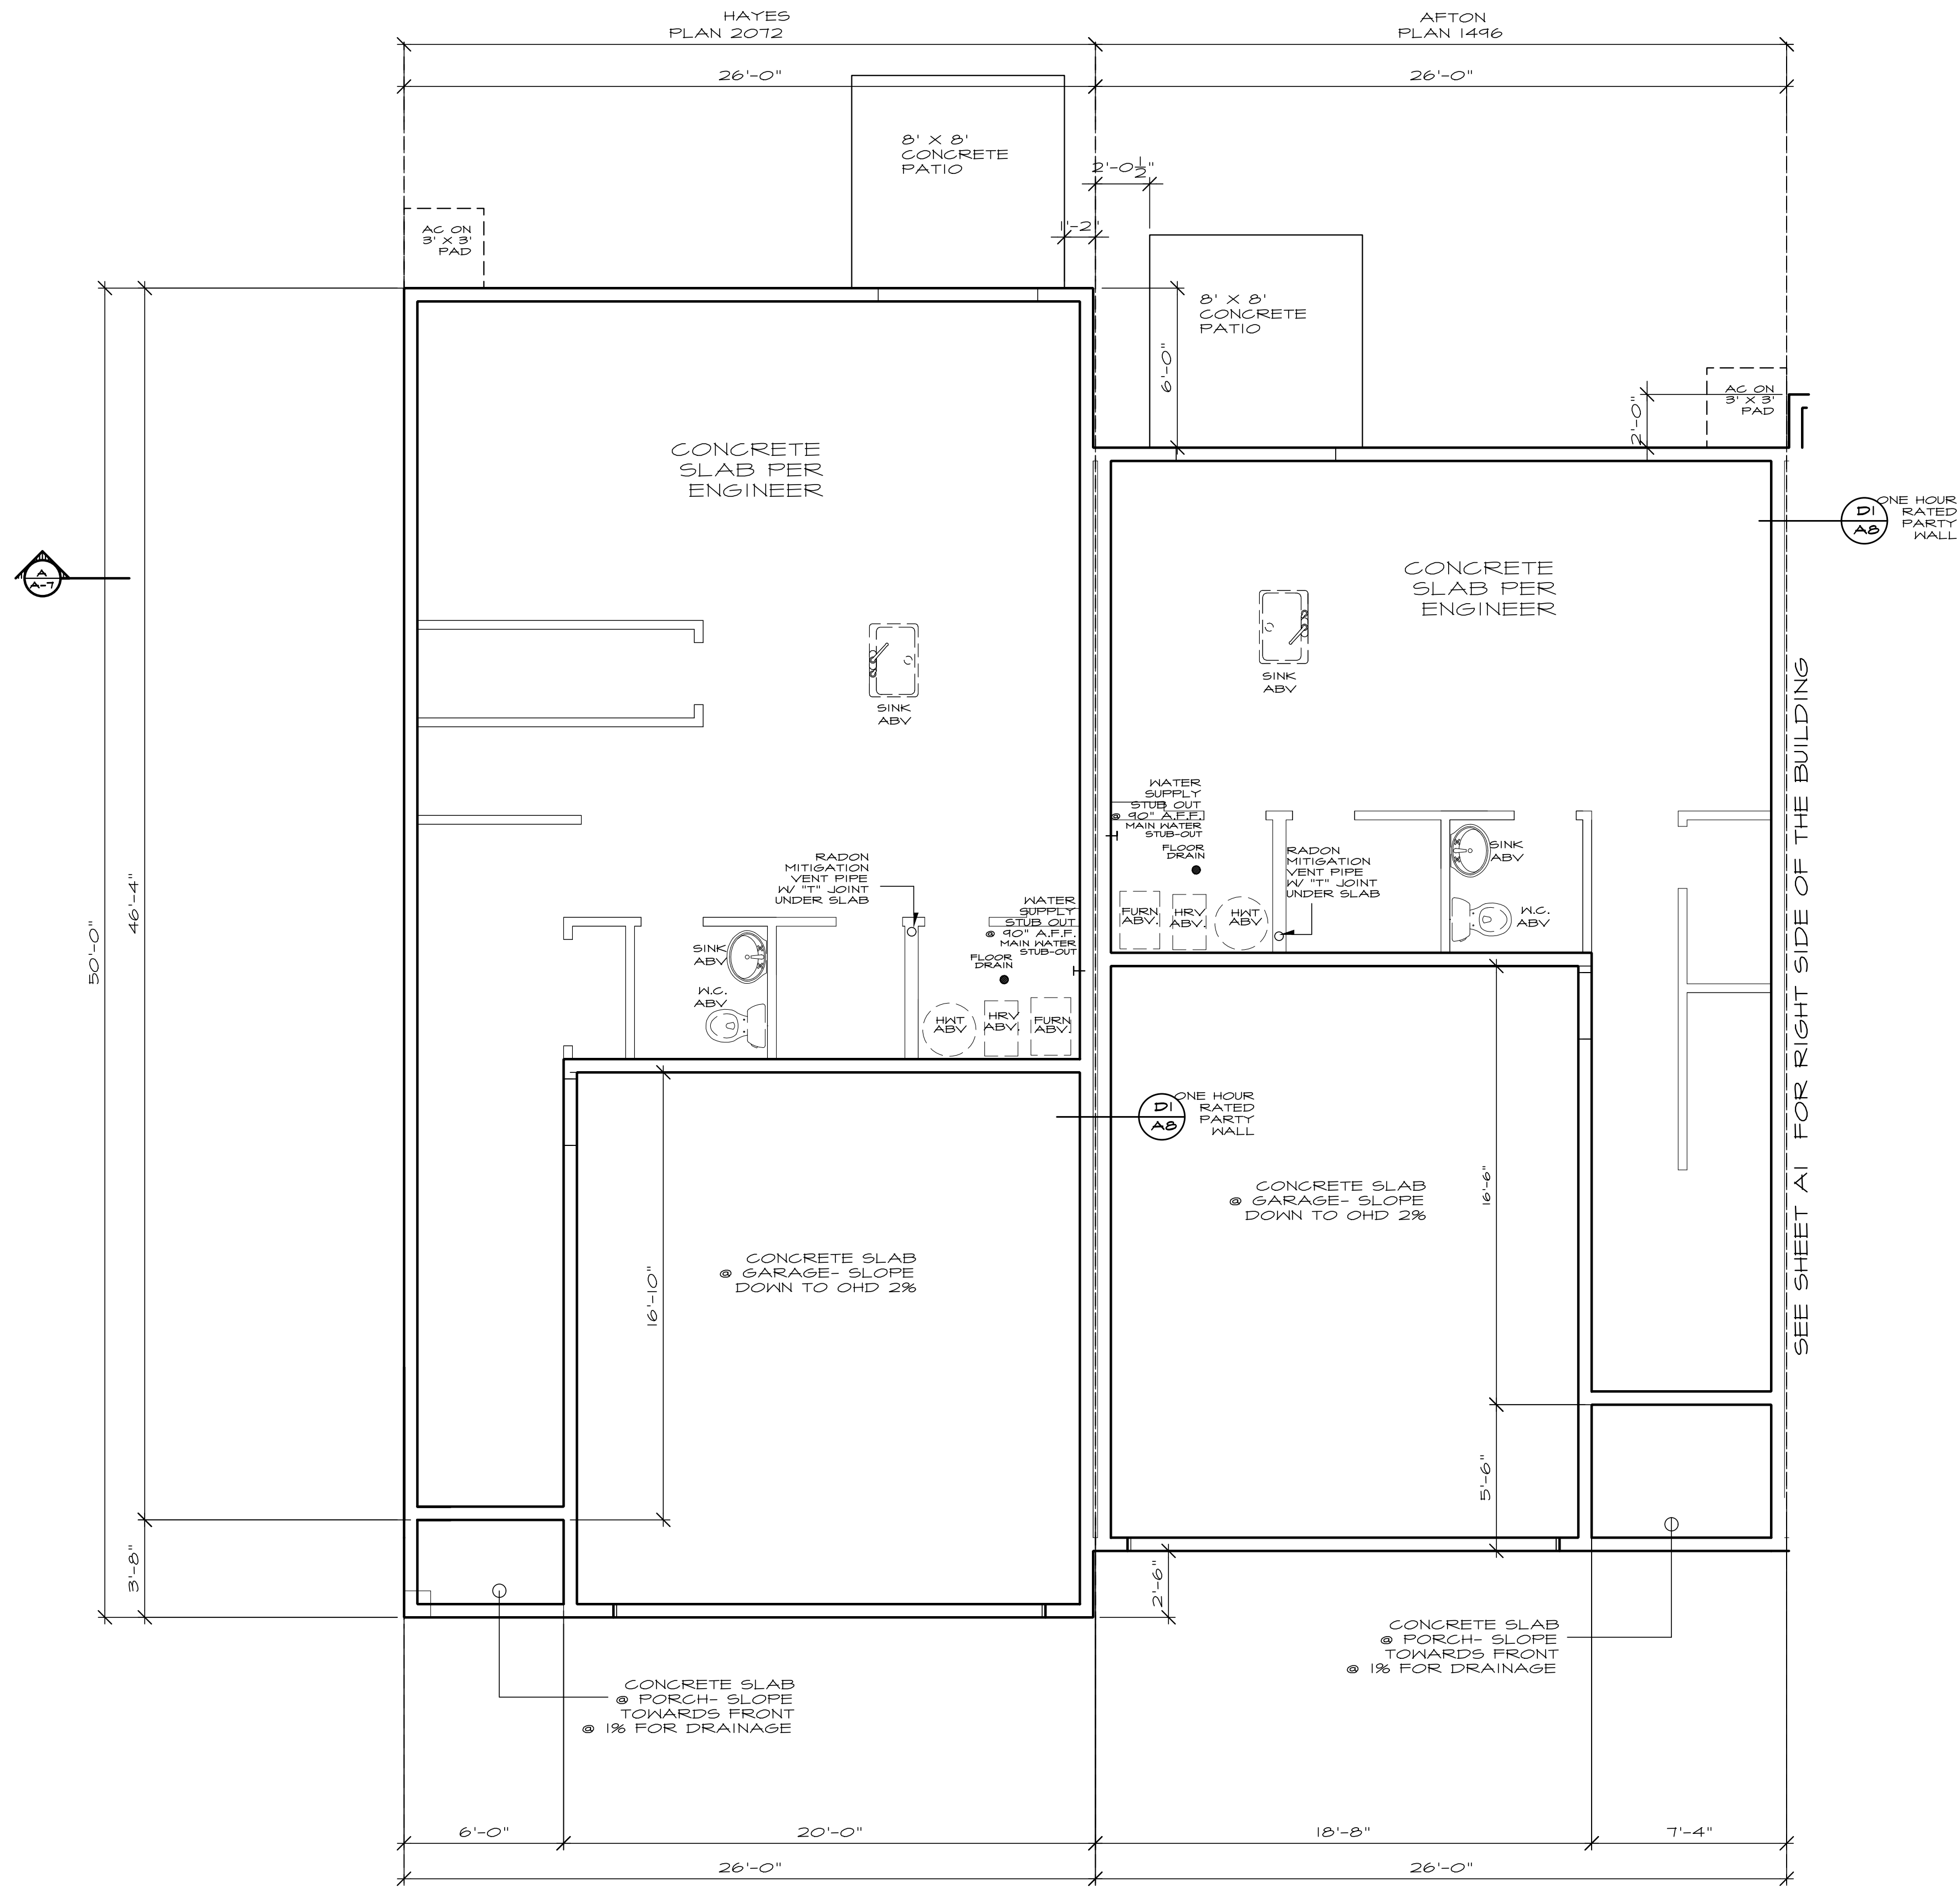
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RAMSEY, MINNESOTA

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SHEET
A1

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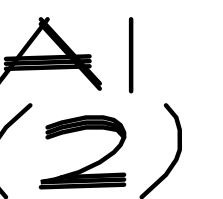
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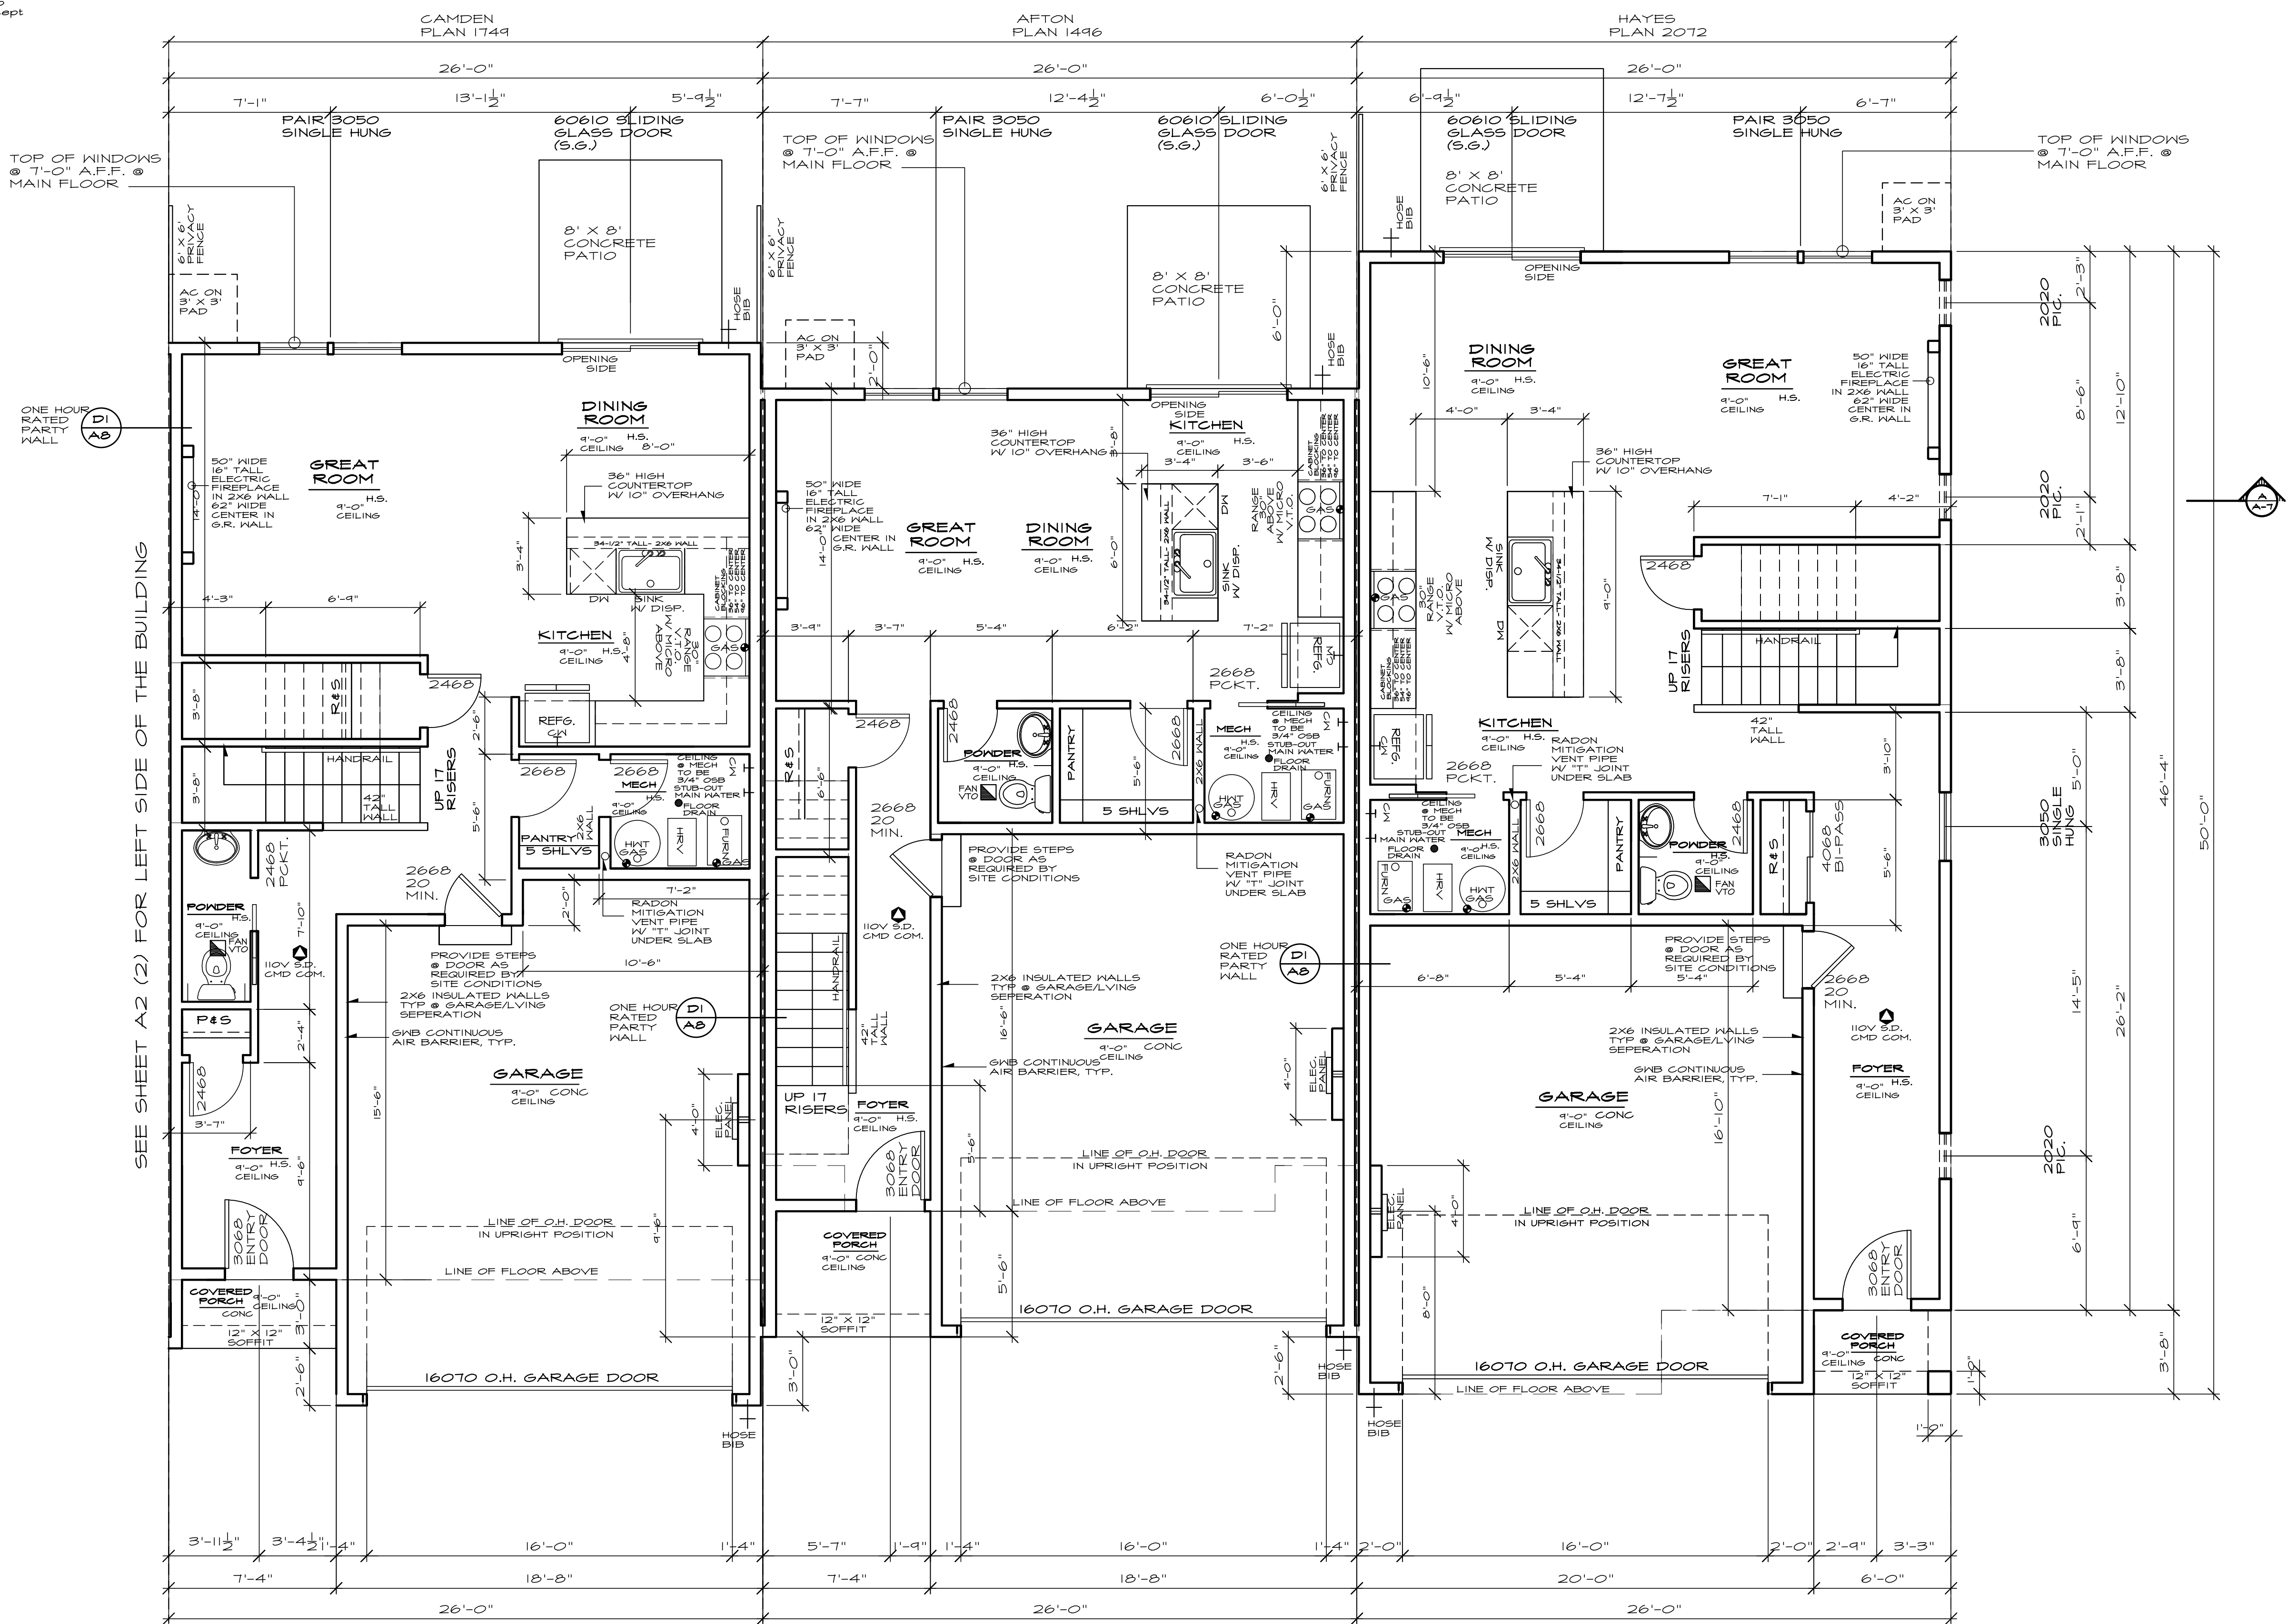


SLAB FOUNDATION

SEE GENERAL NOTES

SCALE: 1/4" = 1'-0"

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SEE SHEET A2 (2) FOR LEFT SIDE OF THE BUILDING

MAIN FLOOR PLAN
SEE GENERAL NOTES SCALE: 1/4" = 1'-0"



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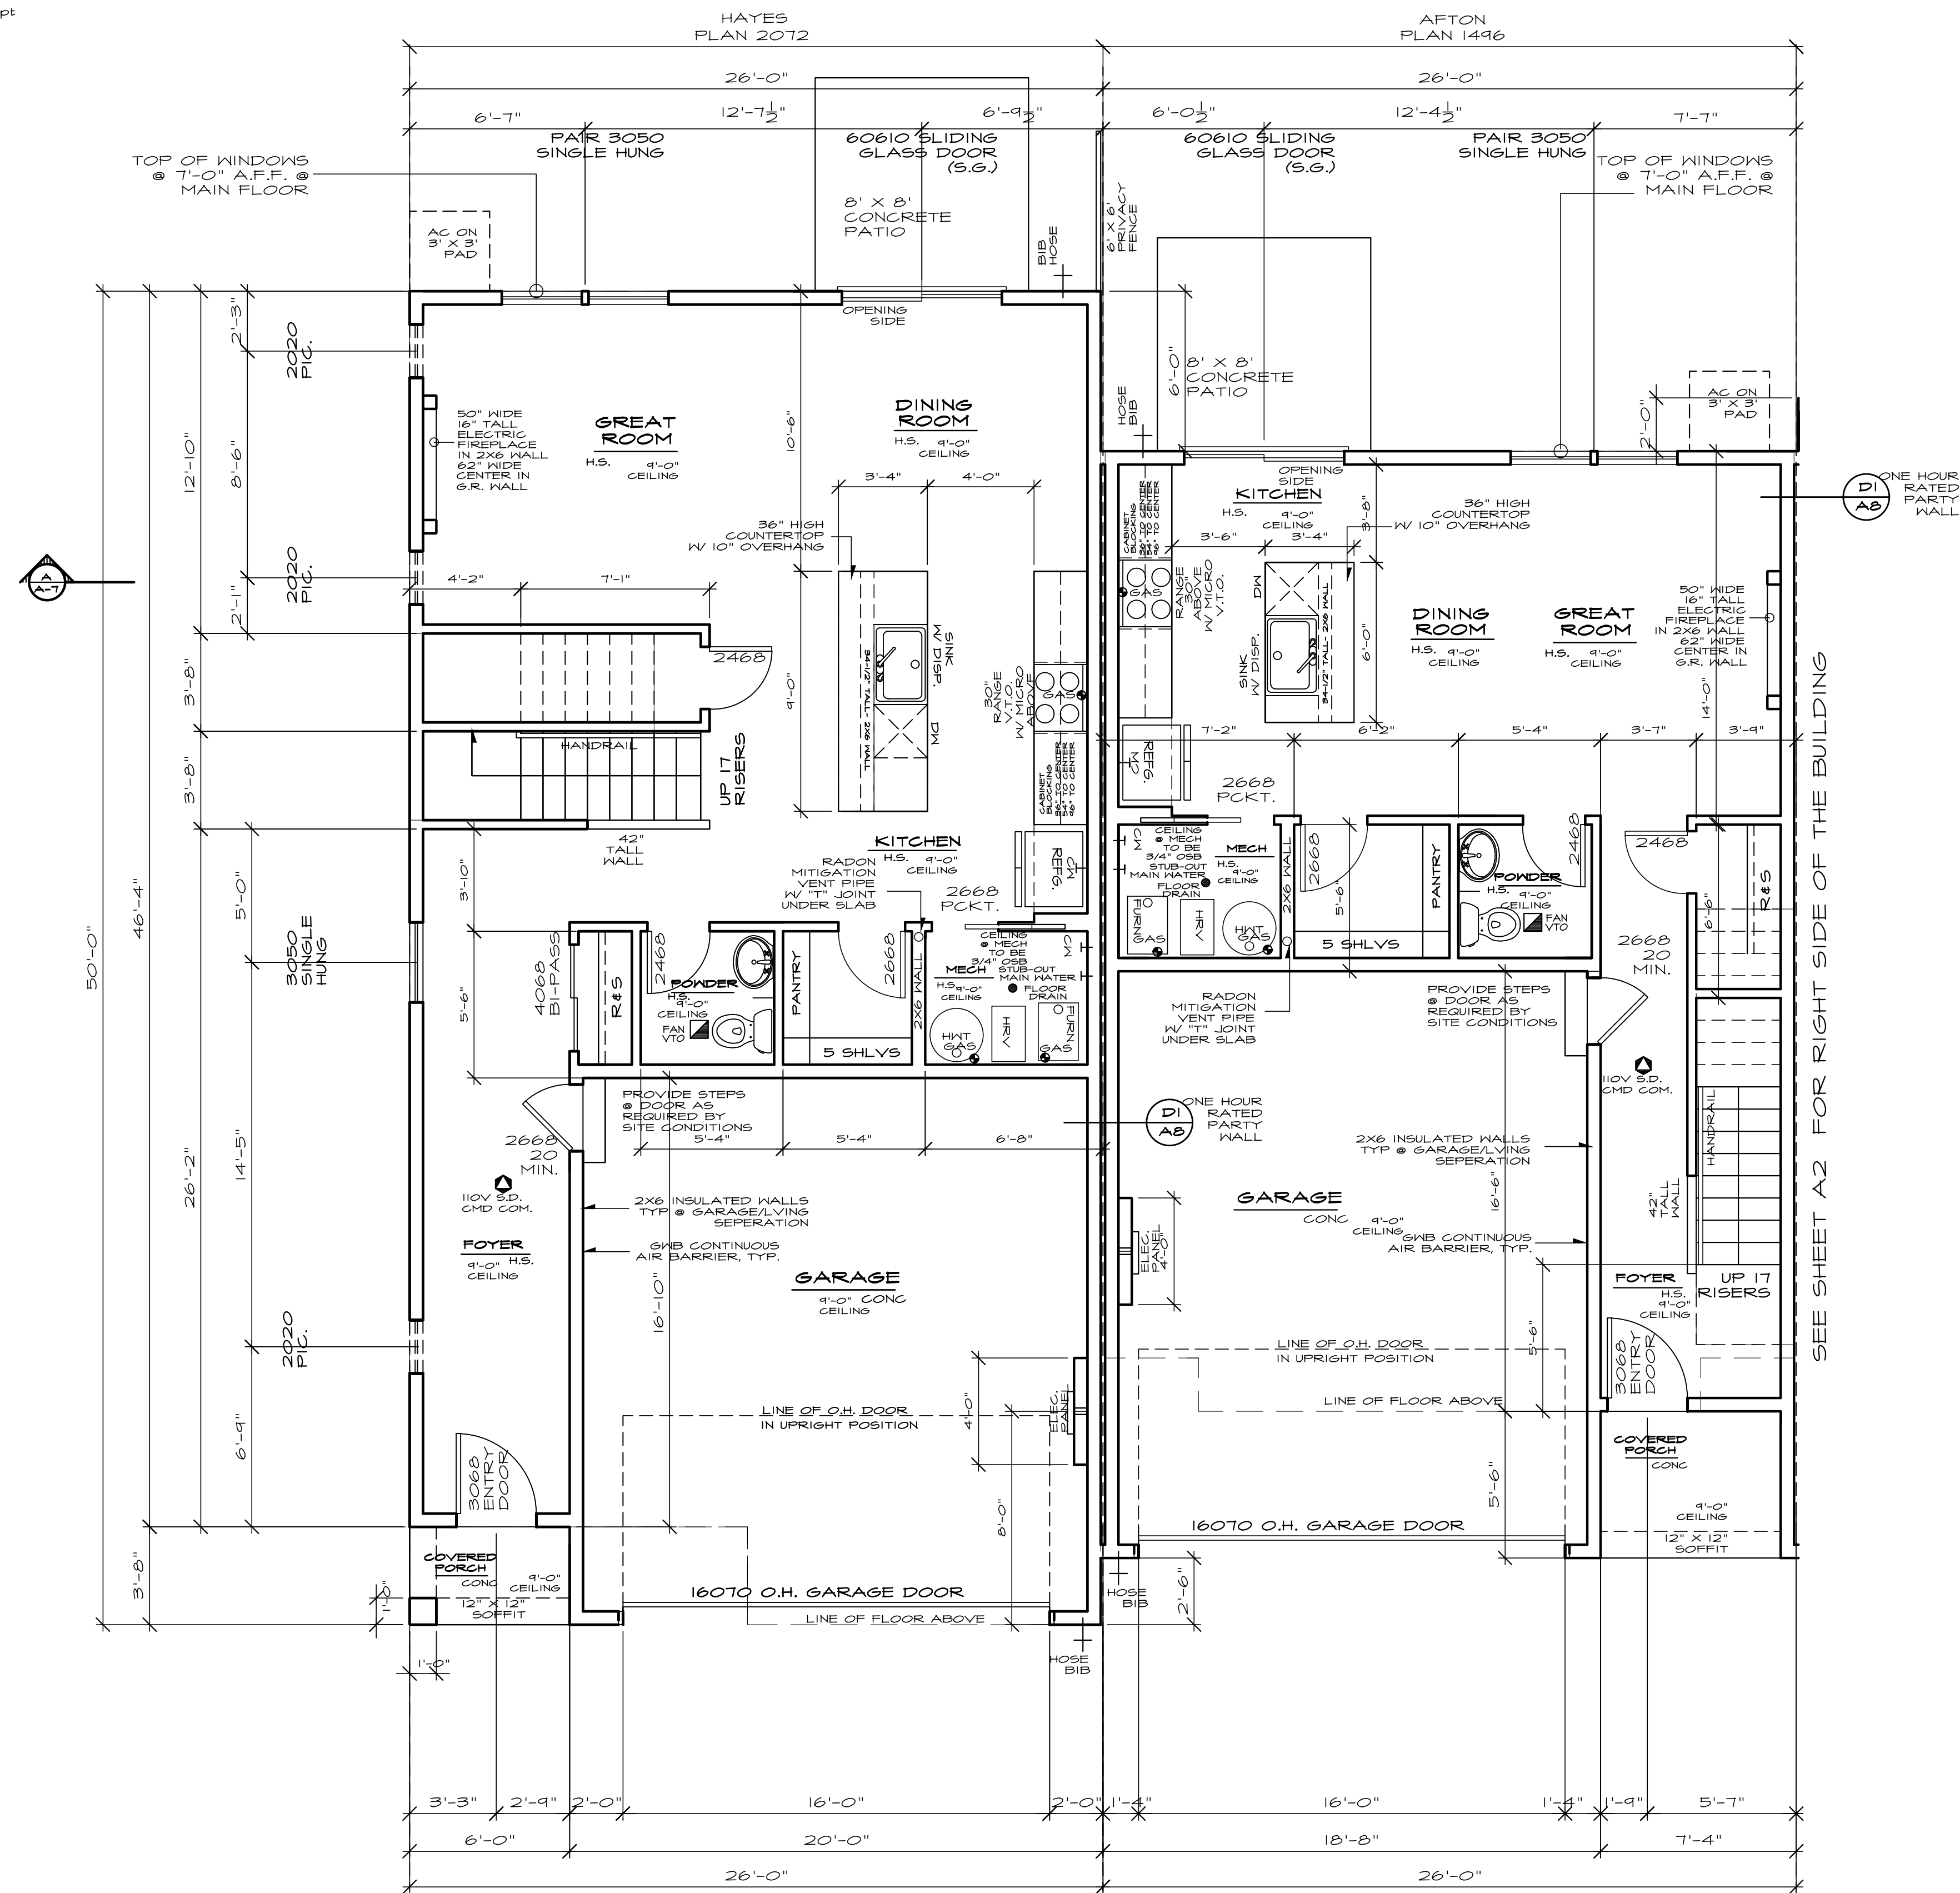
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A2

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SEE SHEET A2 FOR RIGHT SIDE OF THE BUILDING



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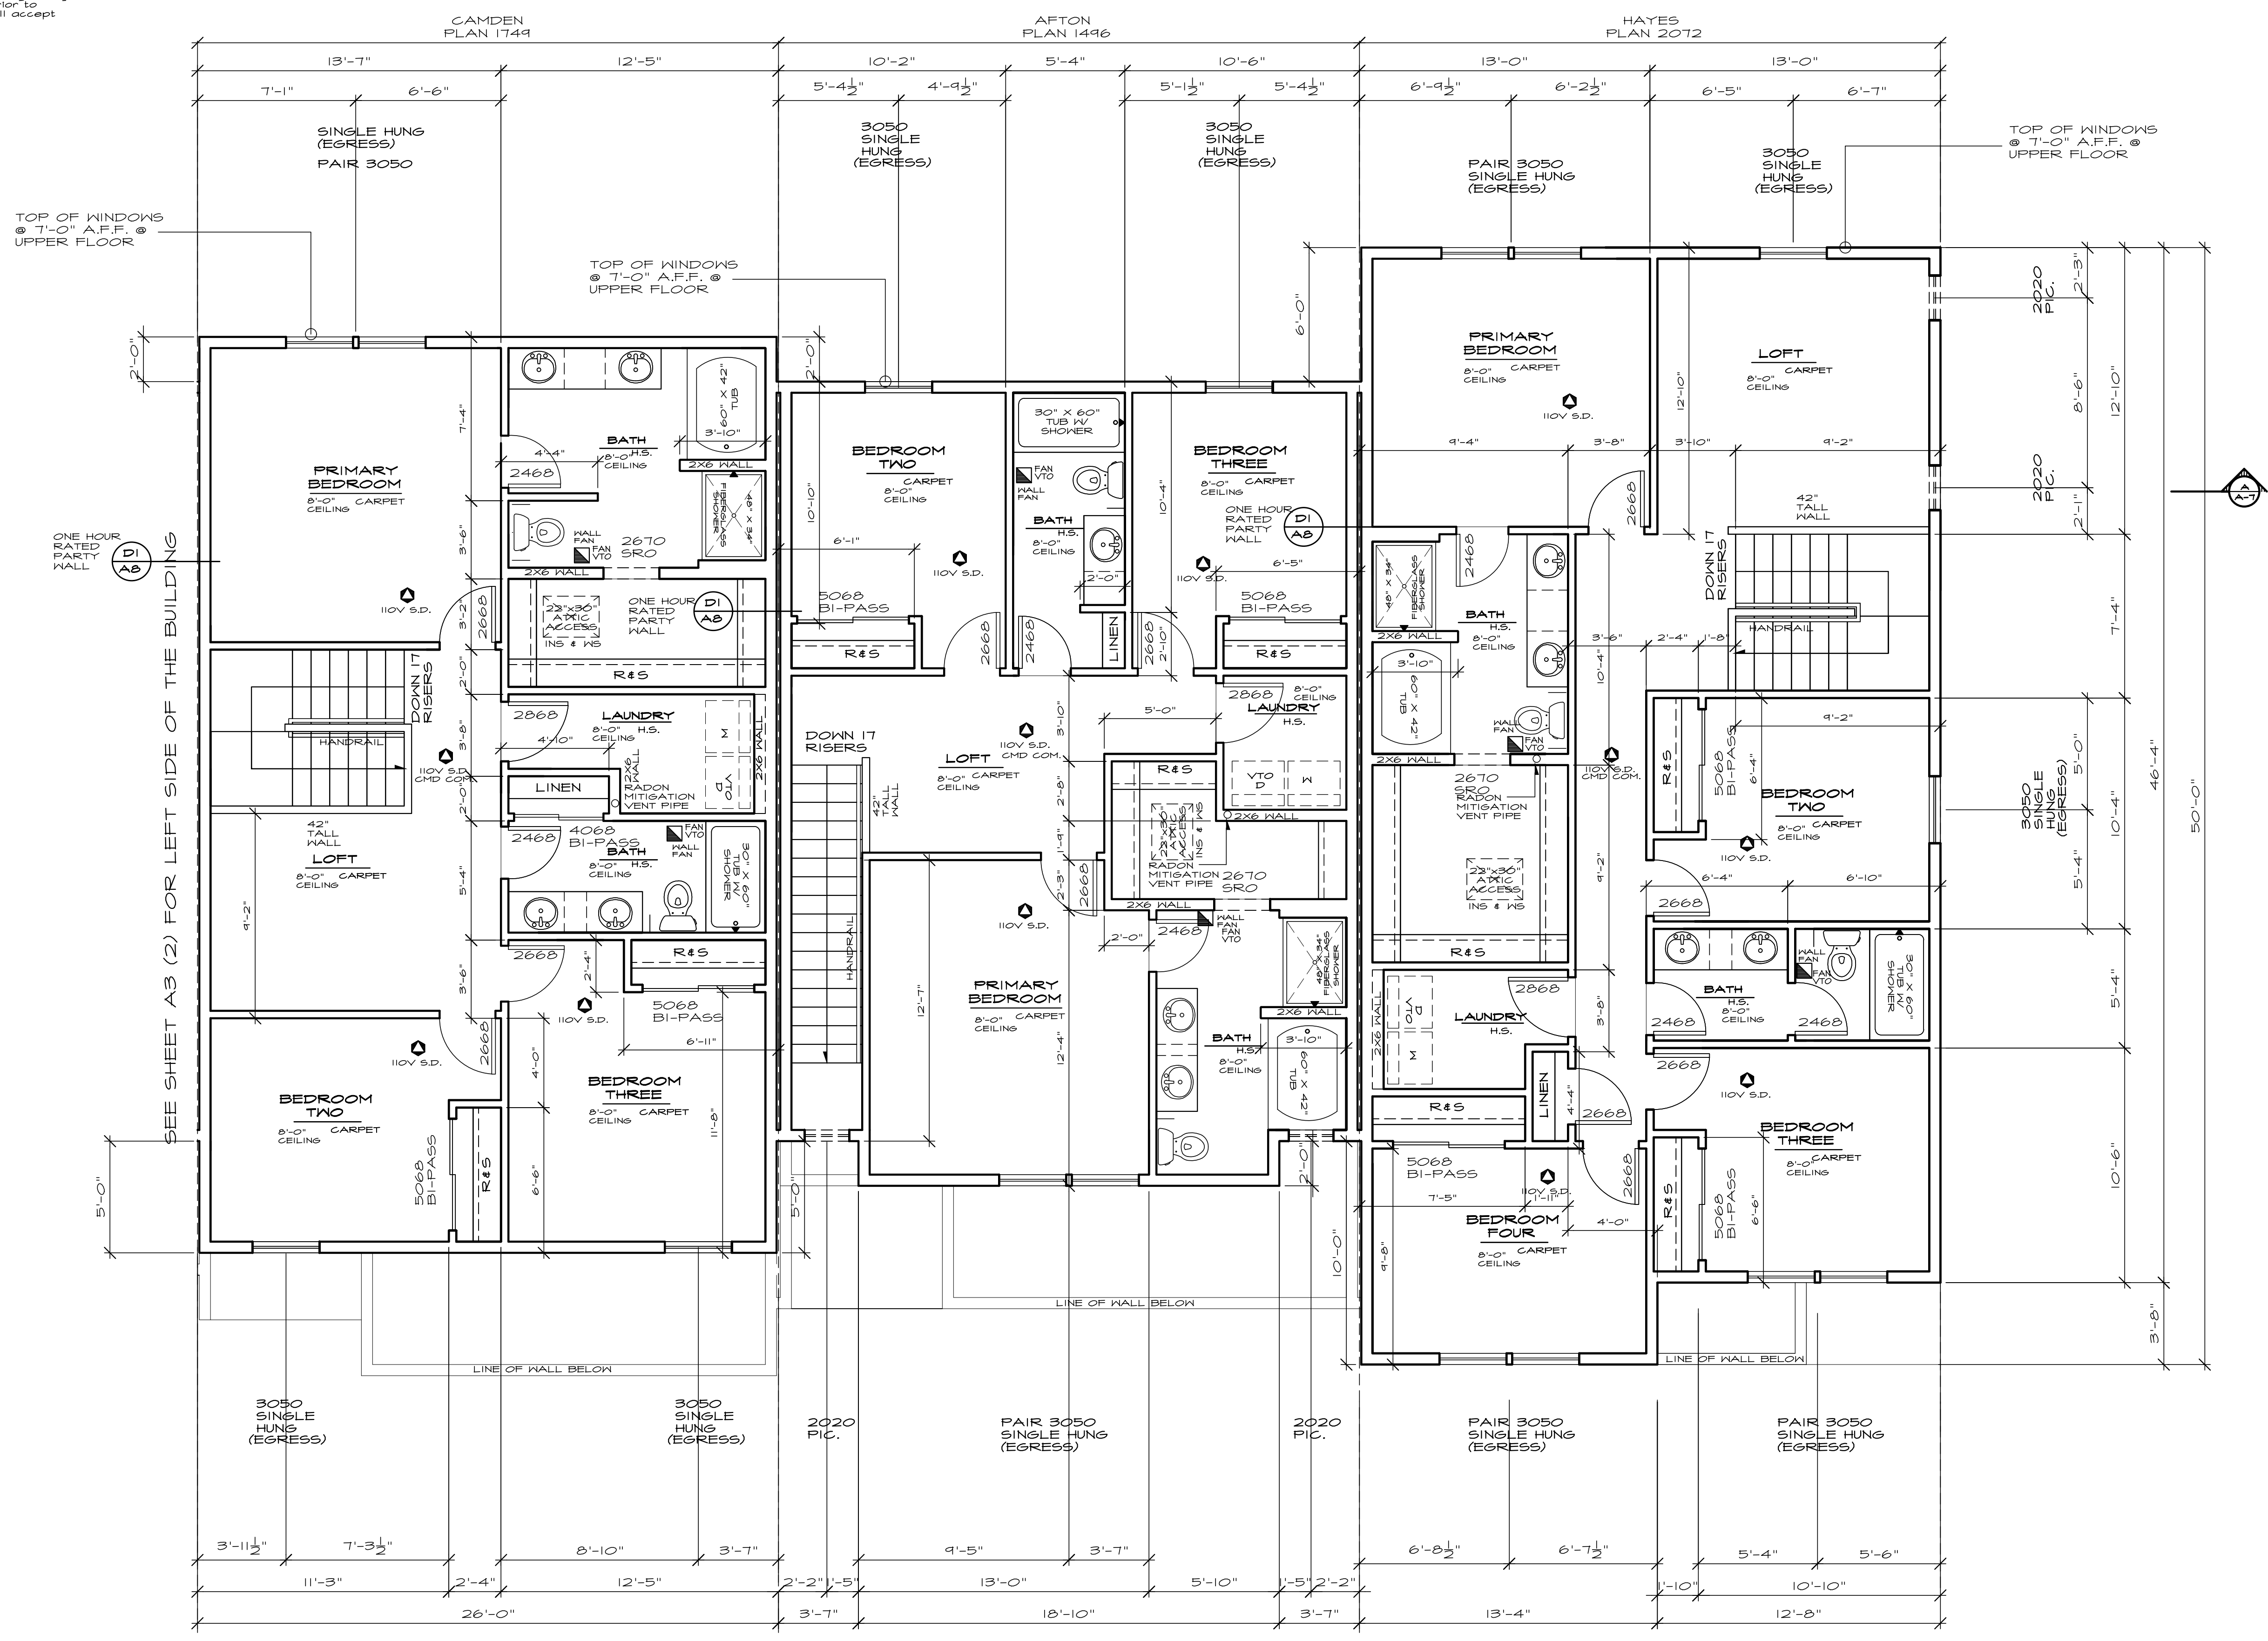
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A2
(2)

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TOP OF WINDOWS @ 7'-0" A.F.F. @ UPPER FLOOR

TOP OF WINDOWS @ 7'-0" A.F.F. @ UPPER FLOOR

TOP OF WINDOWS @ 7'-0" A.F.F. @ UPPER FLOOR

ONE HOUR RATED PARTY WALL

SEE SHEET A3 (2) FOR LEFT SIDE OF THE BUILDING

LINE OF WALL BELOW

LINE OF WALL BELOW

LINE OF WALL BELOW

UPPER FLOOR PLAN
SEE GENERAL NOTES SCALE: 1/4" = 1'-0"



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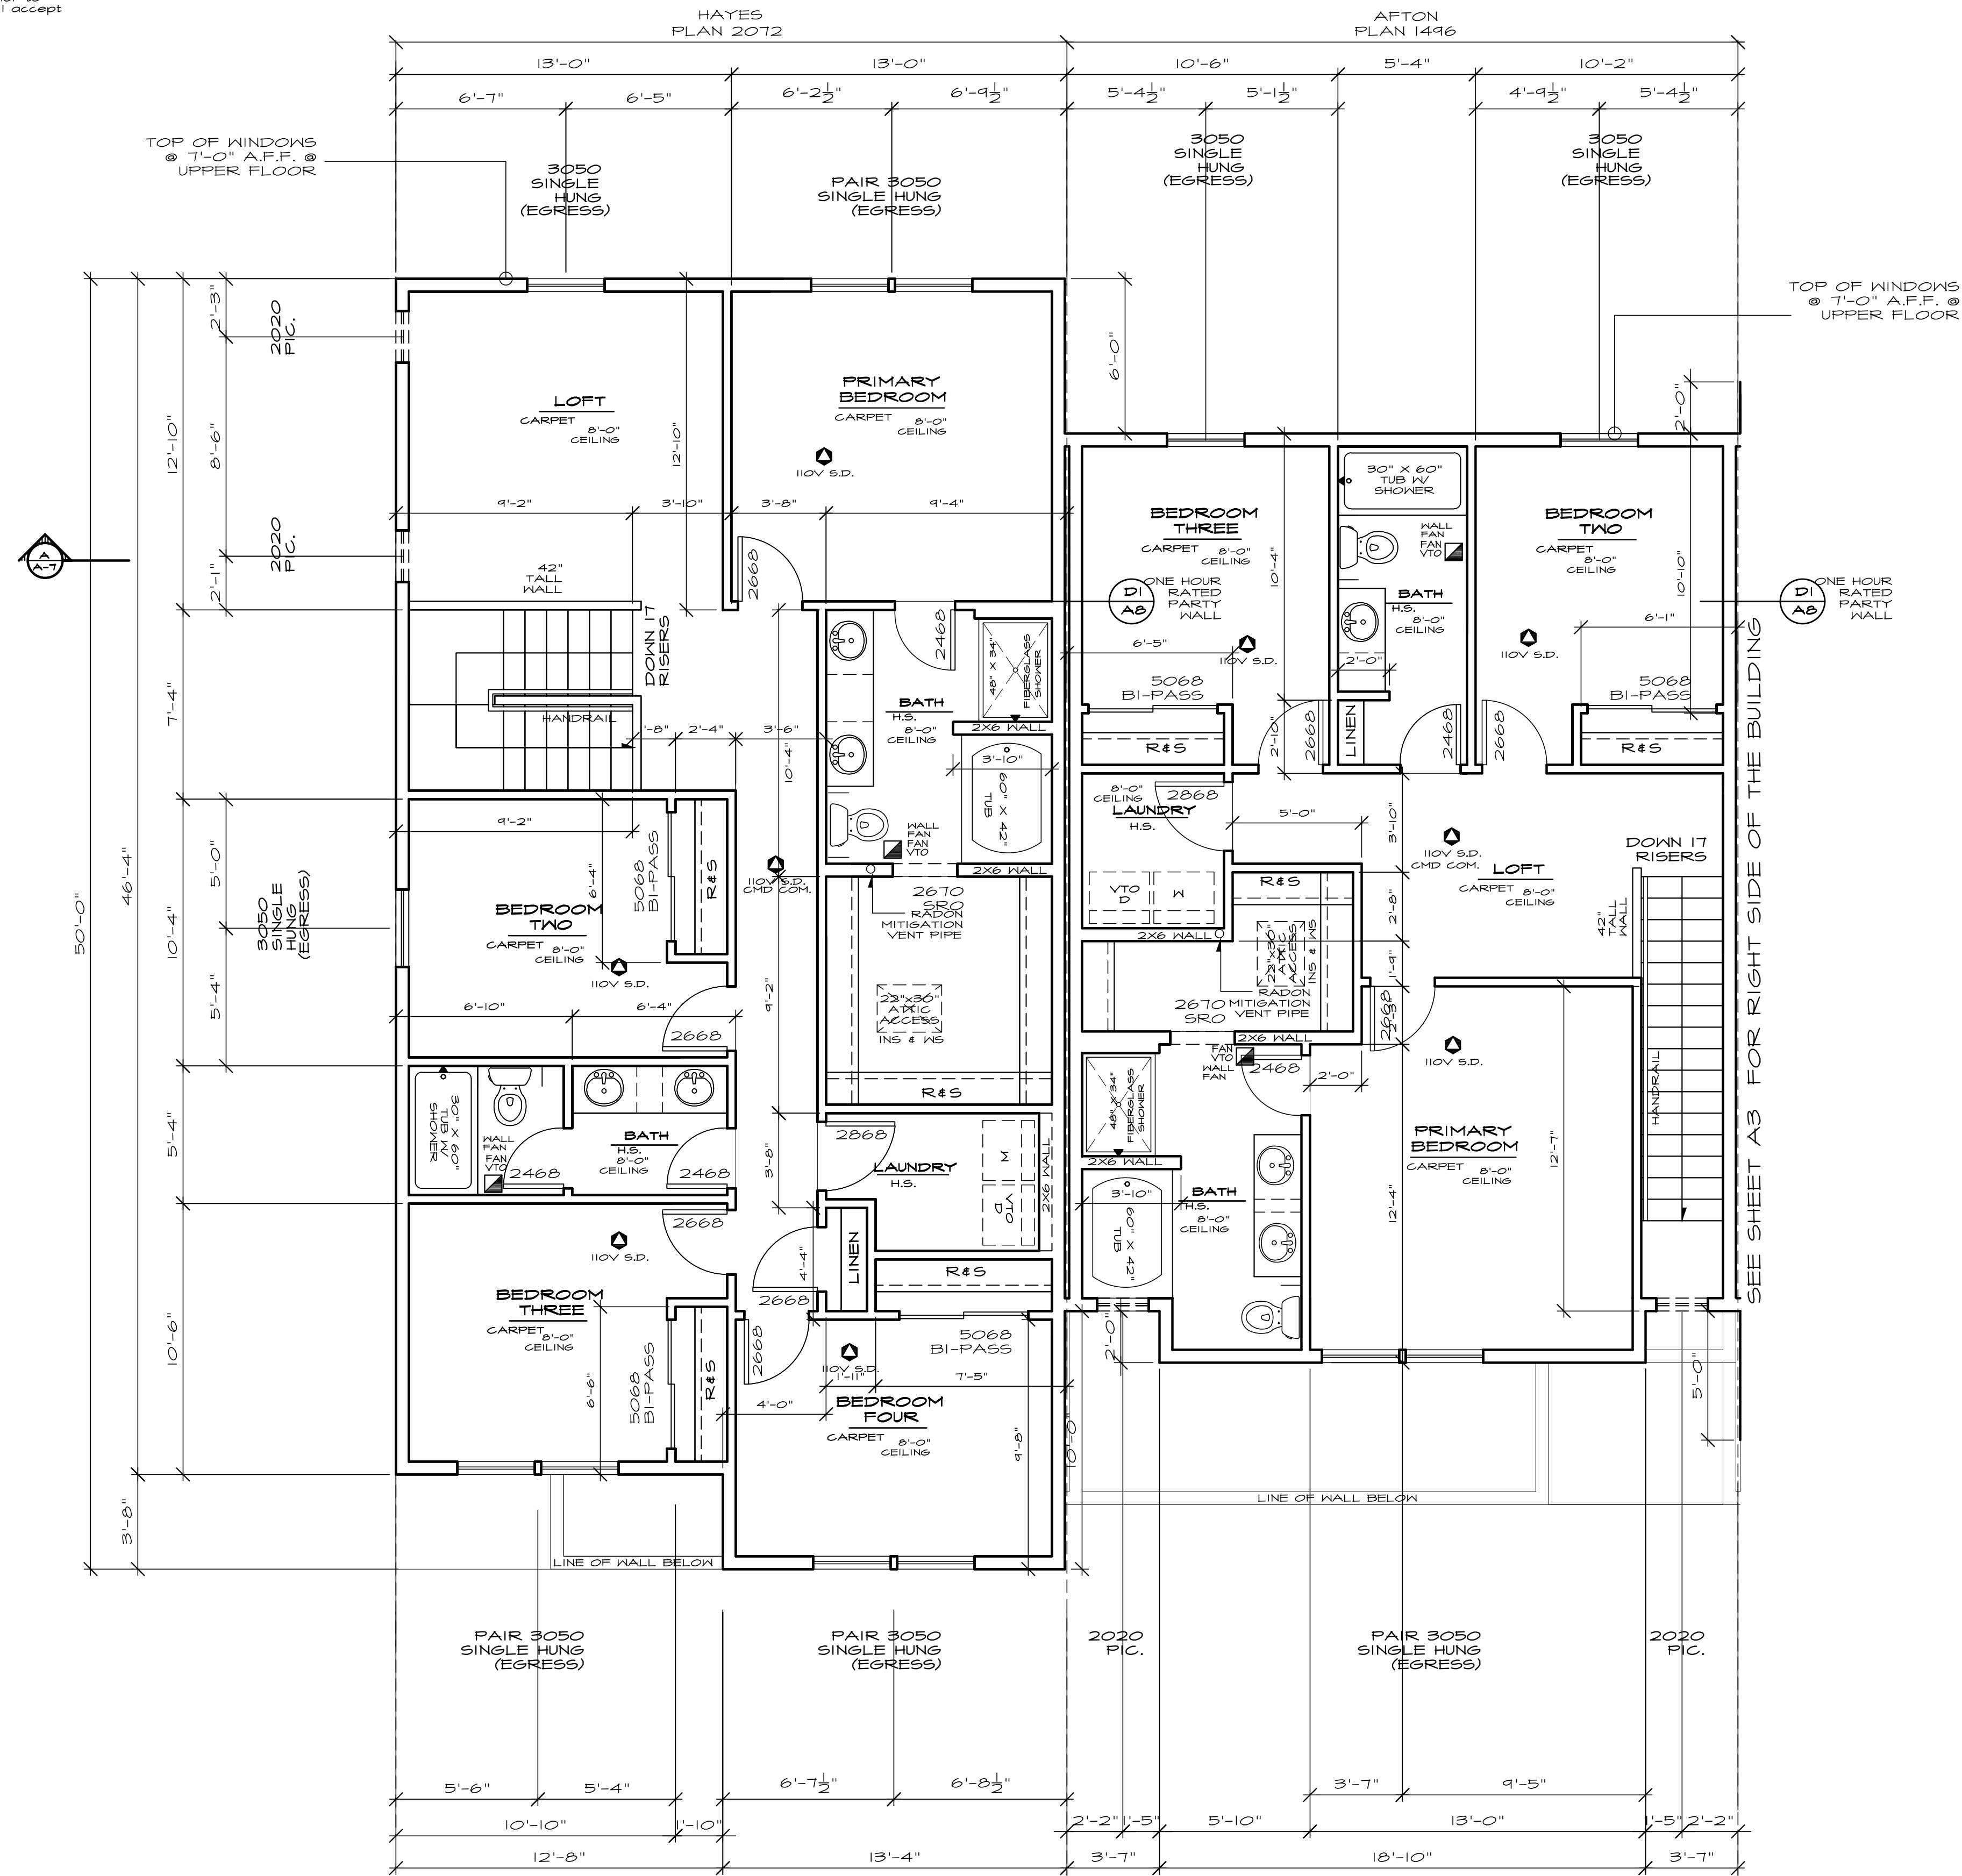
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5 UNIT BUILDING
RAMSEY, MINNESOTA**

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revisions:

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SHEET
A3

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UPPER FLOOR PLAN
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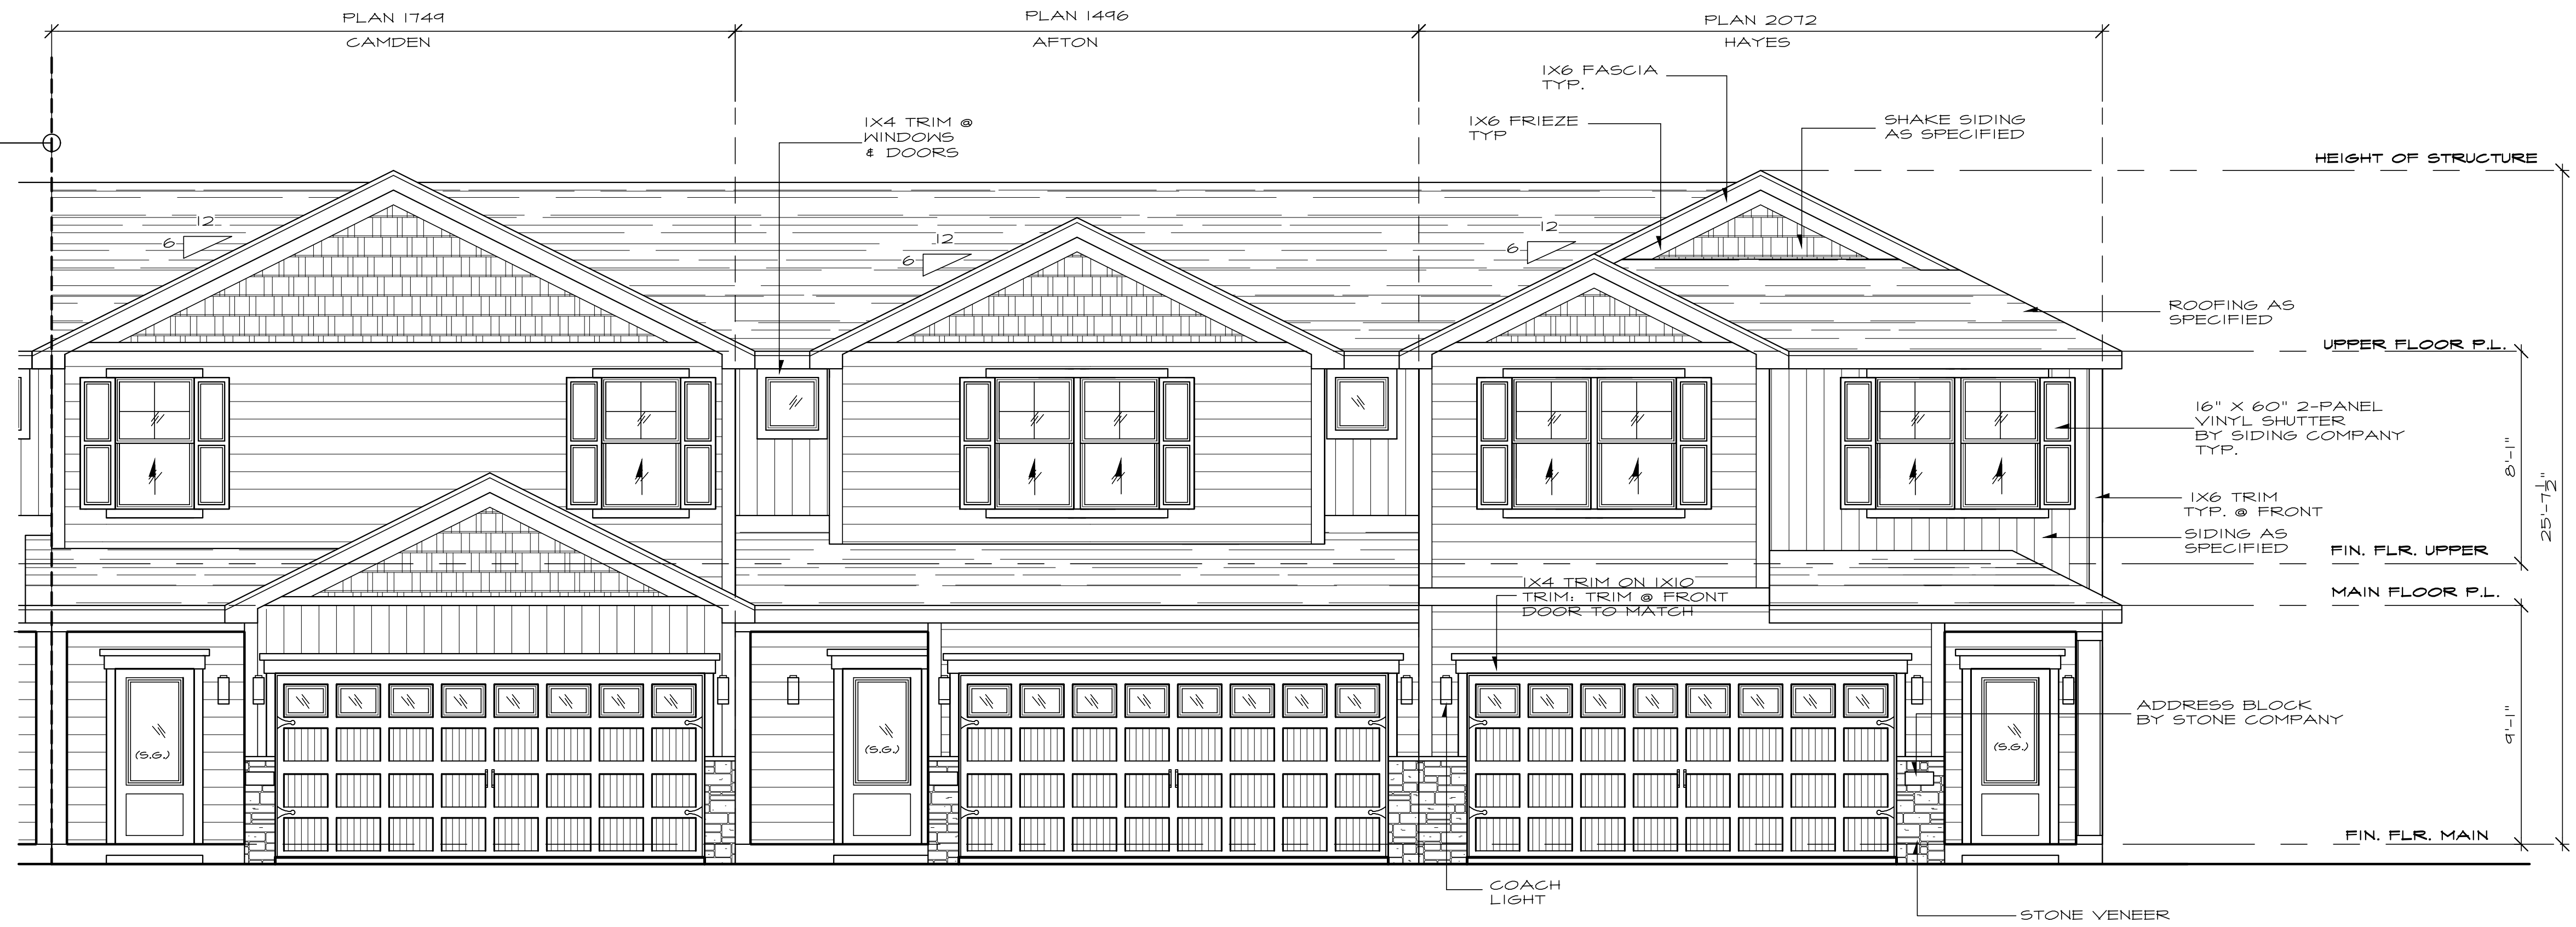
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SHEET


AB
 (2)

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SEE SHEET A-4(2) FOR LEFT SIDE OF THE FRONT ELEVATION



FRONT ELEVATION
SEE GENERAL NOTES SCALE: 1/4" = 1'-0"

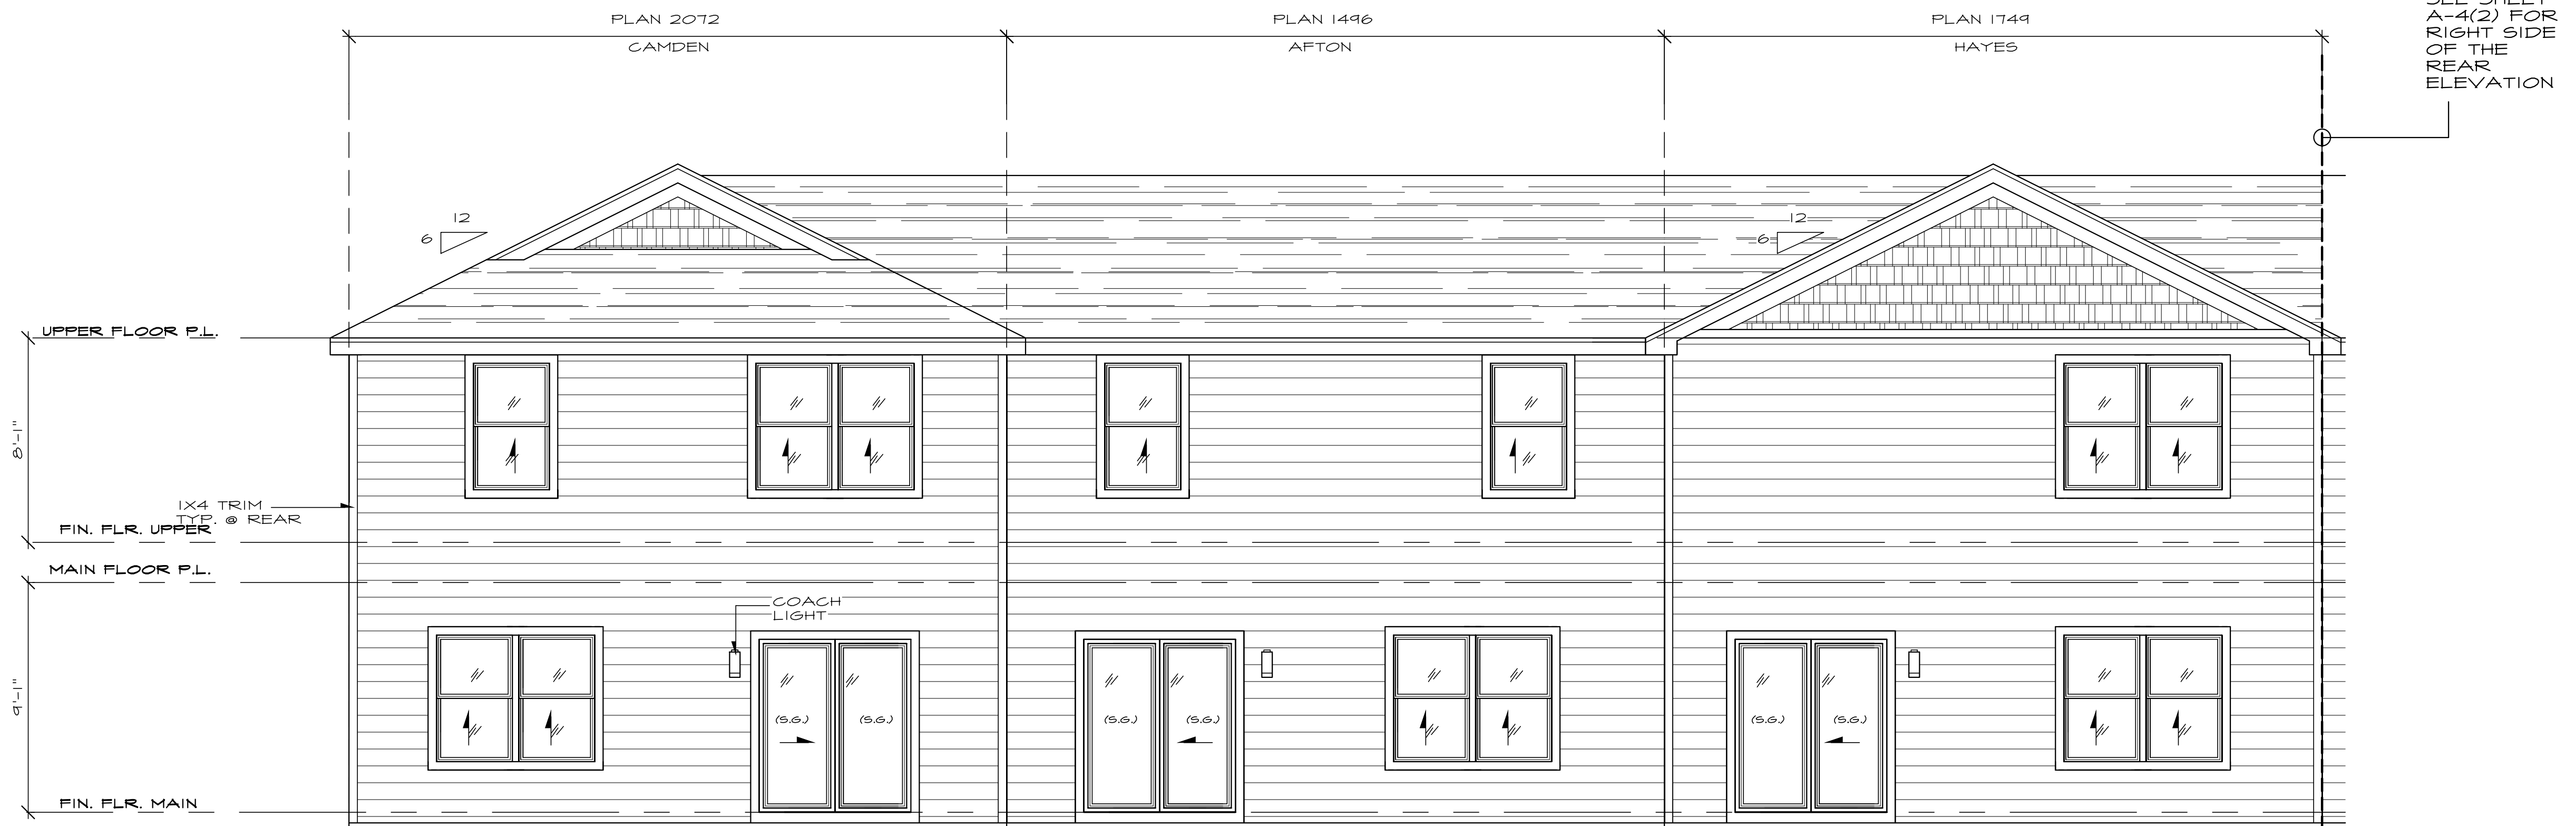

SEE SHEET A-4(2) FOR RIGHT SIDE OF THE REAR ELEVATION

REAR ELEVATION
SEE GENERAL NOTES SCALE: 1/4" = 1'-0"



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RIVENWICK VILLAGE
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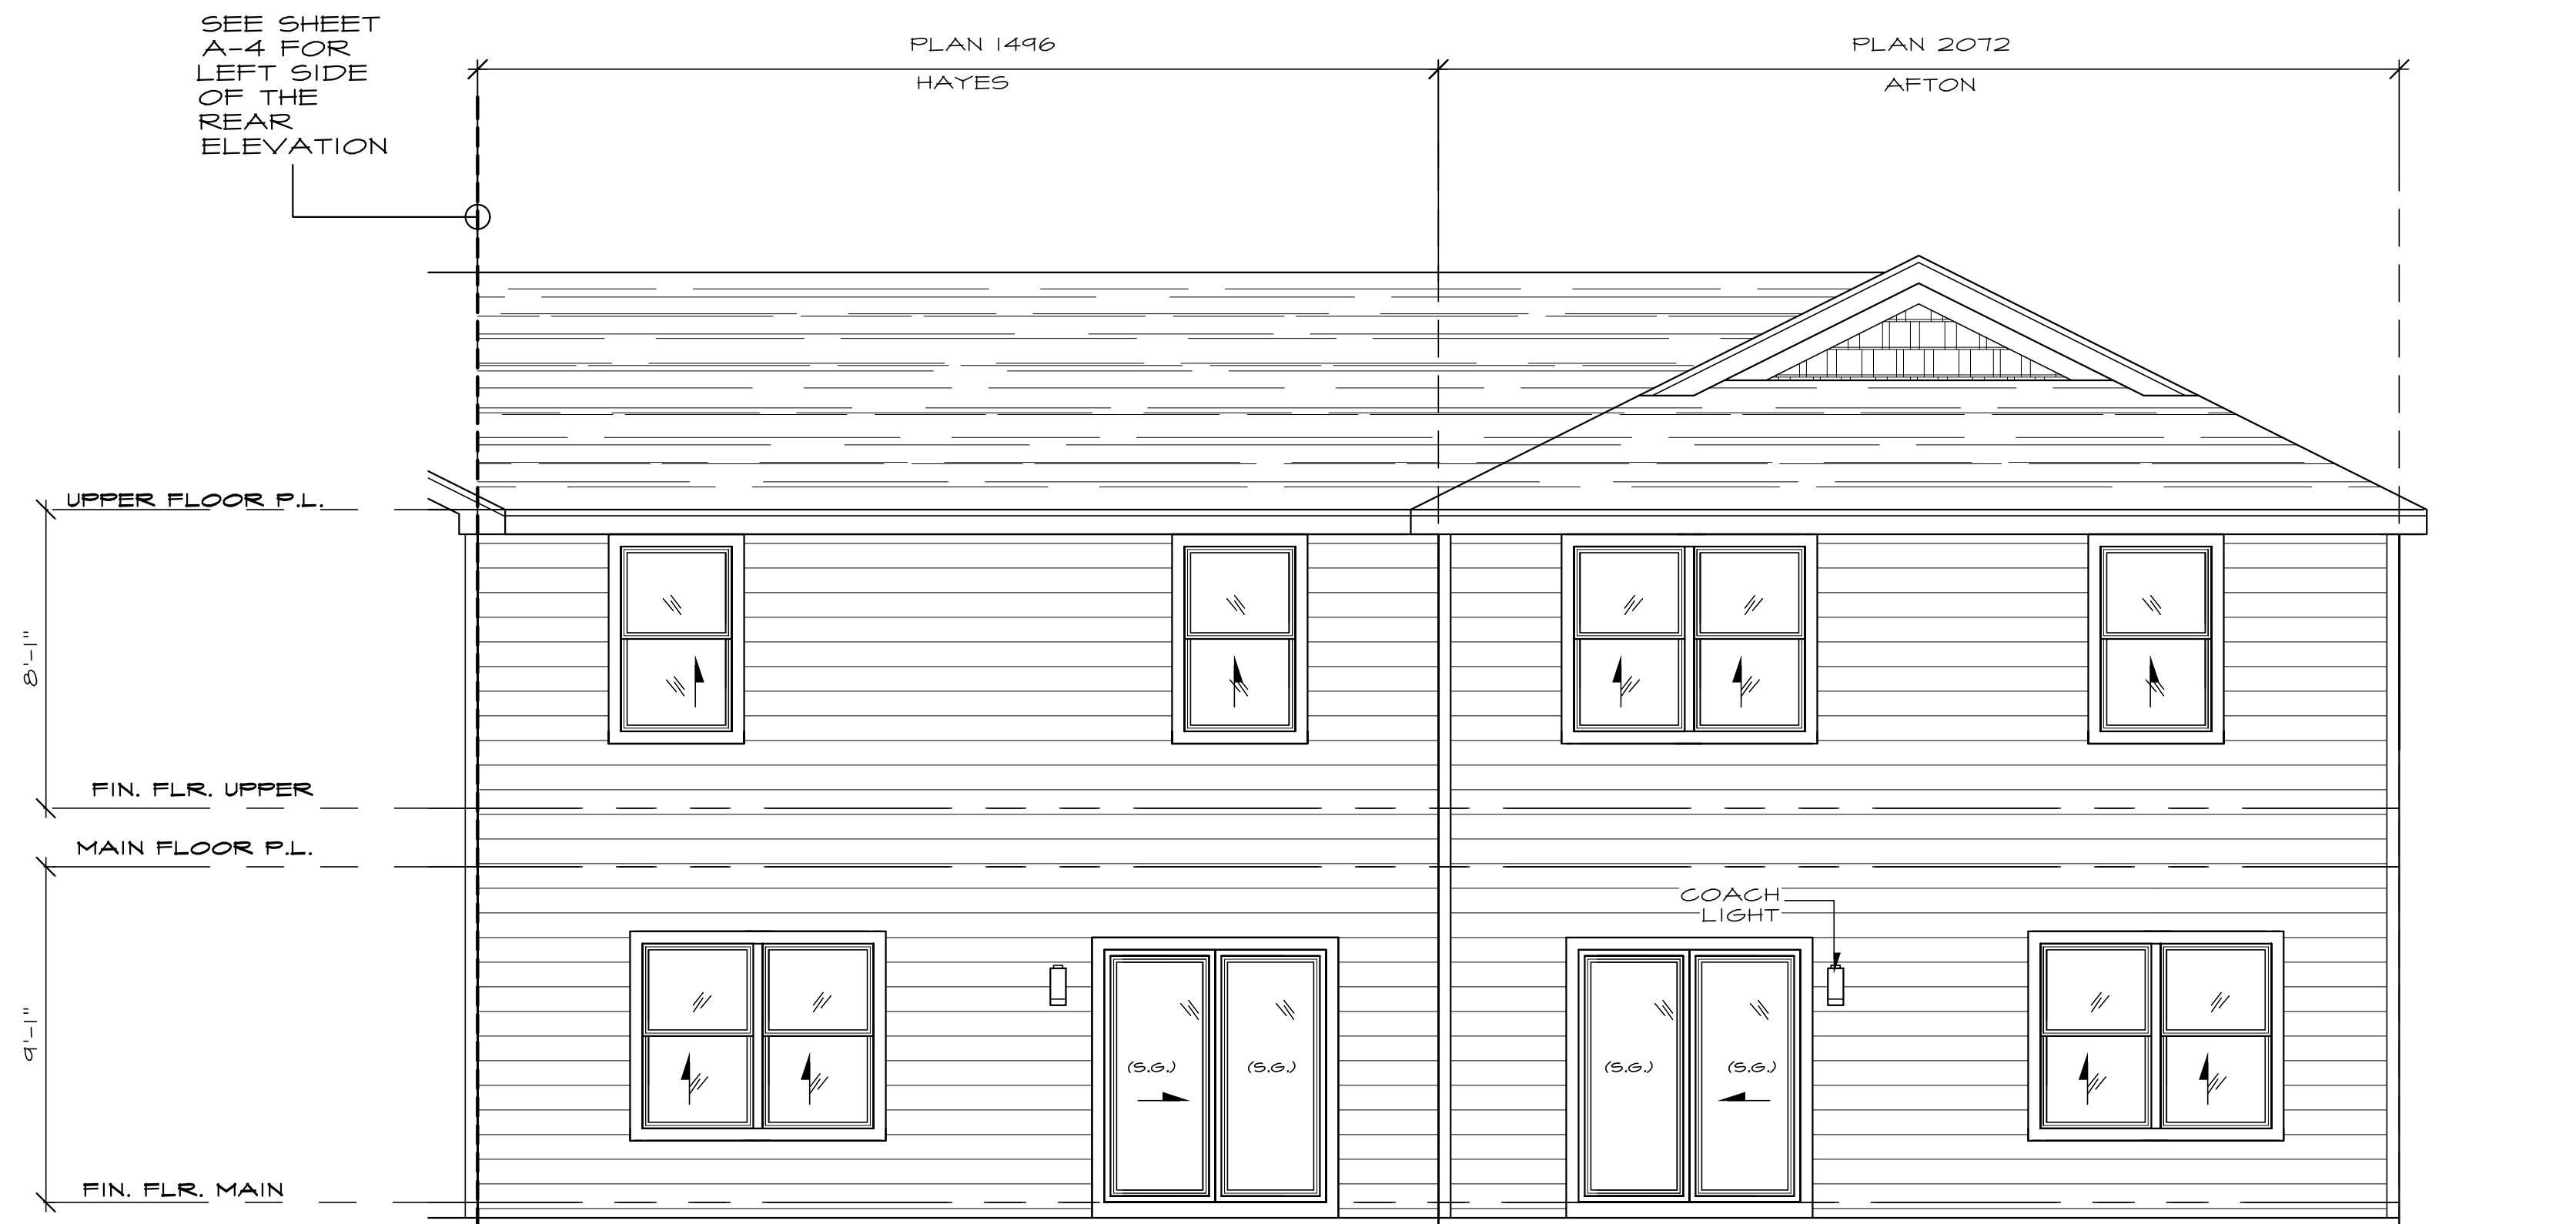
SHEET
A4

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FRONT ELEVATION

SEE GENERAL NOTES SCALE: 1/4" = 1'-0"



REAR ELEVATION

SEE GENERAL NOTES SCALE: 1/4" = 1'-0"



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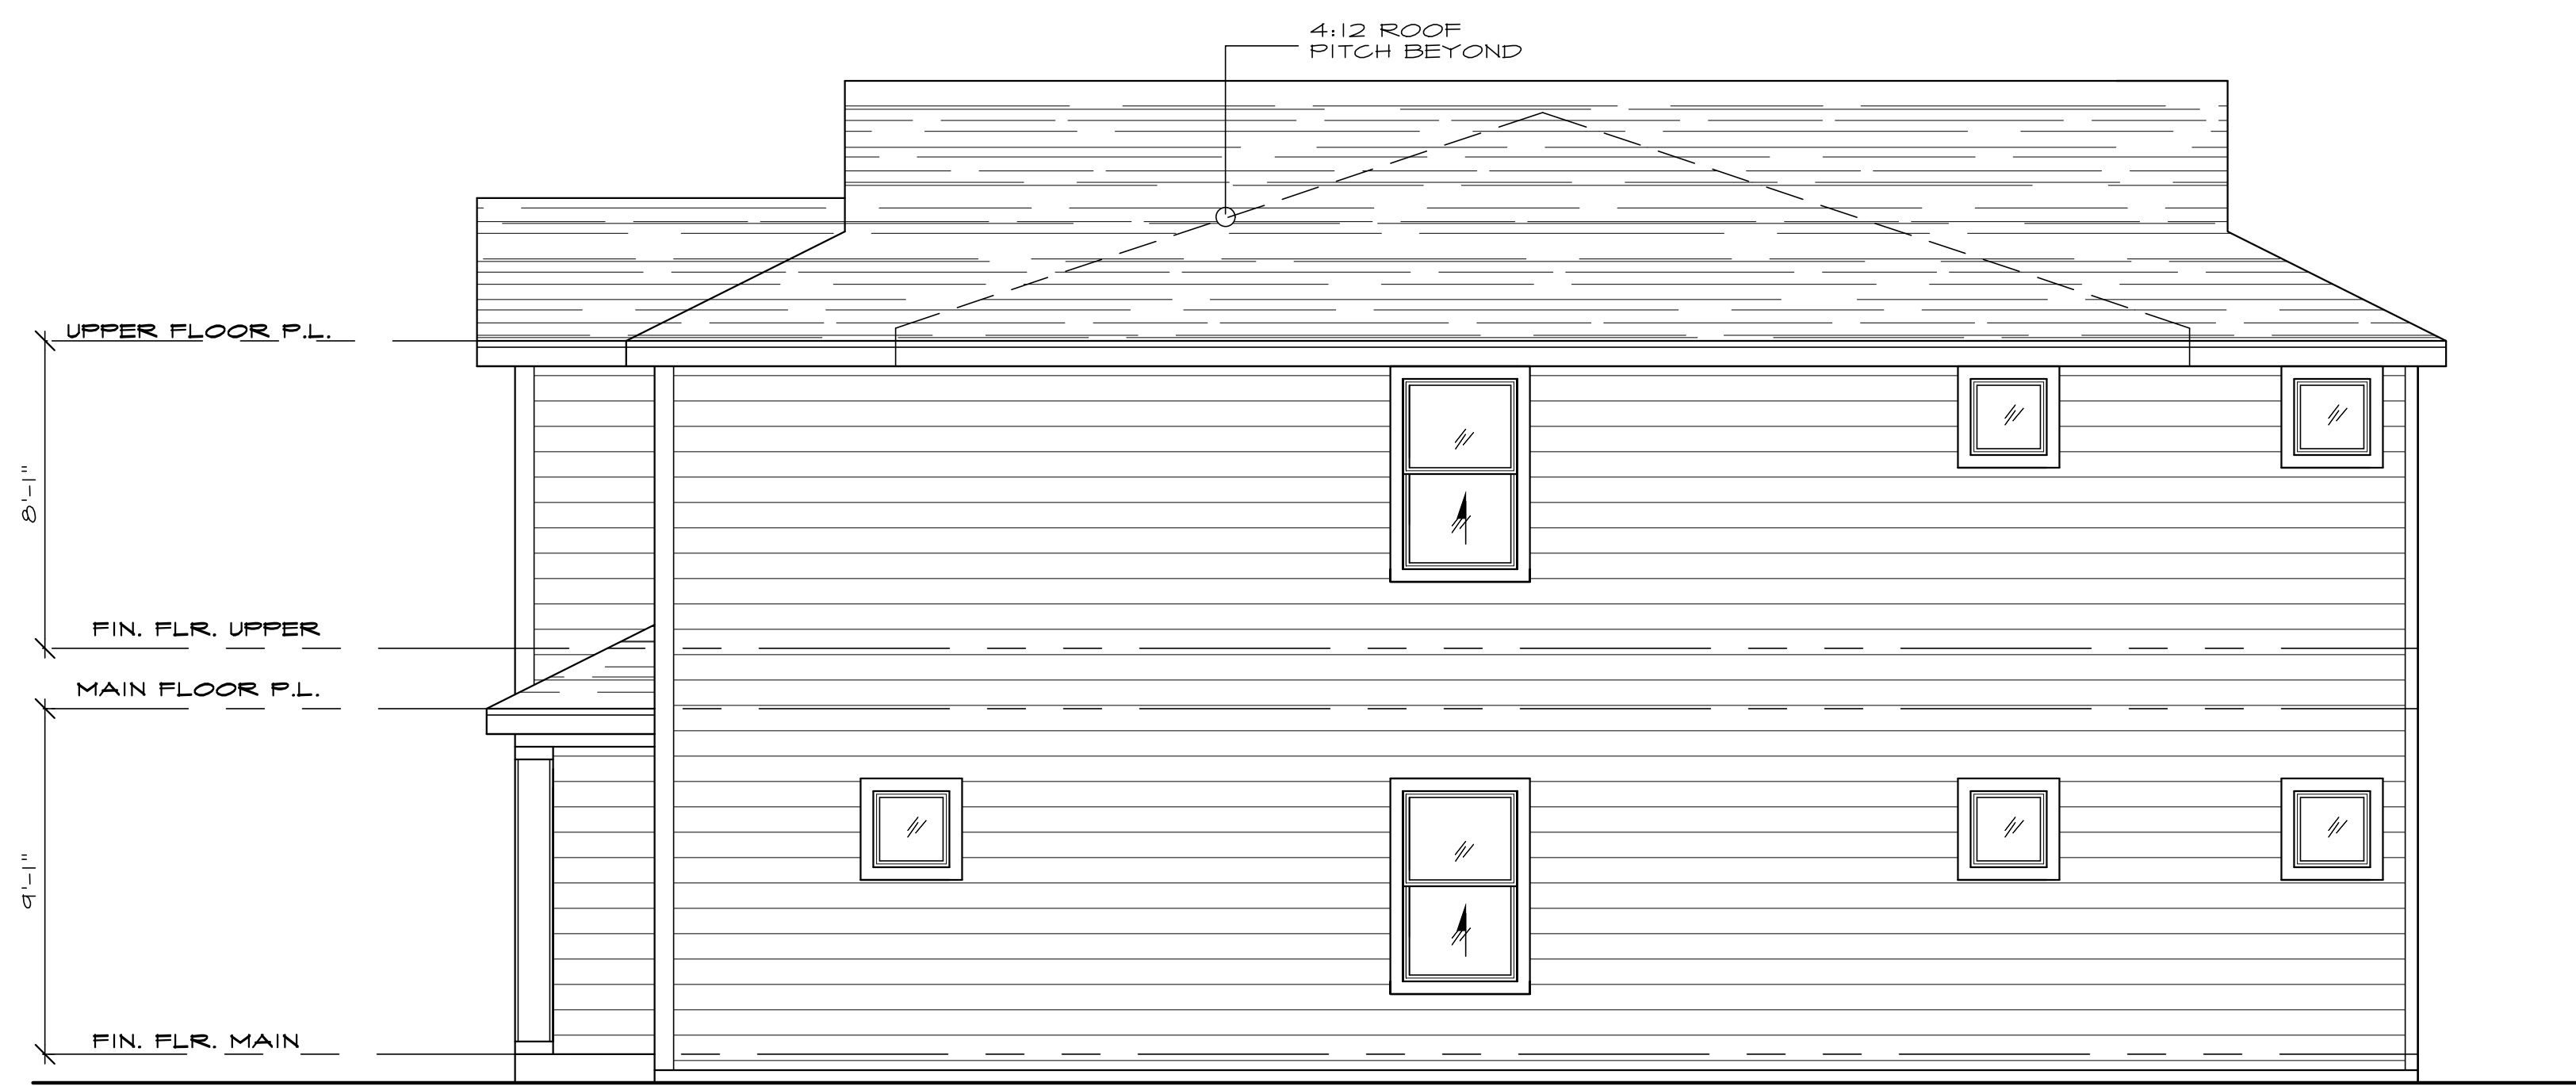
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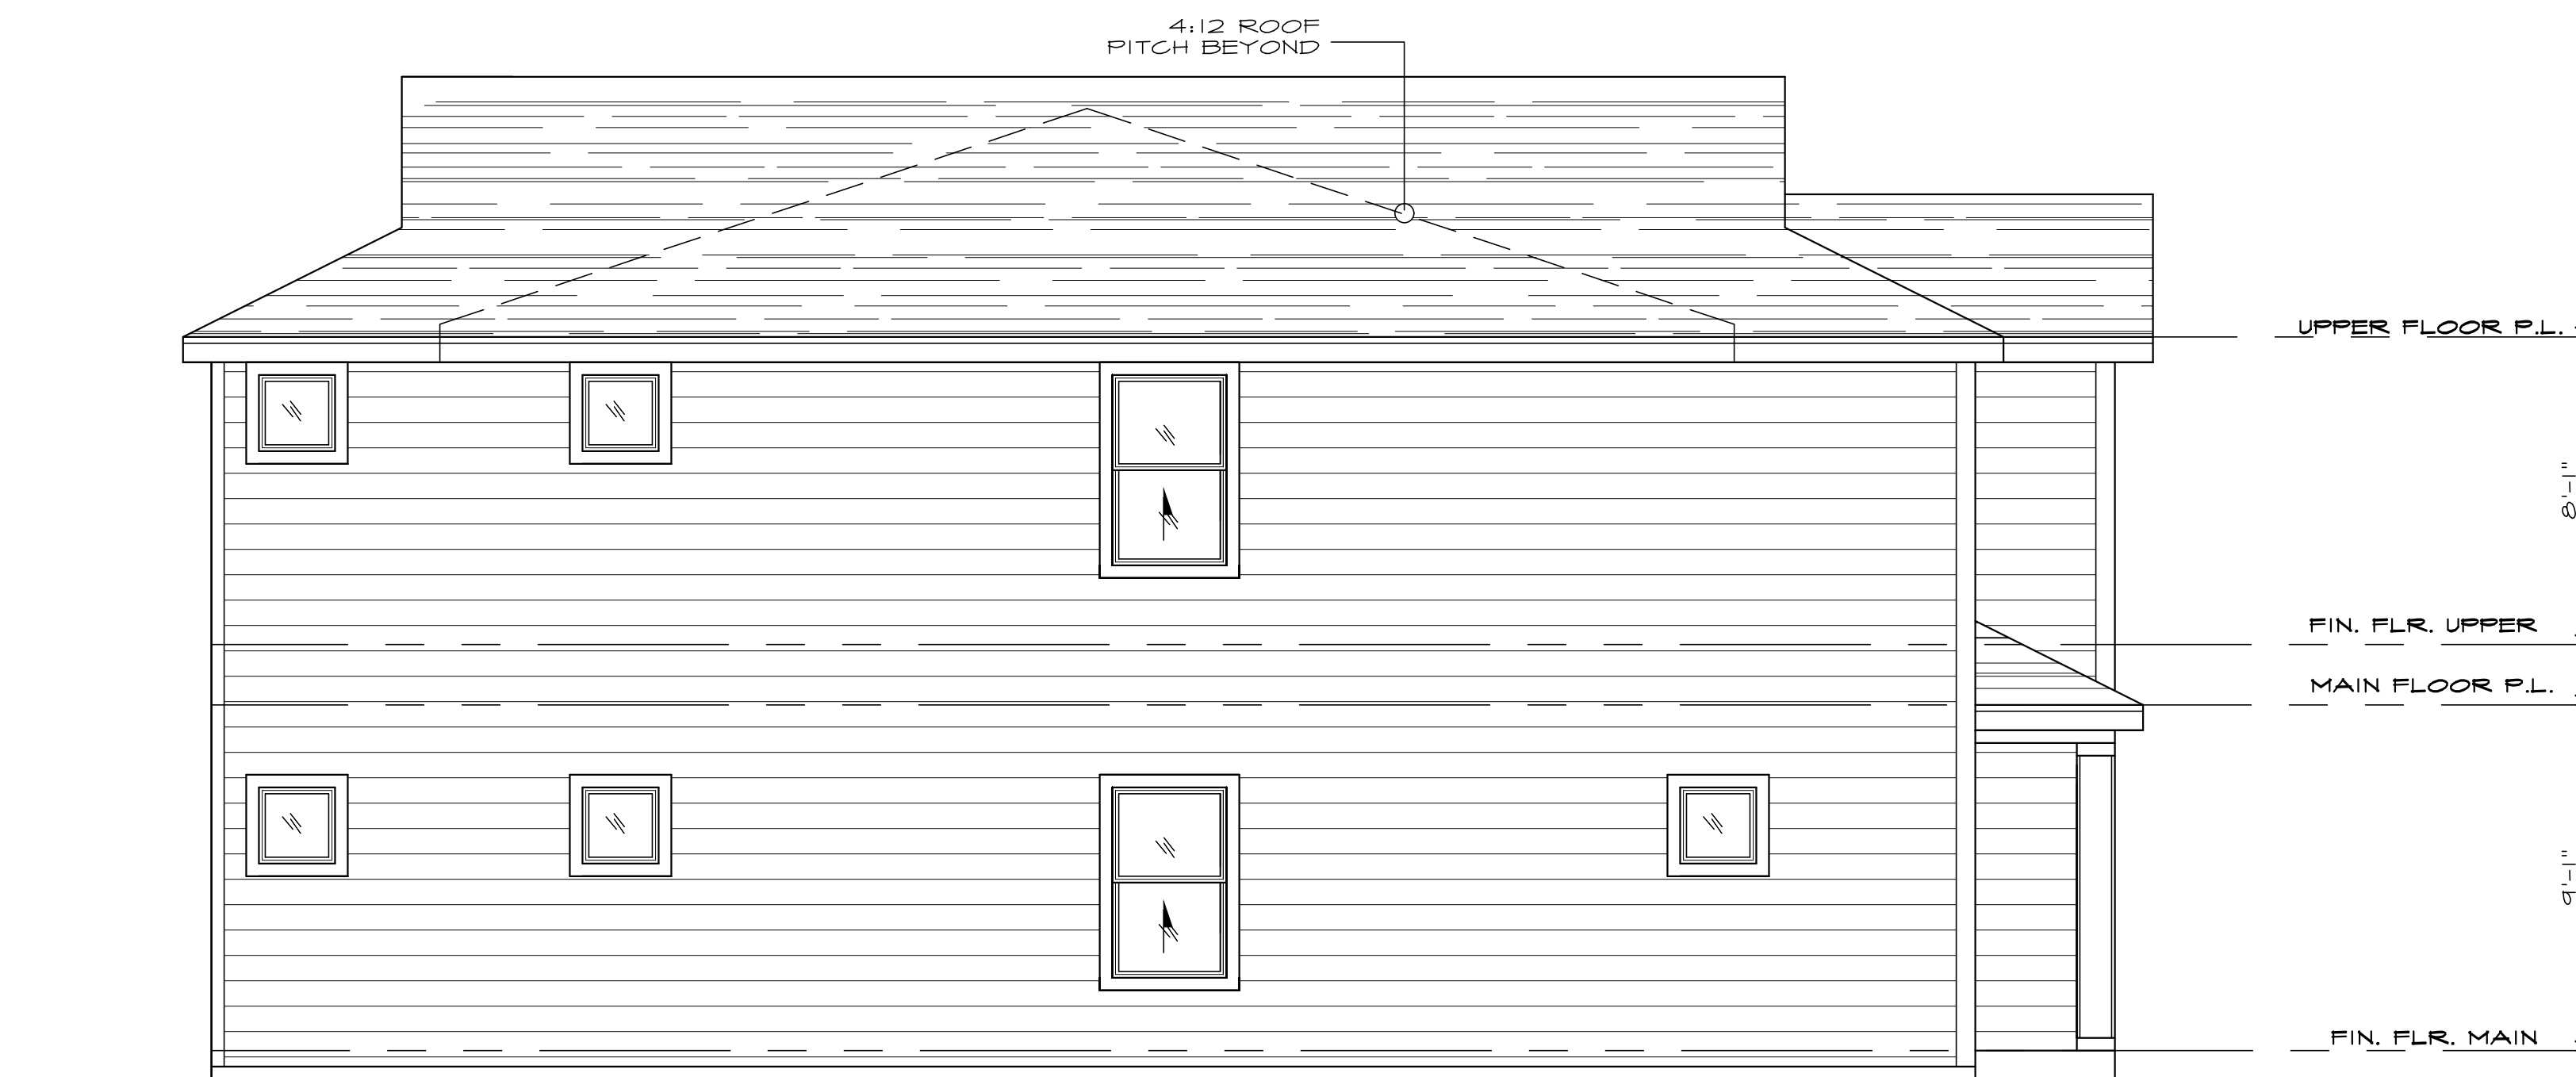
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A4
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RIGHT ELEVATION
SEE GENERAL NOTES SCALE: 1/4" = 1'-0"



LEFT ELEVATION
SEE GENERAL NOTES SCALE: 1/4" = 1'-0"



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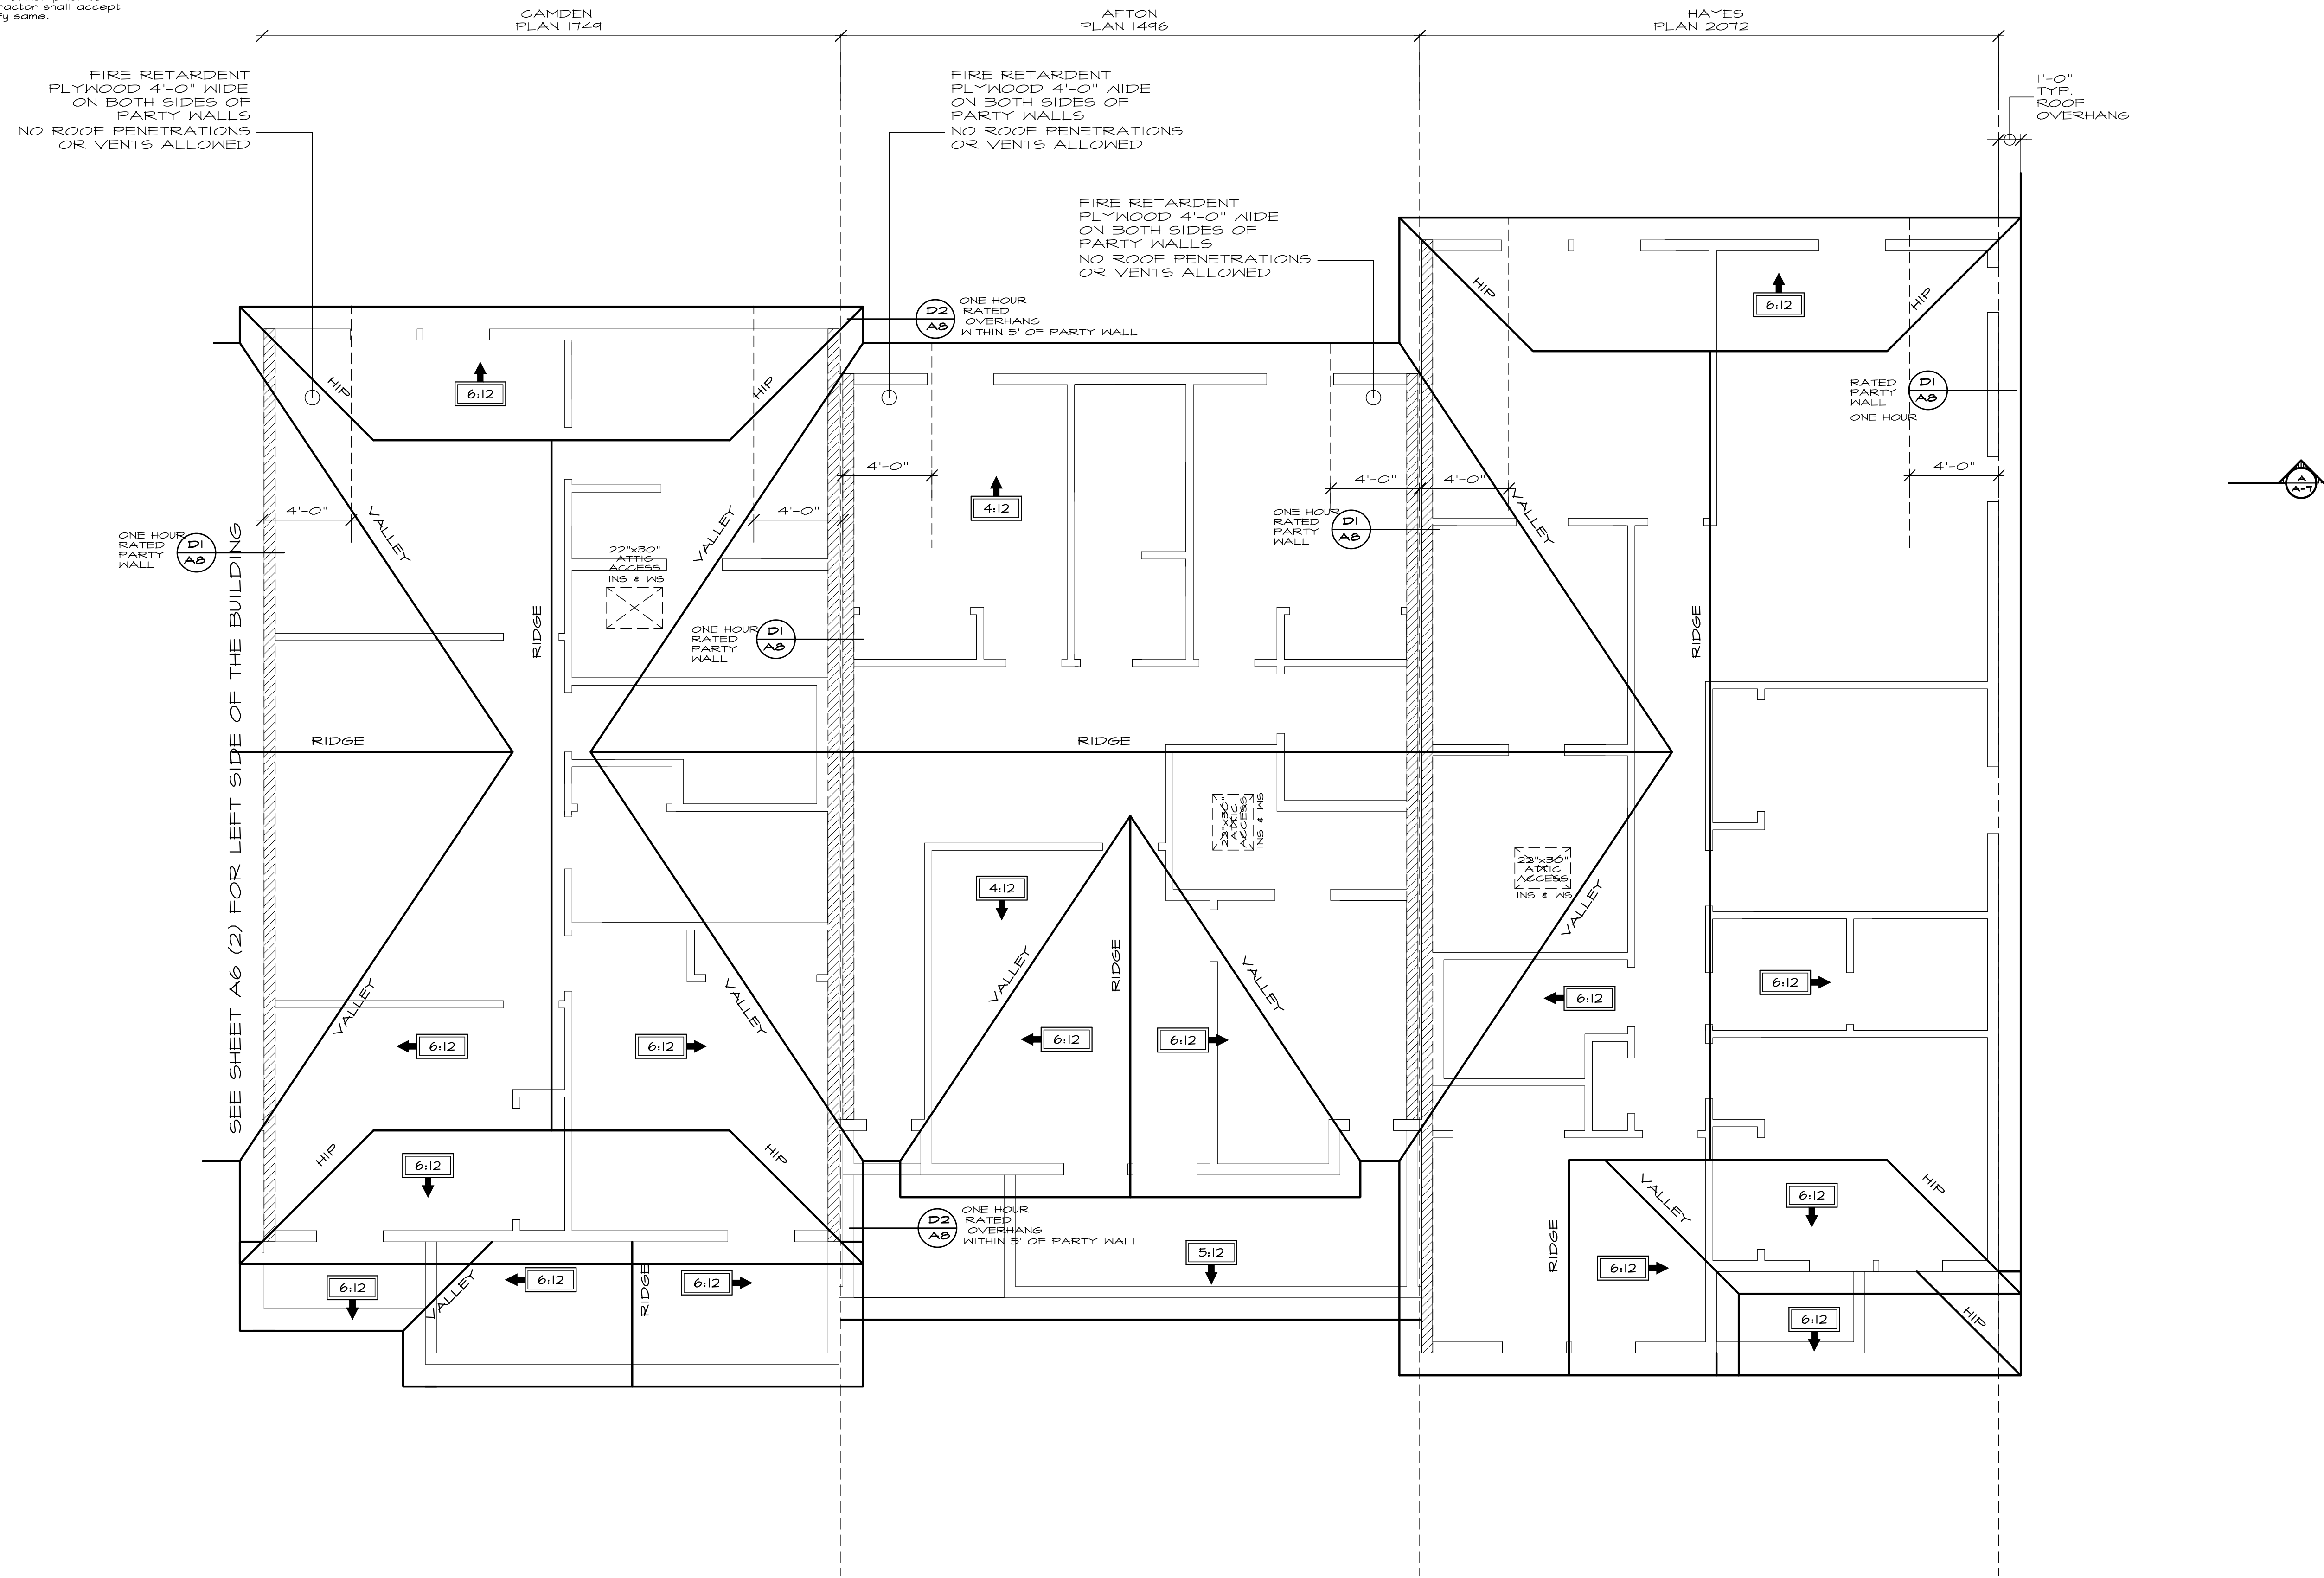
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A5

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ROOF FRAMING NOTES

CONNECTORS SHALL BE ENGINEERED BY TRUSS MANUFACTURER
 ROOF PITCH SHALL BE 6:12 TYPICAL UNLESS NOTED OTHERWISE
 ROOF OVERHANG SHALL BE 12" U.N.O. TRUSSES

PLAN 1496
 ROOF VENTING CALCULATION
 922 SQFT OF ATTIC
 1/150 MUST BE AT SOFFITS

PLAN 1749
 ROOF VENTING CALCULATION
 1066 SQFT OF ATTIC
 1/150 MUST BE AT SOFFITS

PLAN 2072
 ROOF VENTING CALCULATION
 1254 SQFT OF ATTIC
 1/150 MUST BE AT SOFFITS

ROOF PLAN
 SEE GENERAL NOTES

SCALE: 1/4" = 1'-0"



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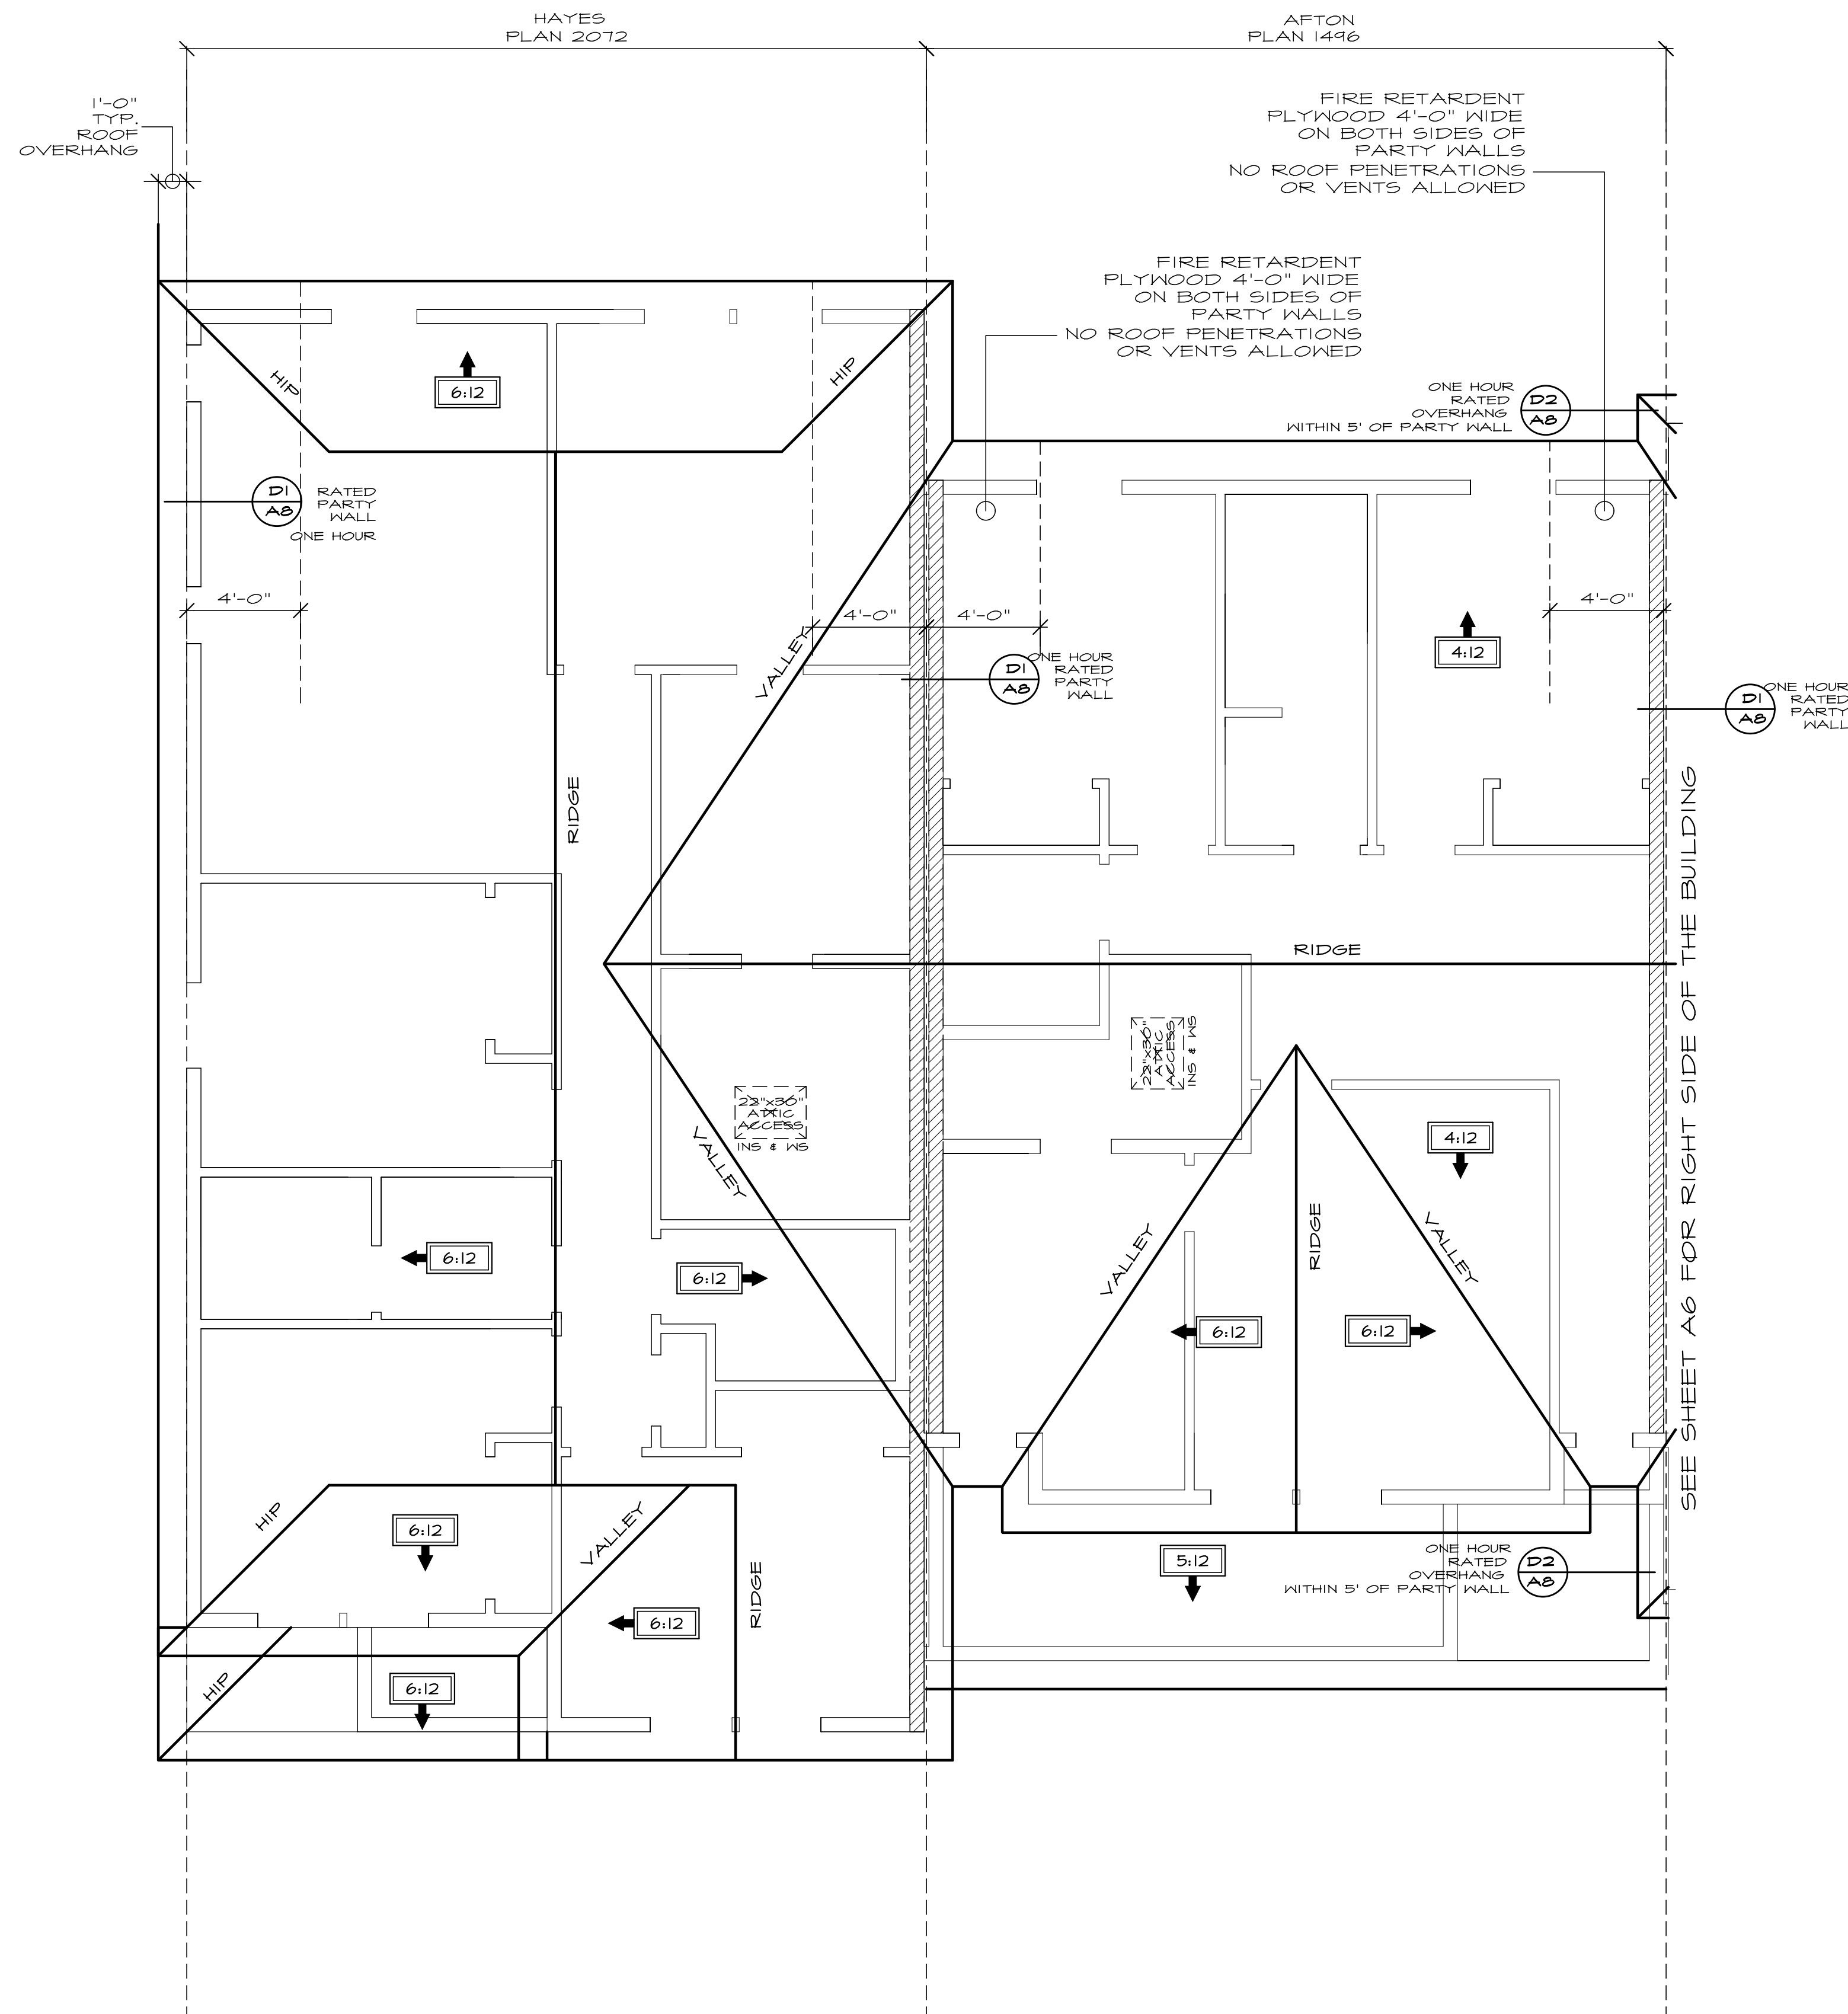
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A6

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PLAN 1496
ROOF VENTING CALCULATION

922 SQFT OF ATTIC
1/150 MUST BE AT SOFFITS

PLAN 1749
ROOF VENTING CALCULATION

1066 SQFT OF ATTIC
1/150 MUST BE AT SOFFITS

PLAN 2072
ROOF VENTING CALCULATION

1254 SQFT OF ATTIC
1/150 MUST BE AT SOFFITS

ROOF PLAN
SEE GENERAL NOTES

SCALE: 1/4" = 1'-0"



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**A6
(2)**

TYPICAL SECTION NOTES:


- ROOF CONSTRUCTION:**
 1. PRE-MANUFACTURED ROOF TRUSSES WITH 6" ENERGY HEEL, ENGINEERED BY OTHERS
 2. 1/150 ROOF VENT AT SOFFITS
 3. AIR CHUTE AT EACH TRUSS SPACE
 4. 7/16" OSB SHEATHING
 5. ICE AND WATER MEMBRANE APPLIED AT 24" PAST EXTERIOR WALL
 6. ROOFING AS SPECIFIED

- SOFFIT/FASCIA:**
 1. 2X6 SUB-FASCIA
 2. VINYL FASCIA
 3. VINYL VENTED SOFFITS

- WALL CONSTRUCTION:**
 1. HOUSE WRAP
 2. 2X6 STUDS @ 16" O.C. UNO
 3. WINDOWS AS SPECIFIED
 4. MIN R-15 FIBERGLASS BATT INSULATION
 5. 4 MIL POLY VAPOR BARRIER
 6. 1/2" GYPSUM WALL BOARD
 7. HOLD SILL PLATE OF EXTERIOR WALLS IN, SO THAT THE FACE OF SHEATHING ALIGNS WITH FACE OF THE FOUNDATION WALLS


- CEILING CONSTRUCTION:**
 1. R49 BLOWN IN INSULATION
 2. 1/2" SAG-RESISTANT GYPSUM WALL BOARD WITH VAPOR BARRIER

- SILL CONSTRUCTION:**
 1. INSTALL SILL SEAL FLUSH @ ALL EXTERIOR WALLS
 2. 2X TREATED SILL PLATE AND SEALER
 3. 1/2" ANCHOR BOLTS @ 72" O.C.

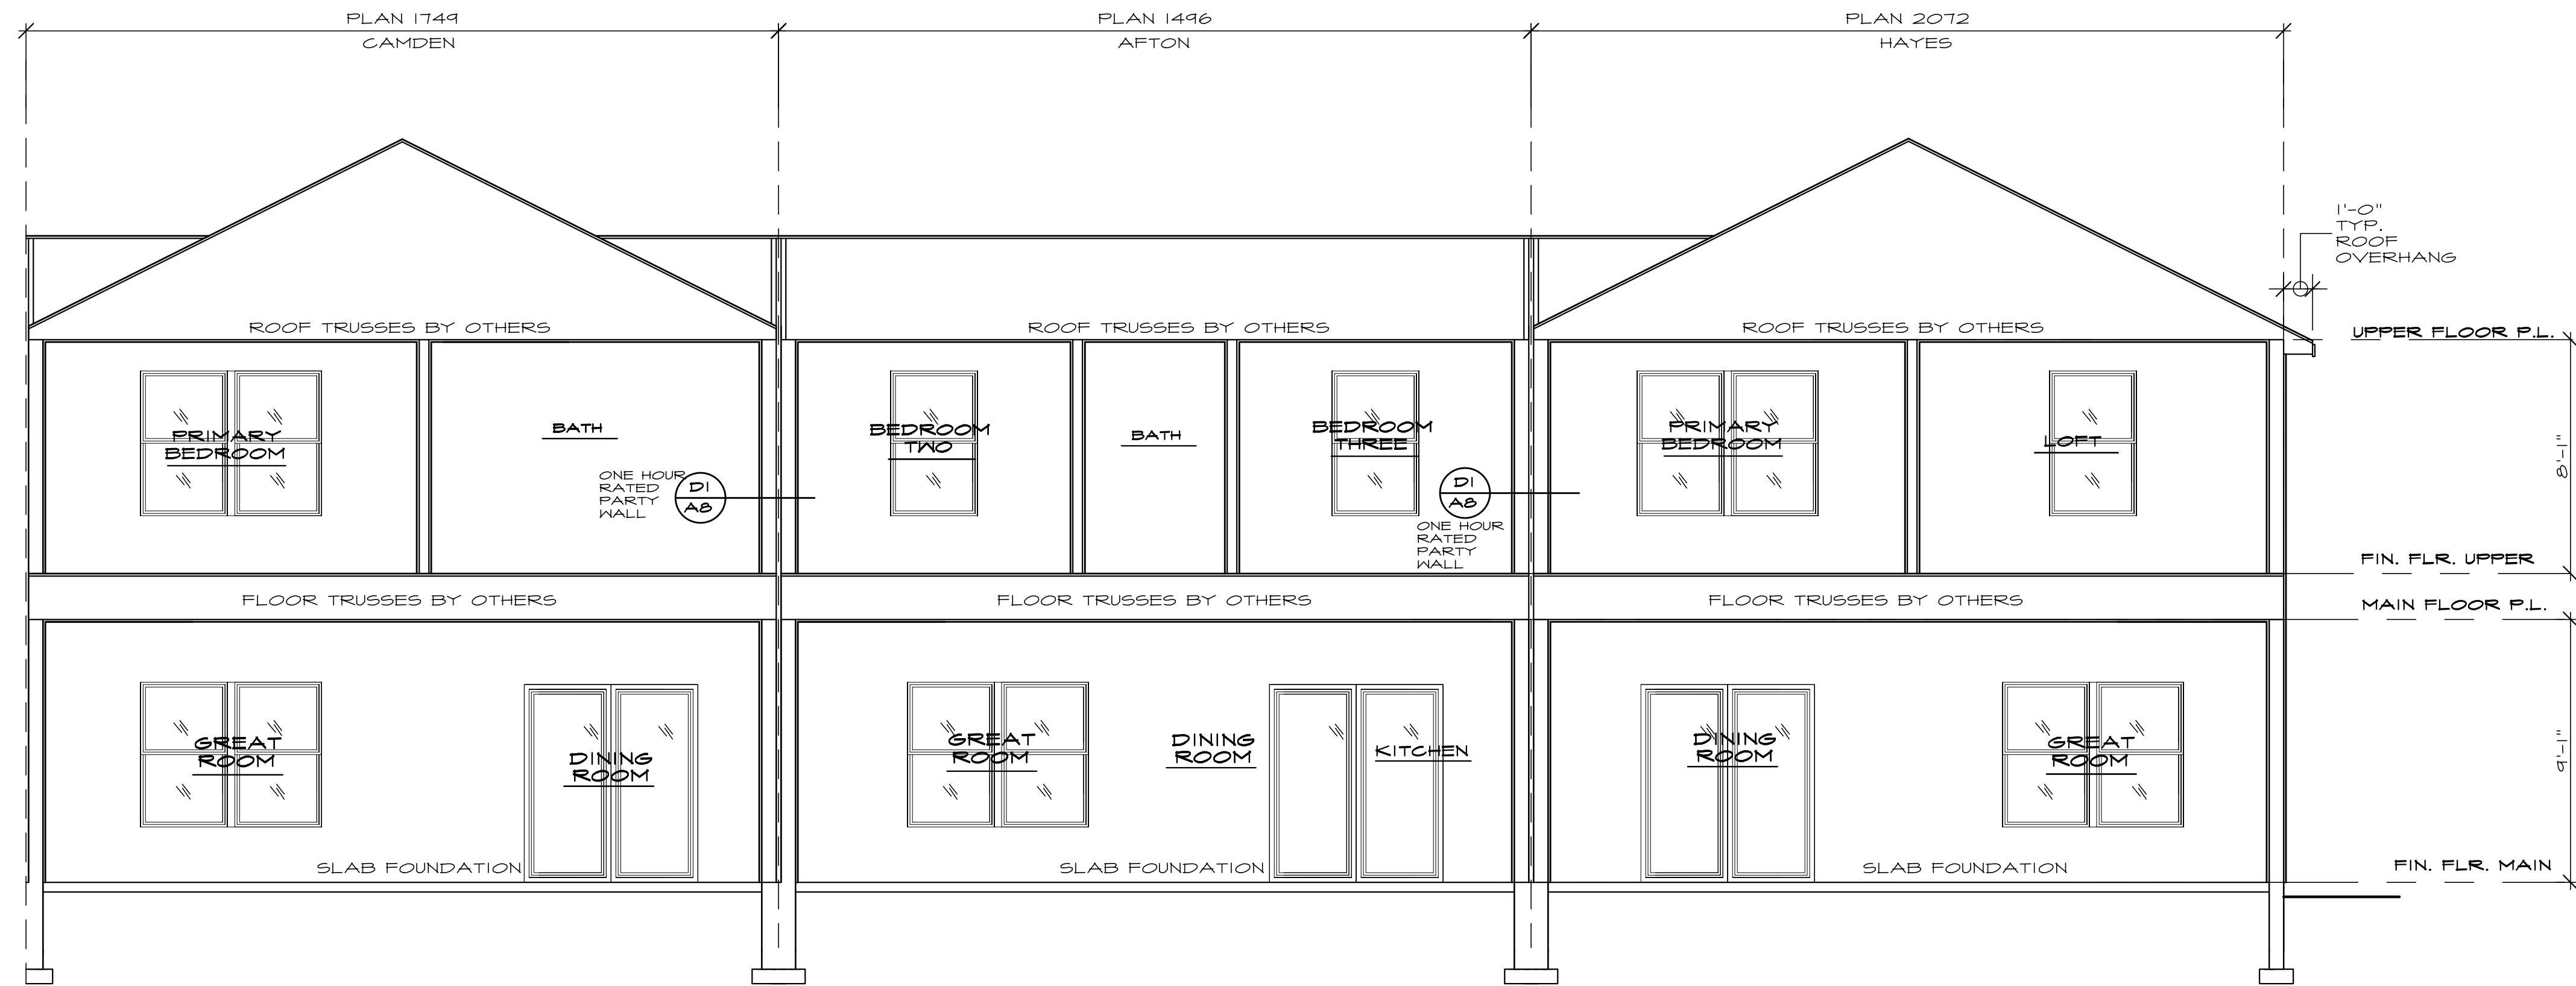

SECTION A-A

SEE GENERAL NOTES SCALE: 1/4" = 1'-0"

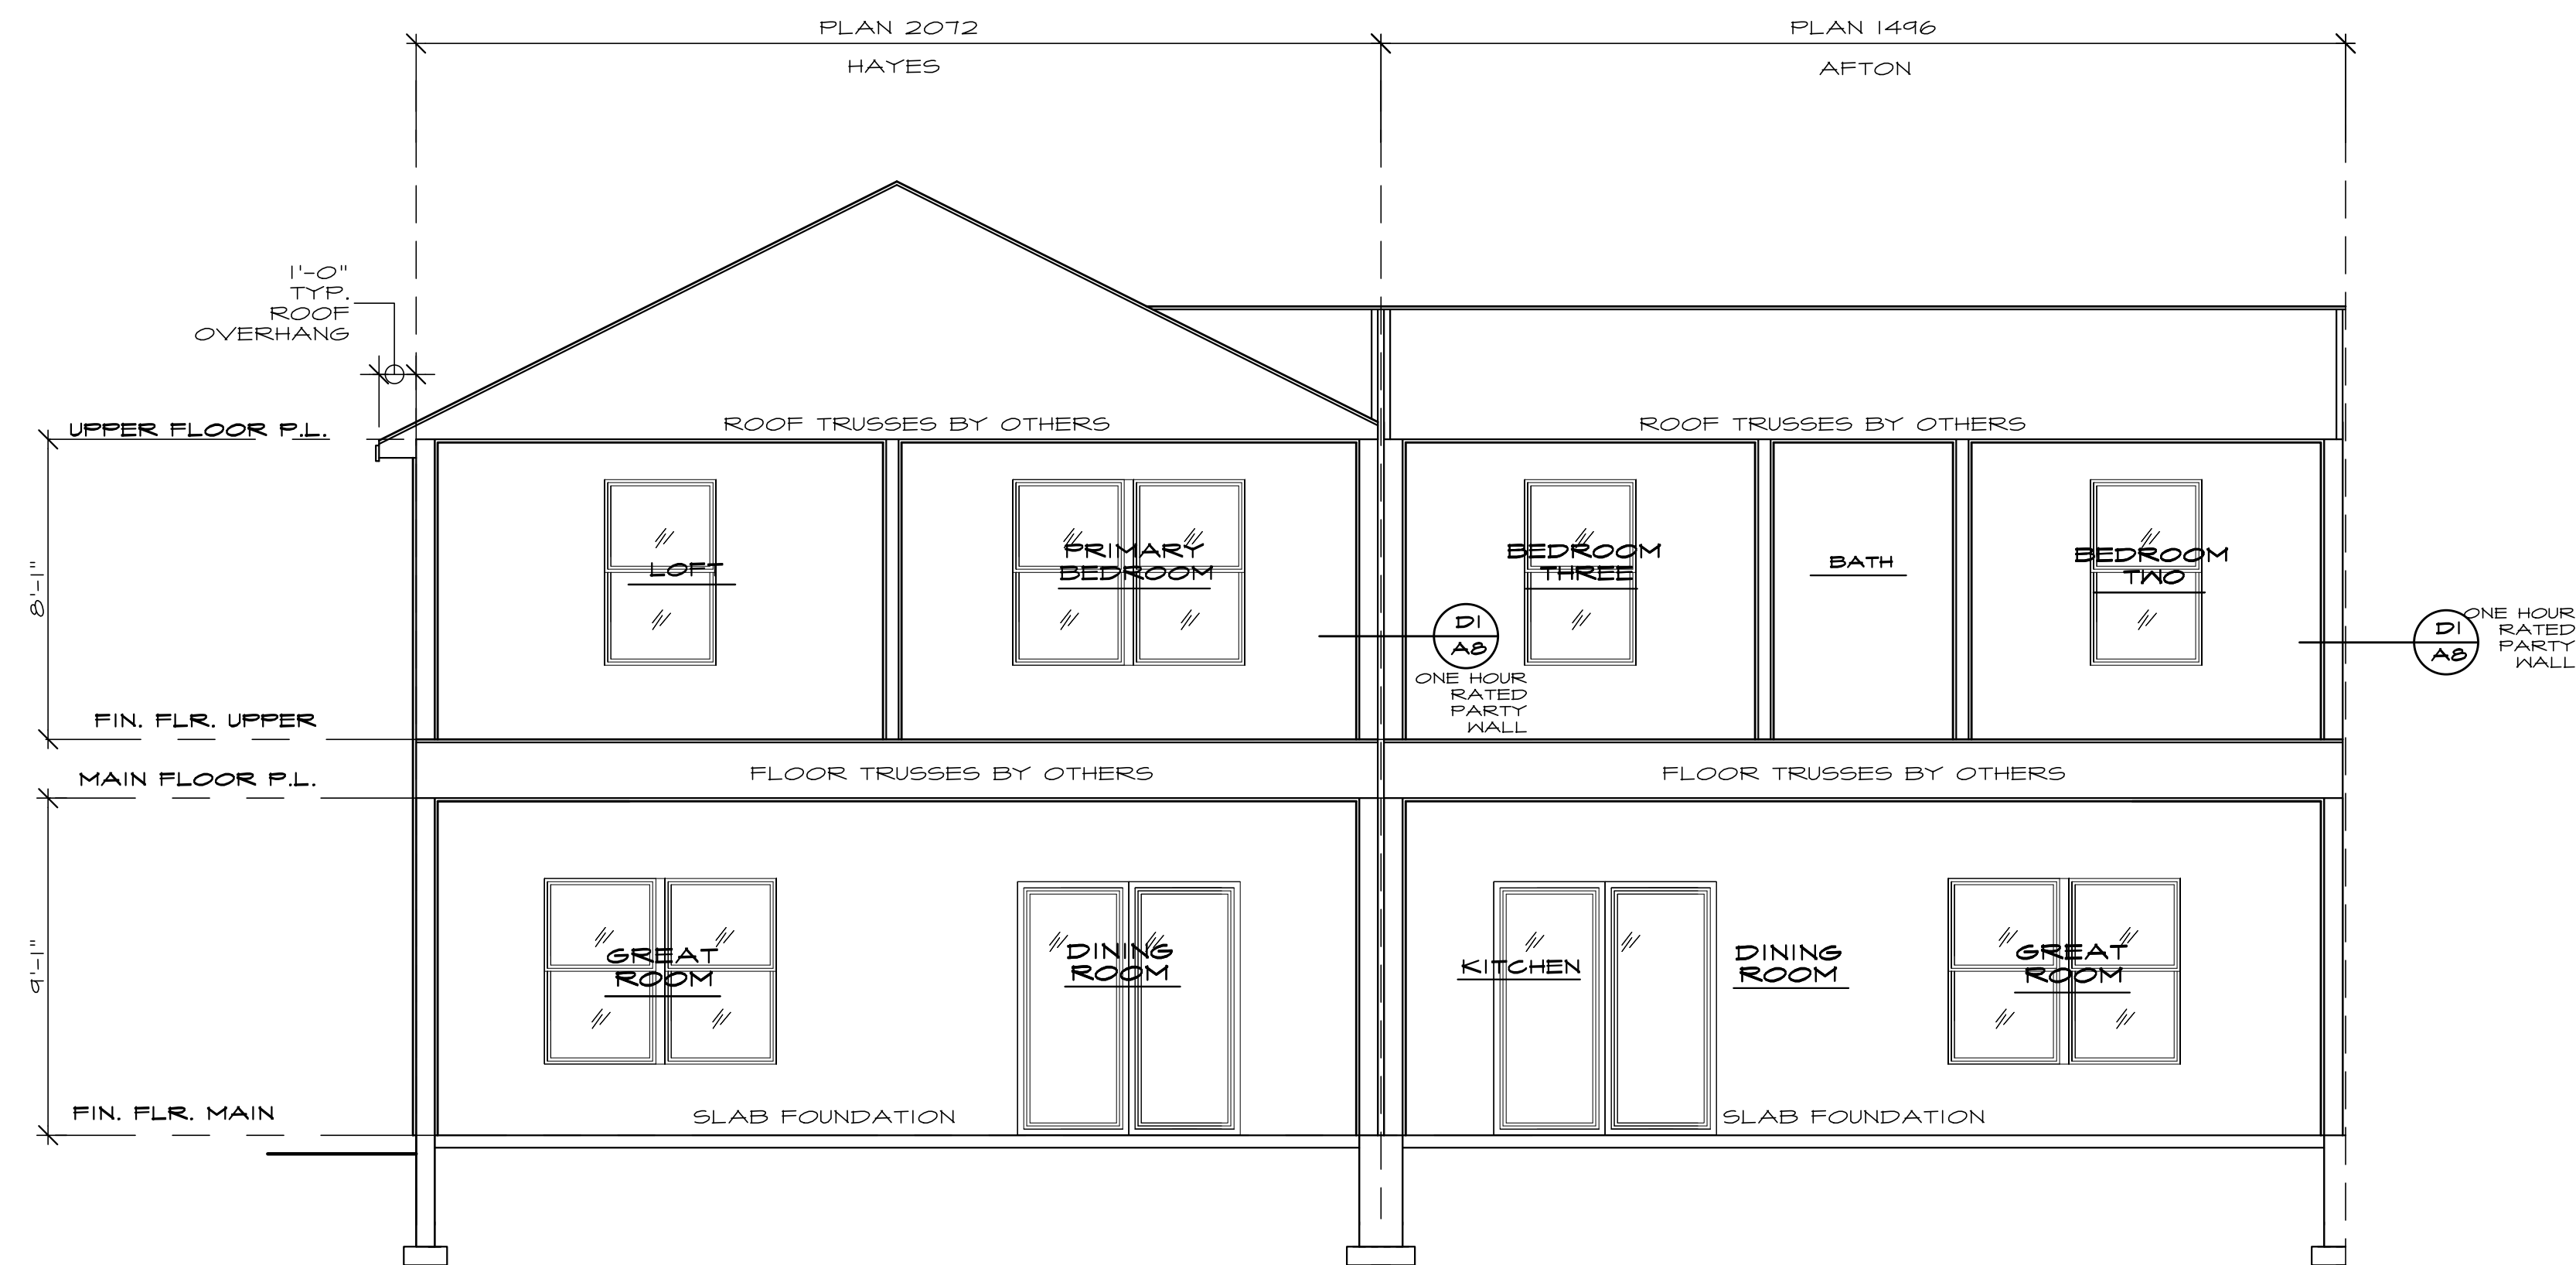

SECTION A-A

SEE GENERAL NOTES SCALE: 1/4" = 1'-0"



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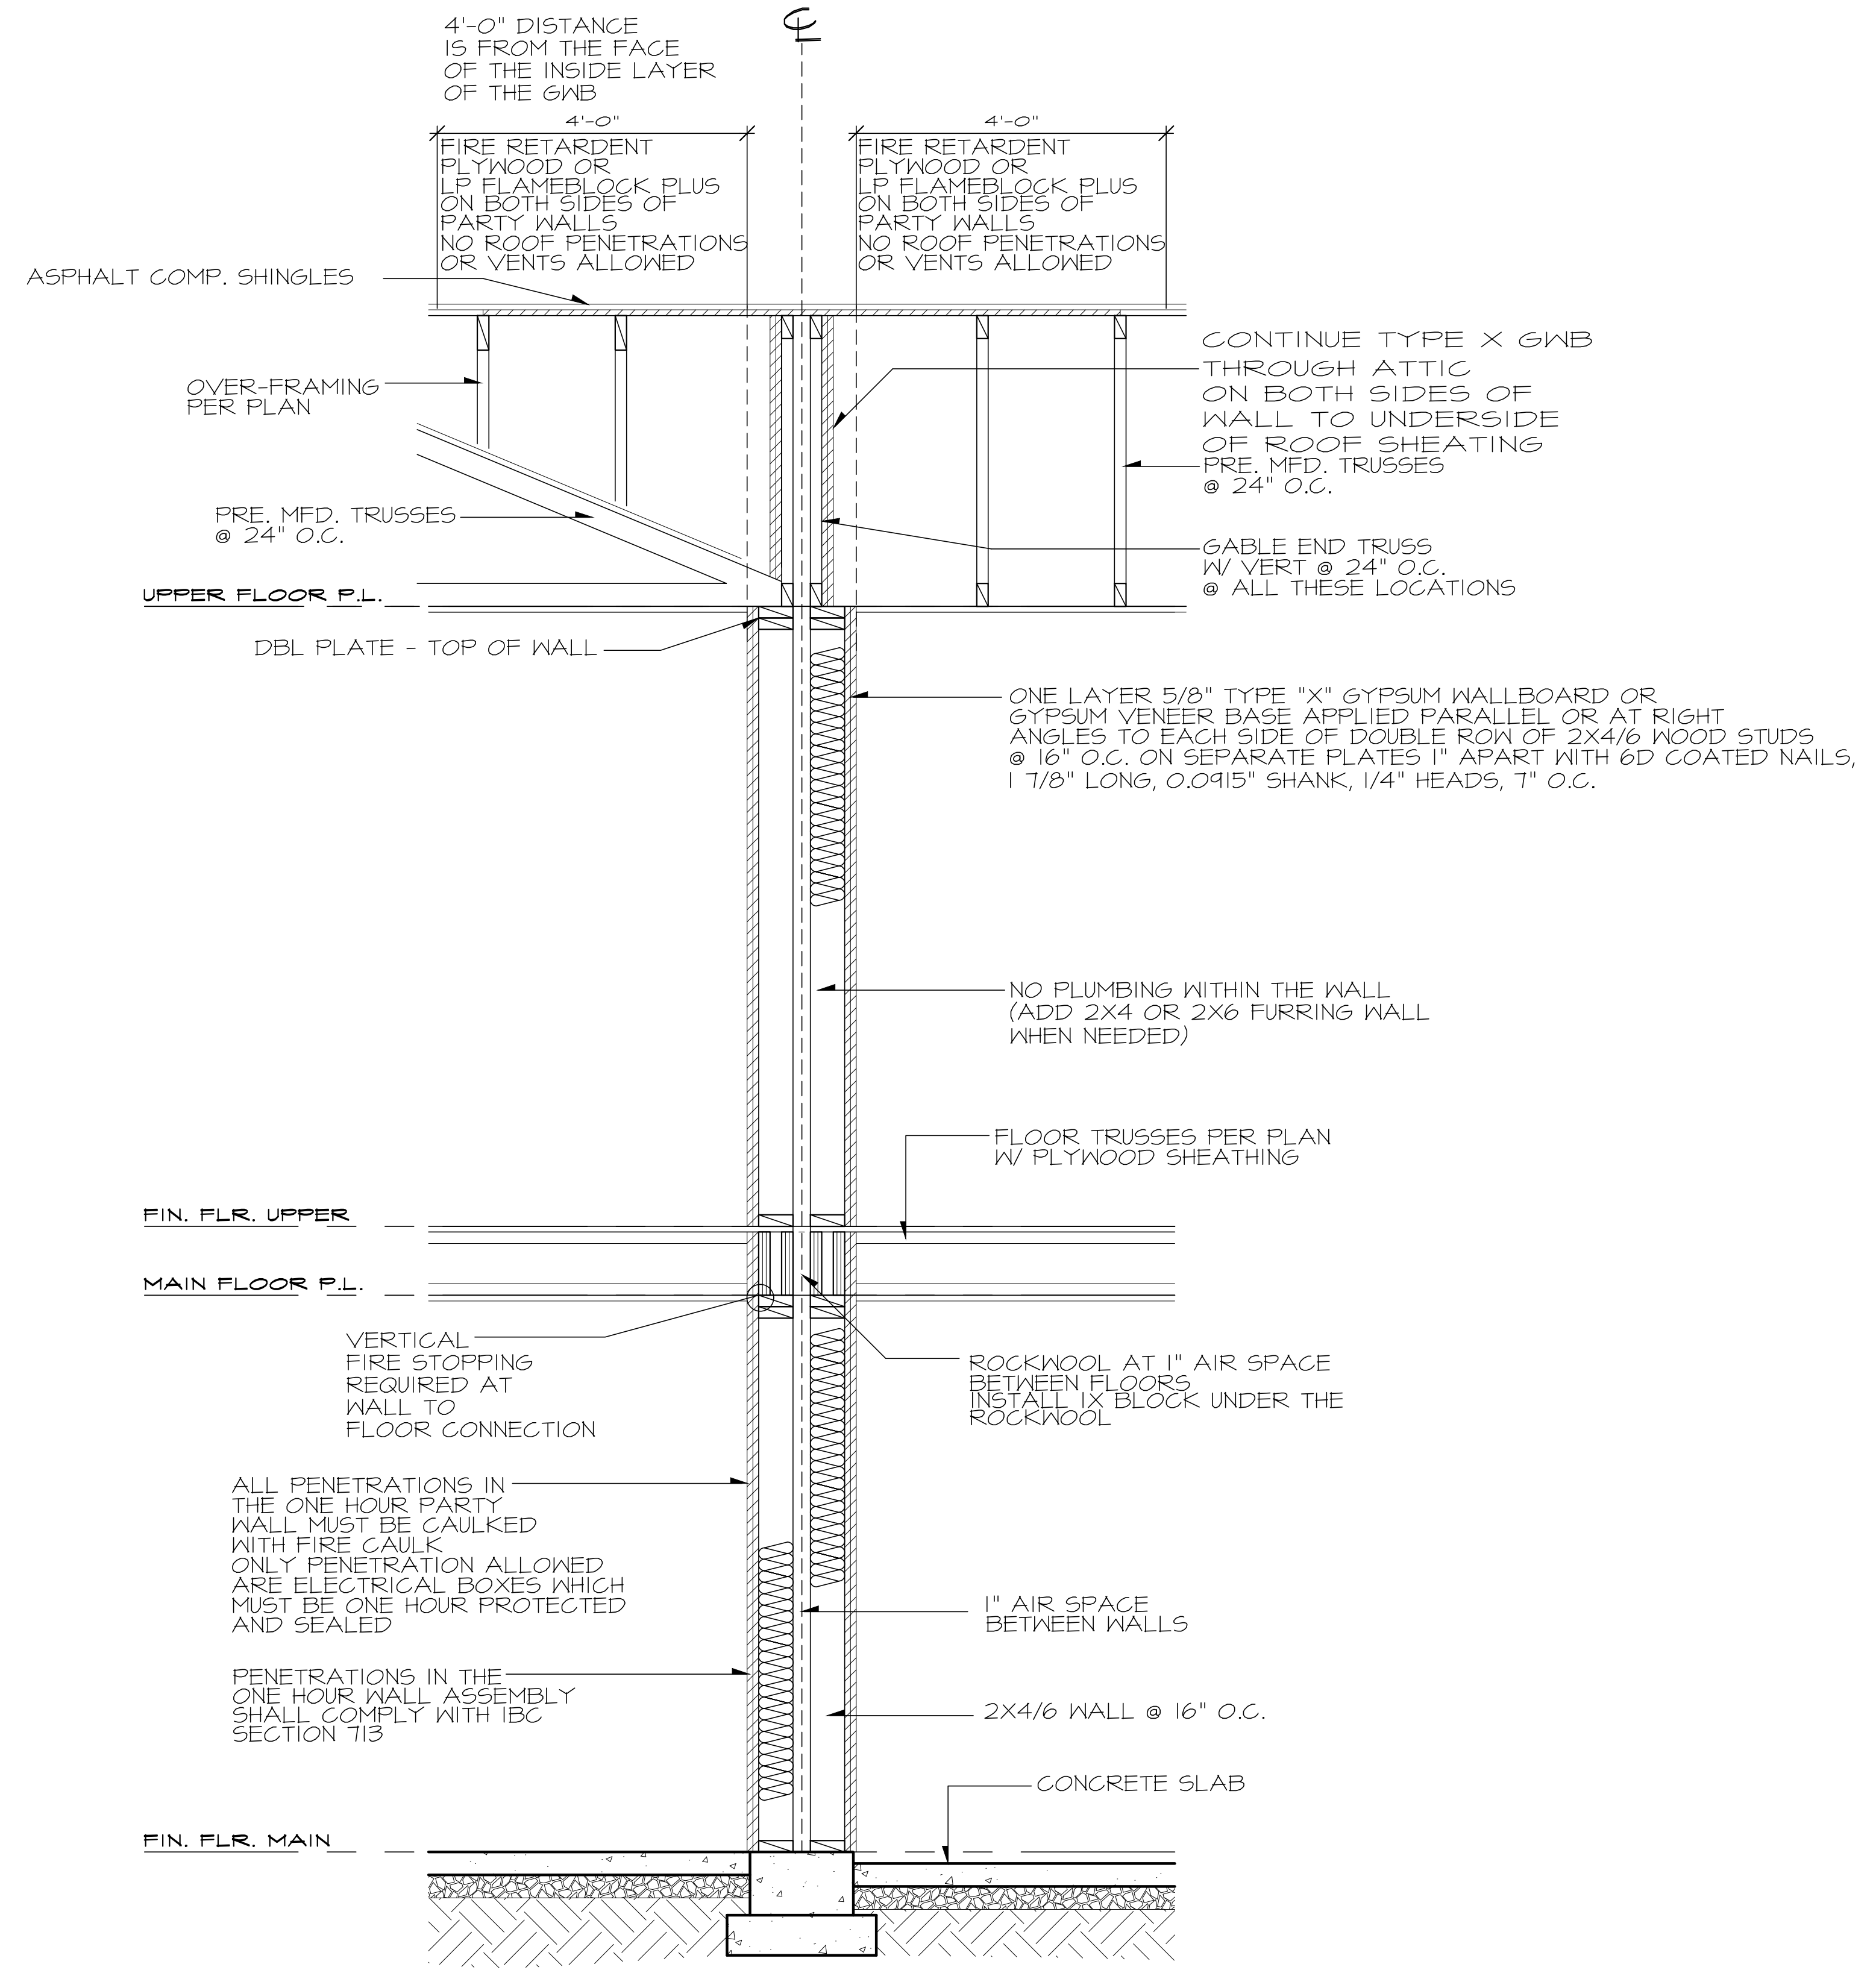
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A7



D1
A8

TYPICAL ONE HOUR PARTY WALLS/BUILDING SECTION


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NO SCALE

GA FILE NO. WP 3370
1 HOUR FIRE/45 TO 49 STC SOUND

FIRE TEST: SEE WP 3605
(UL R1319-4, 6, 6-17-52;
UL R2717-39, 1-20-66;
UL R3501-52, 3-15-66;
UL DESIGN U305;
ULC DESIGN W301);
UL R4024, 10-31-68

SOUND TEST: NRCC TL-43-261,
IRC-1R-761, 3/98

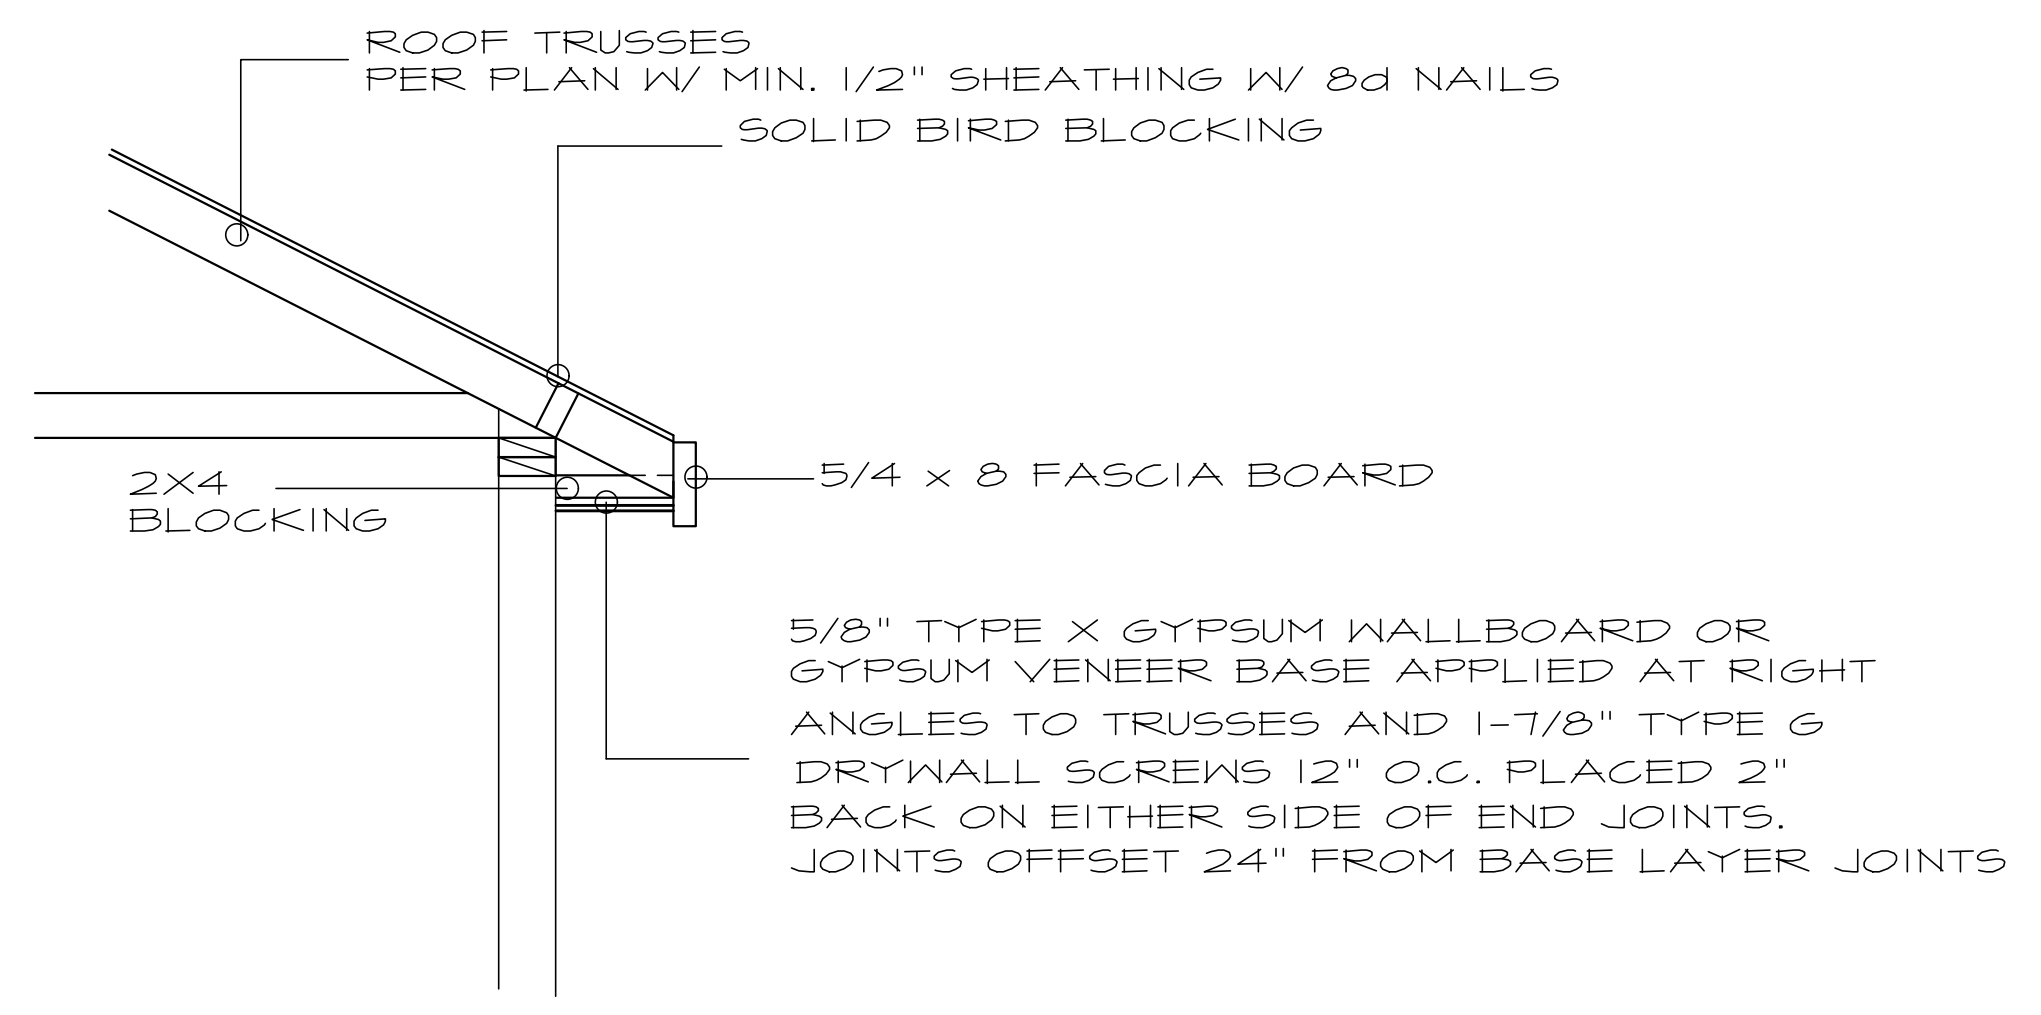

D2
A8

ONE HOUR RATED ROOF/CEILING/OVERHANG

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NO SCALE



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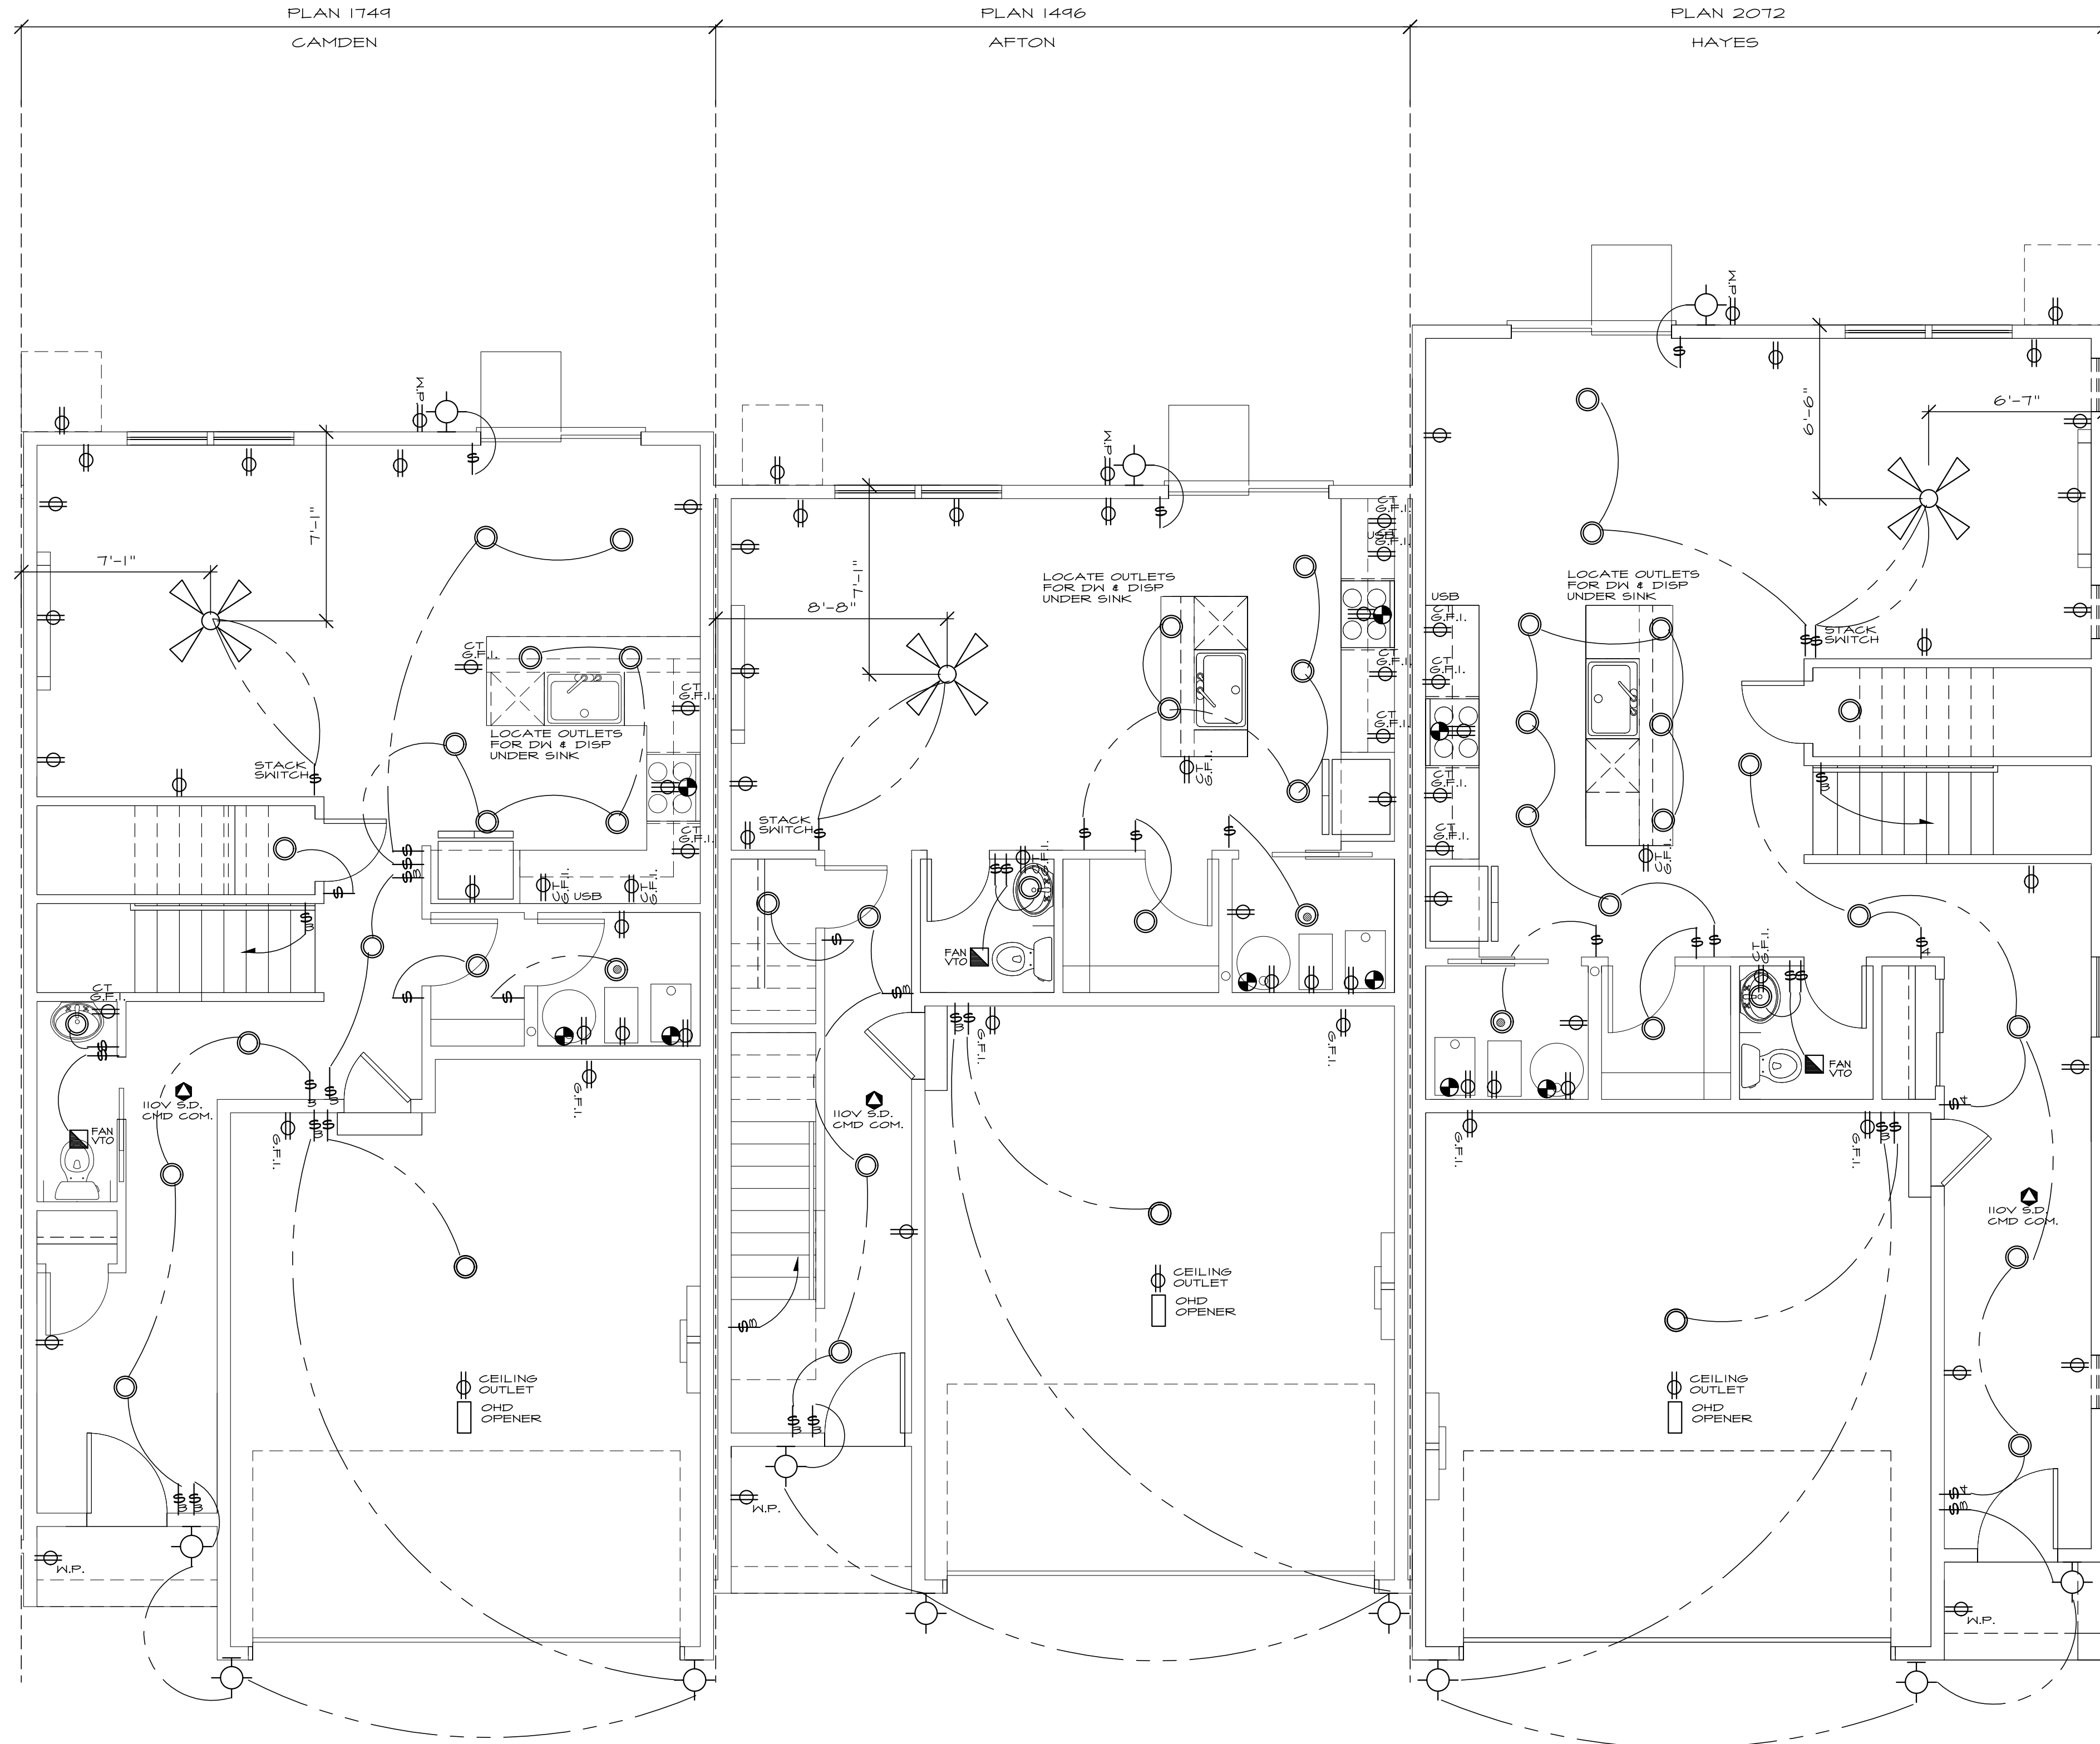
SHEET
A8

ELECTRICAL NOTES:

1. ALL DIMENSIONS FROM STUD FACE TO CENTER OF FIXTURE
2. CENTER OF ATTIC LIGHT SWITCH TO BE 6'-6" A.F.F. UNO
3. EXTERIOR PLUGS TO BE 24" FROM BOTTOM OF SIDING
4. ALL CLOSET LIGHTS TO BE 30" FROM WALL WITH SHELF
5. CENTER ALL LIGHT STRIPS 12" A.F.F. UNO
6. CENTER ALL RECEPTACLES 14" A.F.F. UNO
7. CENTER ALL SWITCHES 54" A.F.F. UNO
8. MOUNT T-STAT @ 60" A.F.F.
9. ALL BATH VANITY OUTLETS TO BE 8" AND 10" FROM BACK WALL AND MATCHED
10. PROVIDE KEYLESS PULL CHAIN LIGHT IN ATTIC AND 110V OUTLET FOR FUTURE RADON MITIGATION SYSTEM
11. ALL SMOKE DETECTORS TO BE INSTALLED A MINIMUM OF 36" FROM ANY SUPPLY OR RETURN AIR GRILLE
12. BLOCK ALL SECONDARY BEDROOMS FOR CEILING FANS
13. PROVIDE AFCI PROTECTION ON ALL BRANCH CIRCUITS AS REQUIRED PER APPLICABLE CODES.
14. GFCI PROTECTION TO INCLUDE THE 240 VOLT RECEPTACLES FOR RANGES THAT ARE WITHIN 6' FROM THE EDGE OF SINKS AND FOR 240 VOLT RECEPTACLES LOCATED IN LAUNDRY ROOMS
15. GFCI PROTECTION FOR ALL INDOOR WET OR DAMP LOCATIONS. THE AHJ SHALL DETERMINE WHAT DAMP OR WET LOCATIONS ARE.
16. GFCI PROTECTION FOR ALL EXTERIOR RECEPTACLES FOR 125 VOLT THROUGH 250 VOLT INCLUDING HVAC EQUIPMENT WHEN HARD WIRED.
17. ALL NEW DWELLINGS WILL REQUIRE A SURGE PROTECTOR DEVICE
18. PROVIDE AN EMERGENCY DISCONNECT AT A READILY ACCESSIBLE OUTDOOR LOCATION FOR OUTDOOR UNITS.
19. PROVIDE TAMPER RESISTANT OUTLETS IN GARAGES

ELECTRICAL LEGEND:

- 110 VOLT WALL CONVENIENCE OUTLET
- 110 VOLT WALL CONVENIENCE OUTLET WITH GROUND FAULT INTERRUPTOR
- 220 VOLT WALL CONVENIENCE OUTLET
- 110 VOLT WEATHERPROOF OUTLET WITH CAP
- 110 VOLT SPLIT WIRED CONVENIENCE OUTLET
- 110 VOLT WALL CONVENIENCE OUTLET W/ USB PORTS
- 110 OR 220 VOLT SPECIAL PURPOSE OUTLET
- LED PUCK LIGHT
- PENDANT LIGHT FIXTURE
- WALL MOUNTED LIGHT FIXTURE (OR SCONCE)
- CEILING FAN
- LIGHT BAR FIXTURE
- RECESSED LIGHT FIXTURE
- SURFACE MOUNTED STRIP FIXTURE
- SINGLE POLE SWITCH
- SINGLE POLE SWITCH WITH DIMMER DEVICE
- THREE WAY SWITCH
- FOUR WAY SWITCH
- 110 VOLT SMOKE DETECTOR INTERCONNECTED
- CABLE OUTLET
- COMPUTER CIRCUIT
- TELEPHONE, & T.V. CABLE
- TELEPHONE OUTLET
- C.F.M. FAN (VENT TO OUTSIDE)
- CHIMES
- DOORBELL
- THERMOSTAT
- FLOOD LIGHT
- GAS OUTLET
- HEAT DETECTOR



**ELECTRICAL
MAIN FLOOR PLAN**

SEE GENERAL NOTES SCALE: 1/4" = 1'-0"



2850 CUTTERS
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**RIVENICK VILLAGE
5 UNIT BUILDING
RAMSEY, MINNESOTA**

date: 01-04-24
permit:
revisions:

drawn by: MJM
checked by:

SHEET
AD


Written dimensions on this drawing shall have precedence over scaled dimensions. Contractor shall verify all dimensions, conditions, etc., pertaining to the work before proceeding. The Owner must be notified of any variations from the dimensions and/or conditions shown on these drawings. Any such variation shall be resolved by the Owner prior to proceeding with the work, or the Contractor shall accept full responsibility for the cost to rectify same.

ELECTRICAL NOTES:

1. ALL DIMENSIONS FROM STUD FACE TO CENTER OF FIXTURE
2. CENTER OF ATTIC LIGHT SWITCH TO BE 6'-6" A.F.F. UNO
3. EXTERIOR PLUGS TO BE 24" FROM BOTTOM OF SIDING
4. ALL CLOSET LIGHTS TO BE 30" FROM WALL WITH SHELF
5. CENTER ALL LIGHT STRIPS 42" A.F.F. UNO
6. CENTER ALL RECEPTACLES 14" A.F.F. UNO
7. CENTER ALL SWITCHES 54" A.F.F. UNO
8. MOUNT T-STAT @ 60" A.F.F.
9. ALL BATH VANITY OUTLETS TO BE 8" AND 10" FROM BACK WALL AND MATCHED
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**ELECTRICAL
UPPER FLOOR PLAN**
SEE GENERAL NOTES SCALE: 1/4" = 1'-0"



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drawn by: MNJ
checked by:

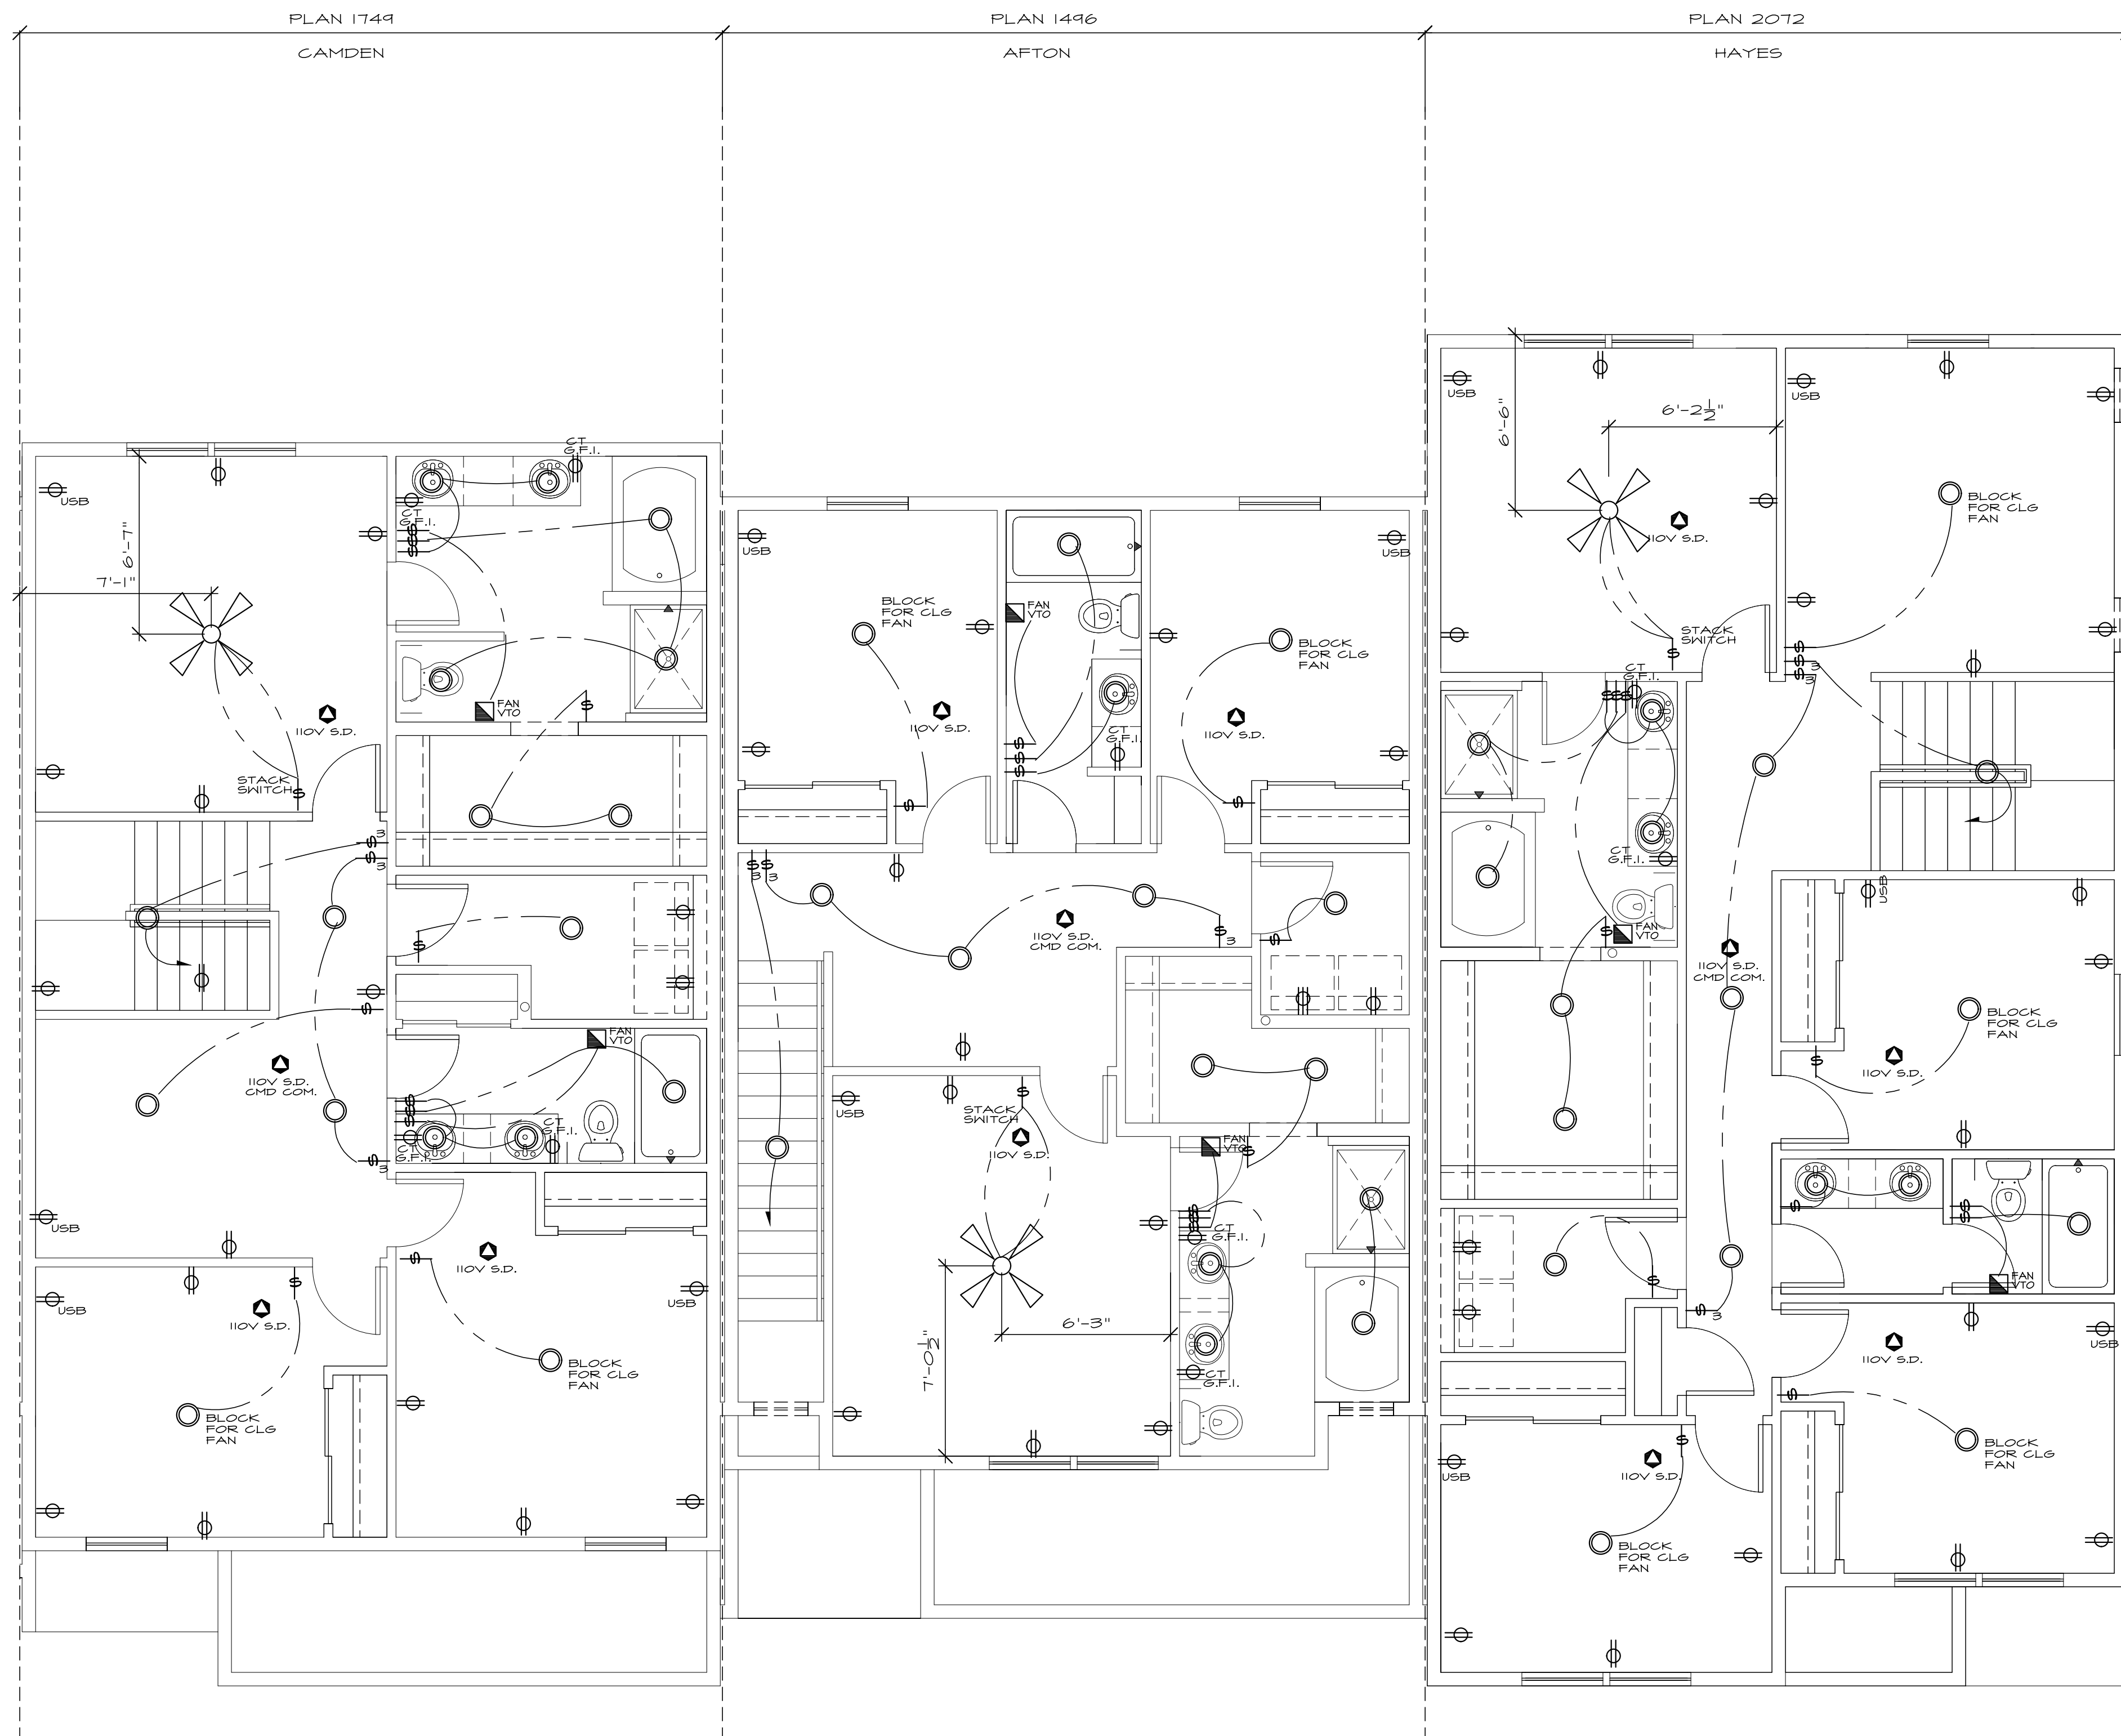SHEET
A10